

ABBREVIATIONS

A.B.	ANCHOR BOLT
A/C	AIR CONDITION
A.F.F.	ABOVE FINISHED FLOOR
APP	APPROVED
ARCH.	ARCHITECT
ARCH.	ARCHITECTURAL
BD.	BOARD
BLDG.	BUILDING
BLKG	BLOCKING
BM.	BEAM
B.O.	BY OWNER
BOT.	BOTTOM
B.O.W.	BASE OF WALL
B.U.	BUILT-UP
CL.	CENTERLINE
CLR.	CLEAR
CLG.	CEILING
COL.	COLUMN
CSK.	COUNTERSINK
COMP.	COMPOSITION
CONC.	CONCRETE
CONT.	CONTINUOUS
CONTR.	CONTRACTOR
CRC	COLD-ROLLED CHANNEL
C.T.	CERAMIC TILE
DBL.	DOUBLE
DET.	DETAIL
DWR.	DRAWER
DIM.	DIMENSION
(E)	EXISTING
EA.	EACH
ELEV.	ELEVATION
EQ.	EQUAL
EXH.	EXHAUST
EXP.	EXPANSION
EXT.	EXTERIOR
F.A.	FLOOR AREA
F.D.	FLOOR DRAIN
FDN.	FOUNDATION
F.G.	FIXED GLAZING
FIN.	FINISH
FL/FLR.	FLOOR
FLUOR.	FLUORESCENT
F.O.	FACE OF
FTG.	FOOTING
GA.	GAUGE
GALV.	GALVANIZED
G.B.	GYPSON BOARD
G.I.	GALVANIZED IRON
GLB.	GLUE-LAMINATED BEAM
GFRG.	GLASS FIBER REINFORCED GYPSUM
GSM.	GALVANIZED SHEET METAL
H.B.	HOSE BIB
H.C.	HOLLOW CORE
H.D.	HOLDDOWN
HDR.	HEADER
HT.	HEIGHT
INCL.	INCLUDE(D)
INSUL.	INSULATION
INT.	INTERIOR
JT.	JOIST
JT.	JOINT
L.H.	LEFT HAND
L.H.R.	LEFT HAND REVERSE
LS.	LANDSCAPE
LI.	LIGHT
LI.	LANDLORD IMPROVEMENTS
MAX.	MAXIMUM
M.B.	MACHINE BOLT
MECH.	MECHANICAL
MEMB.	MEMBRANE
MTL.	METAL
MFR.	MANUFACTURER
MIN.	MINIMUM
MTD.	MOUNTED
(N)	NEW
N.I.C.	NOT IN CONTRACT
N.T.S.	NOT TO SCALE
O.A.	OVERALL
O.C.	ON CENTER
OP.	OPERABLE
OPG.	OPENING
OPP.	OPPOSITE
PL.	PLATE
P-LAM.	PLASTIC LAMINATE
PLY.	PLYWOOD
PROP.	PROPERTY
P.T.	PRESSURE-TREATED
R.	RISER
(R)	RE-LOCATE(D)
R.D.	ROOF DRAIN
REC.	RECESSED
REG.	REGISTER
REINF.	REINFORCED
REQD.	REQUIRED
REV.	REVERSE
R.H.	RIGHT HAND
R.H.R.	RIGHT HAND REVERSE
RWD.	REDWOOD
R.W.L.	RAINWATER LEADER
S.C.	SOLID CORE
S.D.	SMOKE DETECTOR
SHTG.	SHEATHING
SIM.	SIMILAR
SQ.	SQUARE
S.S.D.	SEE STRUCTURAL DRAWINGS
T.	TREAD
T&G.	TONGUE & GROOVE
TBD.	TO BE DETERMINED
TEMP.	TEMPERED
THK.	THICK
TI.	TENANT IMPROVEMENTS
T.O.C.	TOP OF CURB
T.O.W.	TOP OF WALL
TYP.	TYPICAL
U.O.N.	UNLESS OTHERWISE NOTED
UHMW.	ULTRA HIGH MOLECULAR WEIGHT POLY-ETHYLENE
W.	WITH
W.C.	WATER CLOSET
W.H.	WATERHEATER
W.P.	WATERPROOF
W.W.M.	WELDED WIRE MESH
WN.	WINDOW
WO.	WITHOUT
WD.	WOOD

FIRE DEPARTMENT NOTES


- EXIT SIGNS, EMERGENCY LIGHTING, FIRE EXTINGUISHERS, FIRE DEPARTMENT LOCK BOX AND ADDRESS POSTING LOCATIONS TO BE FIELD VERIFIED BY FIRE INSPECTOR. FIRE DEPARTMENT ACCESS TO THE SITE, THE BUILDING, AND TO ALL FIRE PROTECTION SYSTEMS SHALL BE MAINTAINED AT ALL TIMES, IN ACCORDANCE WITH CFC CHAPTER 5.
- EXTERIOR DOORS AND OPENINGS REQUIRED BY THIS CODE OR THE INTERNATIONAL BUILDING CODE SHALL BE MAINTAINED READILY ACCESSIBLE FOR EMERGENCY ACCESS BY THE FIRE DEPARTMENT; AN APPROVED ACCESS WALKWAY LEADING FROM FIRE APPARATUS ACCESS ROADS TO EXTERIOR OPENINGS SHALL BE PROVIDED WHEN REQUIRED BY THE FIRE CODE OFFICIAL. CFC SEC. 504
- CONSTRUCTION SITE FIRE SAFETY: ALL CONSTRUCTION SITES MUST COMPLY WITH APPLICABLE PROVISIONS OF THE CFC CHAPTER 33 AND SANTA CLARA COUNTY FIRE STANDARD DETAIL AND SPECIFICATION SI-7. CFC CHP. 33.

GENERAL NOTES

- EXISTING CONSTRUCTION DATA HAS BEEN OBTAINED IN THE FIELD BY VISUAL MEANS ONLY. DIMENSIONS AND EXISTING CONDITIONS SHALL BE CHECKED AND VERIFIED ON THE JOB SITE BY EACH CONTRACTOR. ERRORS, OMISSIONS, OR DISCREPANCIES SHALL BE REPORTED TO THE ARCHITECT BEFORE WORK BEGINS OR SUPPLIES ARE ORDERED.
- SEE ARCHITECTURAL DRAWINGS FOR LAYOUT DIMENSIONS UNLESS INDICATED OTHERWISE.
- ALL DISCREPANCIES BETWEEN DRAWINGS SHALL BE CLARIFIED WITH THE ARCHITECT PRIOR TO PROCEEDING WITH WORK.
- IN THE EVENT THAT CERTAIN FEATURES OF THE CONSTRUCTION ARE NOT FULLY SHOWN OR DETAILED ON THE DRAWINGS OR CALLED FOR IN THE GENERAL NOTES, THEN THEIR CONSTRUCTION SHALL BE OF THE SAME CHARACTER AS SIMILAR CONDITIONS THAT ARE SHOWN OR CALLED FOR.
- REPAIR, REPLACEMENT AND/OR PATCHING IN EXISTING AREAS ARE TO MATCH SUBSTRATE AND ADJACENT FINISH.
- VERIFY ELECTRICAL, MECHANICAL AND FIRE ALARM REQUIREMENTS BEFORE CONSTRUCTION BEGINS.
- WORK SHALL BE PERFORMED IN CONFORMANCE WITH STATE & FEDERAL CODES. LAWS AND REGULATIONS APPLICABLE TO THIS WORK INCLUDE SPECIFICALLY BUT ARE NOT LIMITED TO CBC 2019 AS WELL AS CAL GREEN 2019 MANDATORY MEASURES. VOLUNTARY CAL GREEN MEASURES ARE ENCOURAGED AND WORKSHEETS FOR CONFORMANCE ARE AVAILABLE FROM ARCHITECT.
- ALL DIMENSIONS ARE TO FACE OF FINISH, FACE OF CONCRETE, TO CENTERLINES OF COLUMNS AND OTHER GRID POINTS, & TO CENTERLINES OF DOORS AND OTHER SCHEDULED OPENINGS UNLESS OTHERWISE NOTED.
- OFFSET STUDS WHERE REQUIRED TO ALIGN WITH FINISH MATERIAL.
- WHERE UL, GA OR UBC CONSTRUCTION ASSEMBLIES ARE DESIGNATED, THE COMPONENTS AND INSTALL DETAILS MUST CONFORM IN EVERY PARTICULAR WITH THE DESIGN NUMBER SPECIFIED.
- CEILING HEIGHTS ARE MEASURED TO BOTTOM OF FINISH CEILING.
- IN CEILINGS, LOCATE PENETRATING ITEMS (FIXTURES, SPRINKLERS, ETC.) IN PATTERNS SHOWN ON REFLECTED CEILING PLANS. IF NOT SHOWN, REQUEST CLARIFICATION FROM ARCHITECT BEFORE PROCEEDING.
- G.C. TO PROVIDE & COORDINATE ACCESS DOOR LOCATIONS (FOR CONCEALED ITEMS) WITH APPROPRIATE CONTRACTOR AND REVIEW WITH ARCHITECT PRIOR TO INSTALLATION.
- DEFERRED SUBMITTALS SHALL FIRST BE SUBMITTED TO THE PROJECT ARCHITECT AND/OR ENGINEER FOR REVIEW AND COORDINATION; FOLLOWING THE COMPLETION OF PROJECT, ARCHITECT/ENGINEER REVIEW AND COORDINATION, WHICH SHALL INCLUDE A LETTER STATING THIS REVIEW AND COORDINATION HAS BEEN PERFORMED AND COMPLETED AND PLANS AND CALCULATIONS FOR THE DEFERRED ITEMS ARE FOUND TO BE ACCEPTABLE (EG WITH REGARD TO GEOMETRY, LOAD CONDITIONS, ETC.) WITH NO EXCEPTIONS.
- THIS BUILDING SHALL BE EQUIPPED WITH AN APPROVED MANUAL AND AUTOMATIC FIRE ALARM SYSTEM PER FIRE CODE AND CALIFORNIA ELECTRICAL CODE - SEE FIRE DWG. FOR INFO.
- RATED WALLS AND CEILINGS SHALL NOT BE PENETRATED WITH PLASTIC PIPE OR BOXES (EXCEPT UL FIRE BOXES MAY BE USED PER NEC 300-21, CBC 709.710).
- ANY ITEM OR WORK NOT NOTED AS "EXISTING" (E) SHALL BE NEW.
- ALL WORK TO BE DONE IN CONFORMANCE WITH ALL GOVERNING CODES WHETHER INDICATED ON THE DRAWINGS OR NOT.
- THE CONTRACTOR SHALL LEAVE THE JOB BROOM CLEAN AT THE END OF EACH DAY'S WORK.
- THE CONTRACTOR SHALL LEAVE THE JOB BROOM CLEAN, WINDOWS AND FIXTURES WASHED AND DEBRIS REMOVED FROM THE JOB SITE AT THE COMPLETION OF THE PROJECT.
- ALL MANUFACTURED ITEMS SHALL BE INSTALLED PER MANUFACTURER'S SPECIFICATION AND RECOMMENDATIONS UNLESS OTHERWISE NOTED.
- PRIOR TO FINAL ACCEPTANCE, ALL SYSTEMS, EQUIPMENT, APPARATUS AND APPLIANCES SHALL OPERATE SAFELY AND SATISFACTORILY AS THE DESIGN INTENDED.
- CONTRACTOR TO PROVIDE OWNER WITH A HARD COVERED (3-RING, ETC.) BINDER OWNER'S MANUAL THAT SHALL INCLUDE MANUFACTURER'S INFORMATION, WARRANTIES, DIRECTIONS, ETC., ON ALL MECHANICAL ELEMENTS OF THE PROJECT.
- SHOP DRAWINGS SHALL BE PROVIDED FOR REVIEW AND FINAL APPROVAL BY THE OWNER AND ARCHITECT FOR DOORS, WINDOWS AND CABINETS.
- CUT SHEETS OR SAMPLES SHALL BE PROVIDED FOR REVIEW AND FINAL APPROVAL BY THE OWNER AND ARCHITECT FOR ALL EQUIPMENT, LIGHTING FIXTURES, PLUMBING FIXTURES, HARDWARE AND FINISH MATERIALS THROUGHOUT THE PROJECT.
- ALL INTERIOR FINISHES SHALL COMPLY WITH 2019 CBC TABLE 803.11.

LOCATION/ ASSESSOR'S MAP

N.T.S.

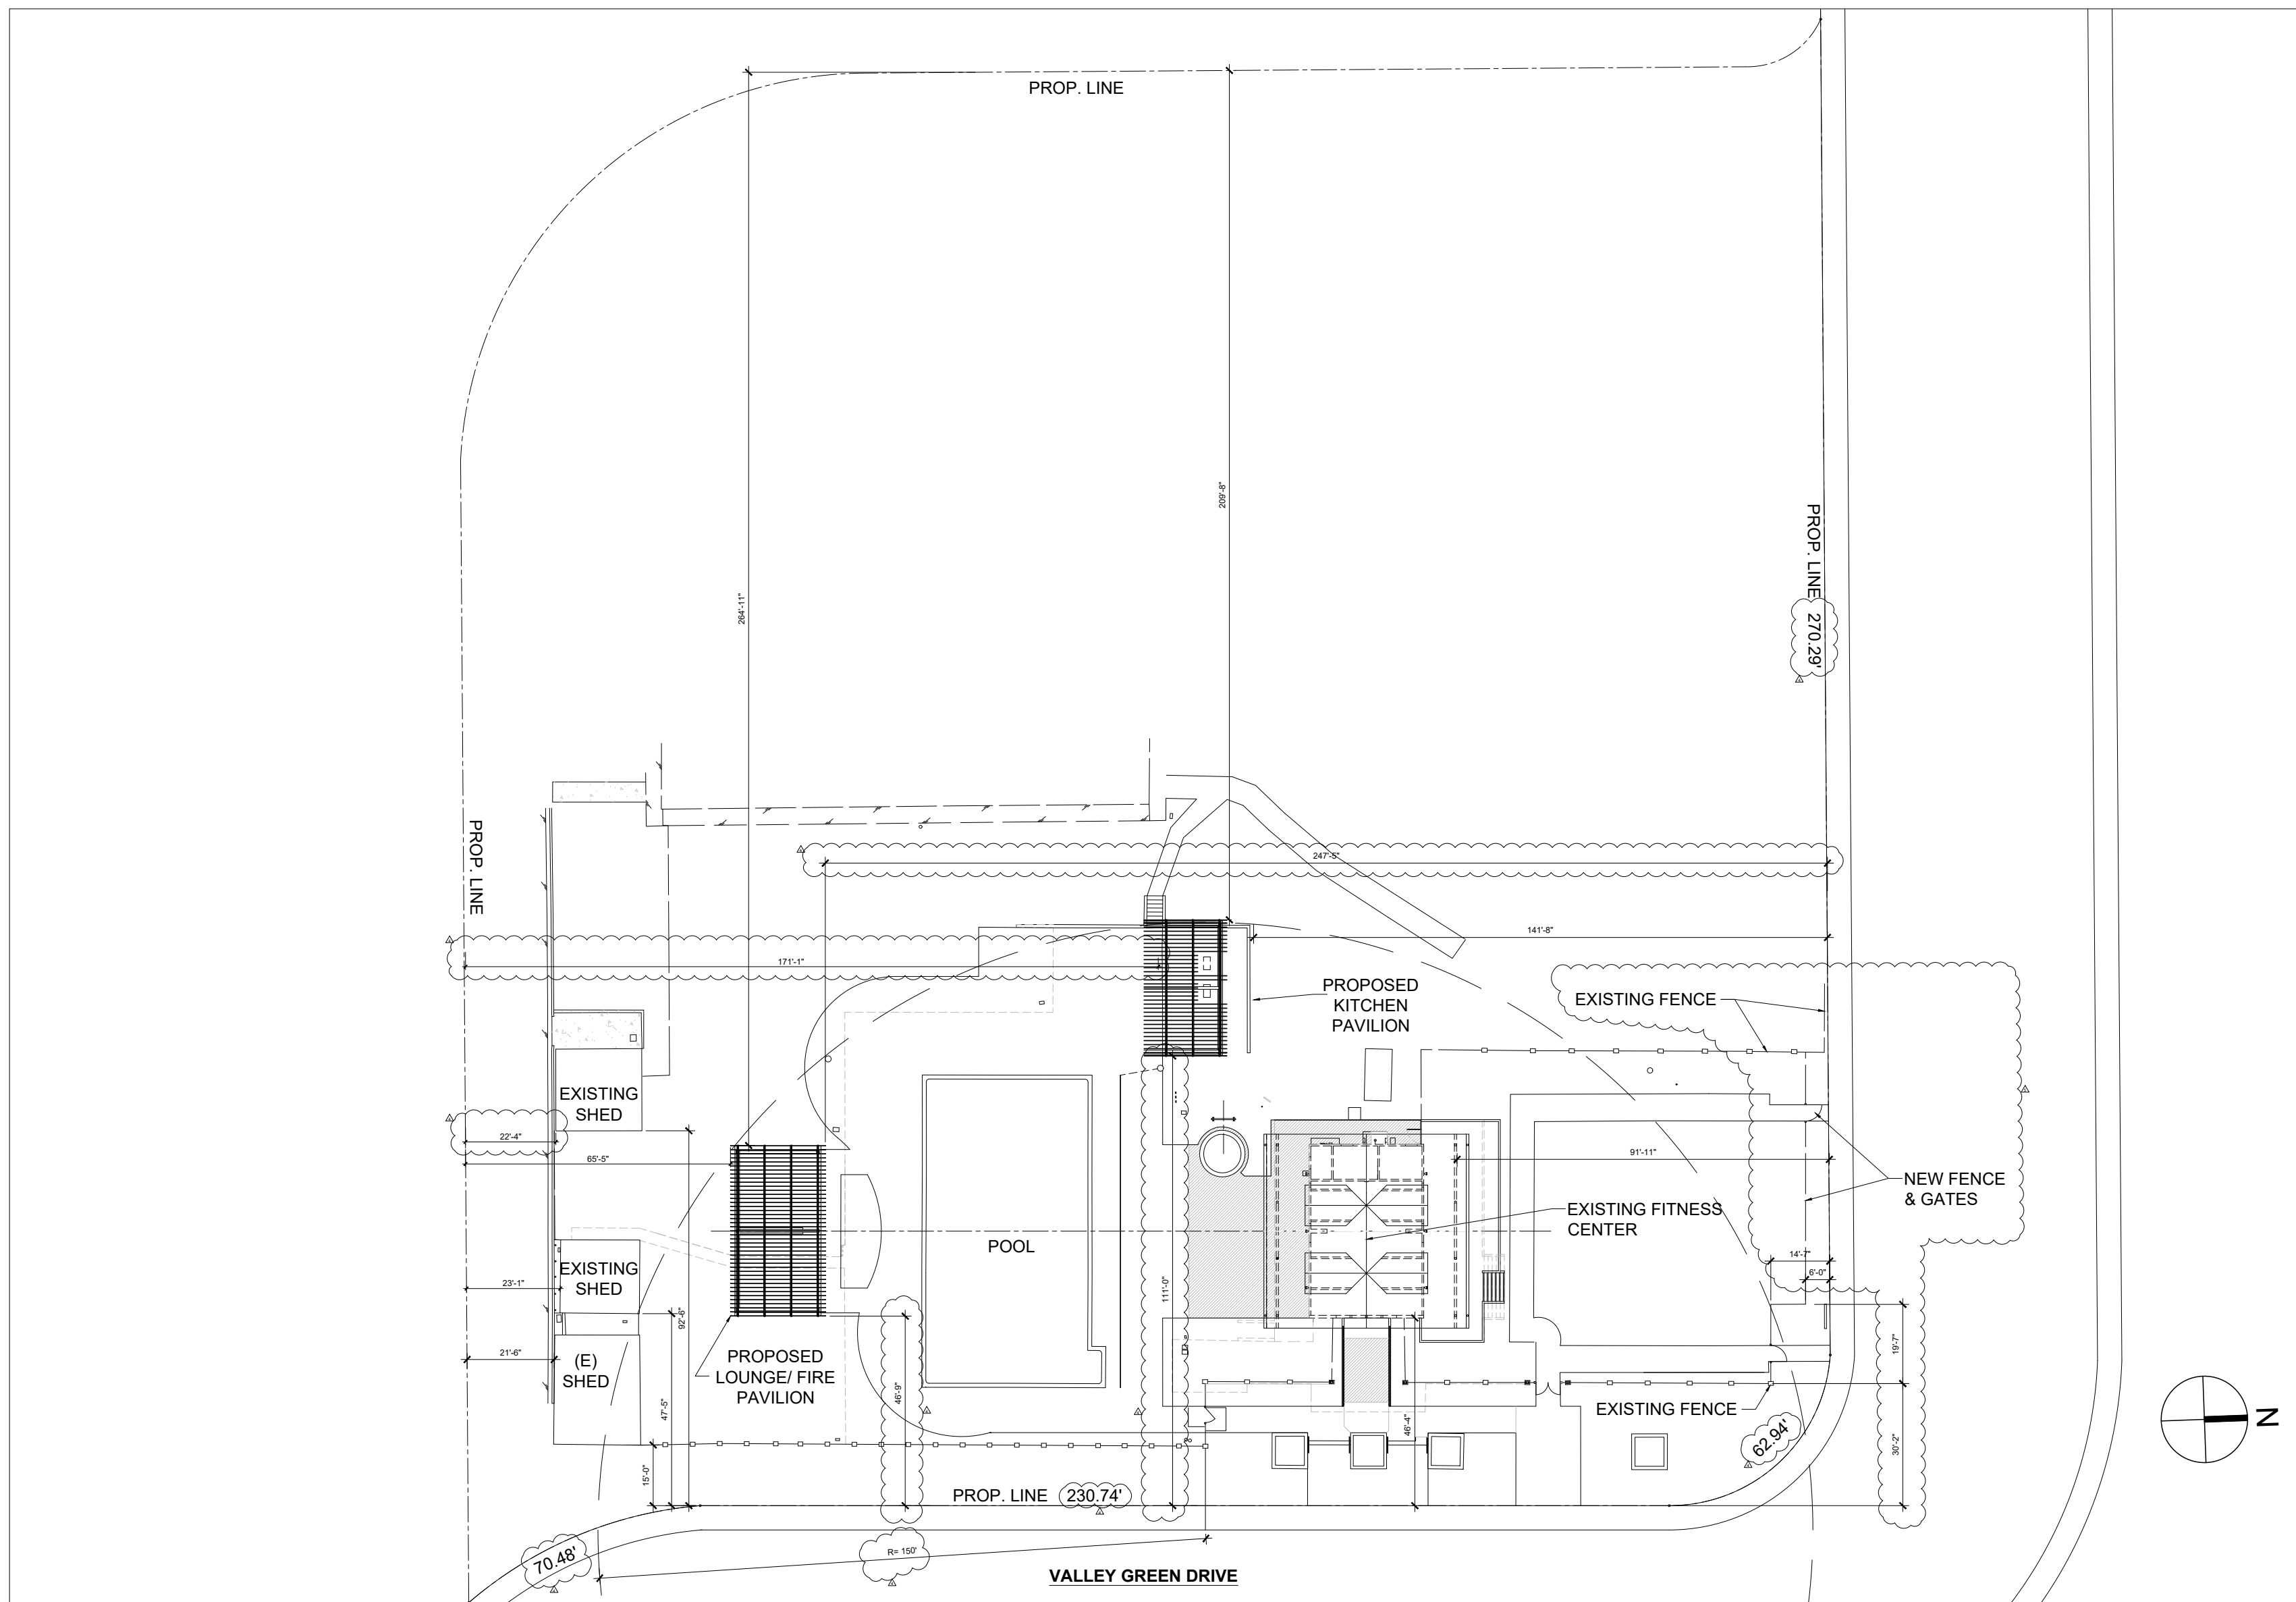

SITE PLAN SHOWING SETBACKS

1/32" = 1'-0"

DRAWING INDEX

ARCHITECTURAL DRAWINGS	
A0.01	PROJECT INFORMATION
AB1.00	AS-BUILT TOPOGRAPHIC SURVEY
AB1.01	AS-BUILT FLOOR PLAN
AB2.01	AS-BUILT EXTERIOR ELEVATIONS
A1.01	PROPOSED SITE PLAN
A1.02	FITNESS CENTER PROPOSED FLOOR PLAN
A1.03	PAVILIONS PROPOSED PLANS
A1.04	FITNESS CENTER PROPOSED REFLECTED CEILING PLAN
A1.05	SITE PLAN IMPERVIOUS SURFACE COVERAGE
A2.01	FITNESS CENTER PROPOSED EXTERIOR ELEVATIONS
A2.02	PAVILIONS PROPOSED EXTERIOR ELEVATIONS
A3.01	PROPOSED BUILDING SECTIONS
A4.01	PROPOSED WALL SECTIONS
A5.01	PROPOSED DETAILS
A5.02	PROPOSED DETAILS

STRUCTURAL DRAWINGS	
S1	STRUCTURAL NOTES & ABBREVIATIONS
S2	TYPICAL DETAILS
S3	PLANS
S4	SECTIONS & DETAILS
S5	PLANS & DETAILS

LANDSCAPE DRAWINGS	
L1.0	MATERIALS PLAN
L2.0	LAYOUT PLAN
L3.0	IRRIGATION PLAN
L4.0	PLANTING PLAN
L5.0	SITE DETAILS
L5.1	IRRIGATION CALCULATIONS & DETAILS
L5.2	IRRIGATION DETAILS
L5.3	PLANTING DETAILS
L5.4	KITCHEN DETAILS
L6.0	MATERIALS SPECIFICATIONS
L6.1	IRRIGATION SPECIFICATIONS
L6.2	LANDSCAPE PLANTING SPECIFICATIONS

PROJECT DIRECTORY

PROPERTY MANAGERS	WOODMONT REAL ESTATE SERVICES 1050 RALSTON AVE. BELMONT, CA 94002 PROJ. MANAGER: JAMES TREGEMBO T. 650.802.1649
ARCHITECT	KNUTSON ARCHITECTURE - ERIC KNUTSON 2231 H STREET SACRAMENTO, CA 95816 T. 925.324.0587
STRUCTURAL ENGINEER	BAY STRUCTURAL ENGINEERING 2601 BLANDINGS AVE., SUITE C218 ALAMEDA, CA 94501 T. 415.816.2390
LANDSCAPE ARCHITECT	QUADRIGA LANDSCAPE ARCHITECTURE & PLANNING, INC. SACRAMENTO & SANTA ROSA, CA T. 916.441.2129

PROJECT SUMMARY

OCCUPANCY GROUP: A-3	
CONSTRUCTION TYPE: V-B (NON-RATED)	
SPRINKLERED: NO	
APPLICABLE BUILDING CODES (ORIGINAL): UBC 1991, UMC 1991, UPC 1991 & NEC 1991	
APPLICABLE BUILDING CODES FOR NEW CONSTRUCTION: CRC 2019 & CBC 2019 & ASCE 7-10 MIN. DESIGN LOADS	
APPLICABLE PLUMBING CODE FOR NEW CONSTRUCTION: CPC 2019	
APPLICABLE ELECTRICAL CODE FOR NEW CONSTRUCTION: CEC 2019	
CA ENERGY STANDARDS FOR NEW CONSTRUCTION (TITLE 24): 2019	
CA GREEN BUILDING STANDARDS FOR NEW CONSTRUCTION (CAL GREEN): 2019	
CA FIRE CODE: 2019	
ZONING: R3	
FLOOR AREAS:	
(E & N) FITNESS CENTER (N.C.):	910 SF
(OCCUPANT LOAD: 19)	
(E) SHEDS (TO REMAIN):	1360
TOTAL (E) PARCEL COVERAGE:	2270 SF
(N) FIRE/LOUNGE PAVILION:	805
(N) KITCHEN PAVILION:	661
TOTAL (N) PARCEL COVERAGE:	3736 SF

PROJECT SCOPE

NEW SITE WORK LANDSCAPING TO INCLUDE NEW APPROACH/ ACCESS FROM VALLEY GREEN DRIVE. REMODEL/ REPAIR OF EXISTING POOL, SPA AND POOL DECK. ADDITION OF NEW DINING AND LOUNGE PAVILIONS AT POOL AREA. REMODEL OF EXISTING FITNESS/ COMMUNITY CENTER INTO FITNESS CENTER. ENLARGE EXISTING NORTH WOOD DECK AND REPAIR/ REPLACE ACCESS STAIR.

DRAWING SYMBOLS

FIN. FL. +0'-0"	DATUM POINT, DIMENSION POINT
1 (DRAWING NO.) A1.01 (SHEET NO.)	SECTION TAG
1 (DRAWING NO.) A1.01 (SHEET NO.)	DETAIL TAG
1 (DRAWING NO.) A1.01 (SHEET NO.)	EXTERIOR ELEVATION TAG
A (DRAWING NO.) B/A1.01D (SHEET NO.)	INTERIOR ELEVATION TAG
1	DOOR NUMBER
1	FINISH DESIGNATION- SEE FINISH SCHEDULE, SHT. A0.02
A	APPLIANCE/ EQUIPMENT DESIGNATION- SEE EQUIPMENT SCHEDULE, SHEET A0.02



Revisions:

07/20/18	
01/28/19	
03/29/19	PERMIT SET
1/21/20	PERMIT SET REV.
6/18/20	PERMIT ASA SET REV.
8/12/20	PERMIT BUILD. REV.
9/25/20	ASA/ PLANNING REV.
12/24/20	ASA/ PLANNING REV.
2/17/21	ASA/ PLANNING REV.

PROJECT INFO

DATE	7/9/18
SCALE	N.T.S.
DRAWN:	ek


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THE VILLAGES AT CUPERTINO
20875 VALLEY GREEN DRIVE
CUPERTINO, CALIFORNIA


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2	8/12/20 PERMIT/ BUILD. REV.
3	9/25/20 ASA/ PLANNING REV.
4	12/24/20 ASA/ PLANNING REV.
5	2/17/21 ASA/ PLANNING REV.
6	5/4/21 ASA/ PLANNING REV.


PROPOSED FITNESS CENTER SITE PLAN

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DRAWN: ek

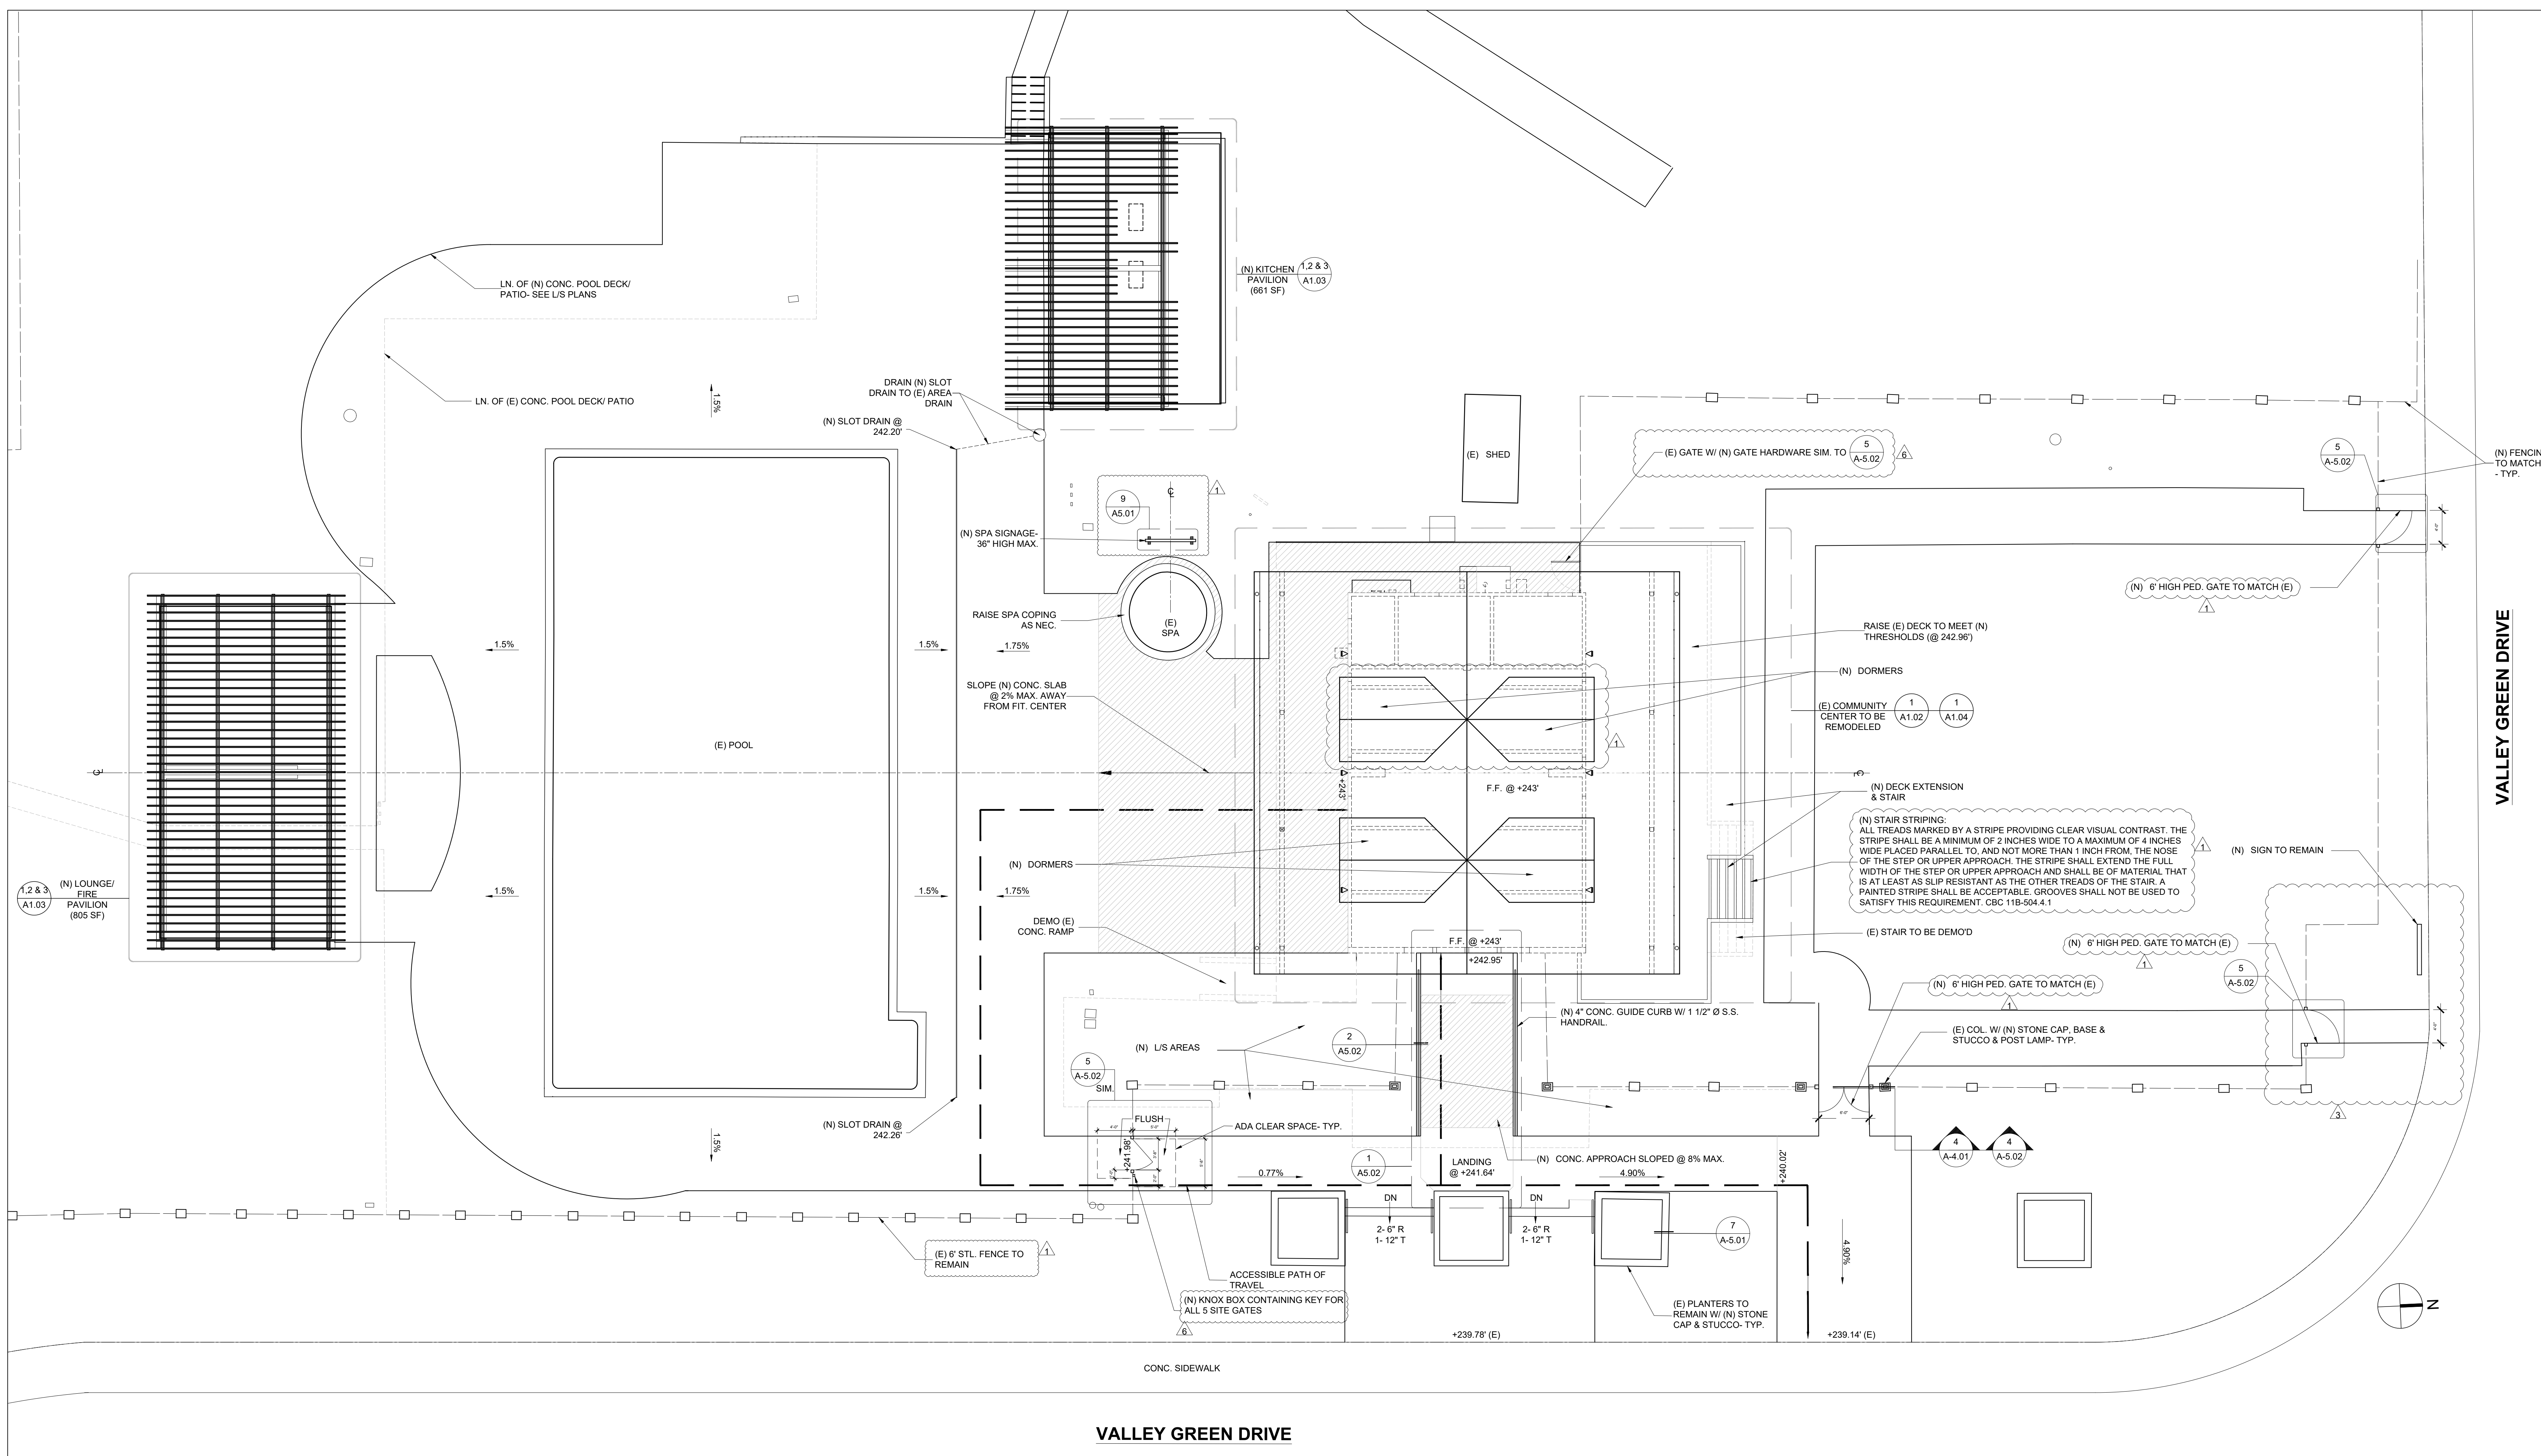


1 FITNESS CENTER PROPOSED SITE PLAN

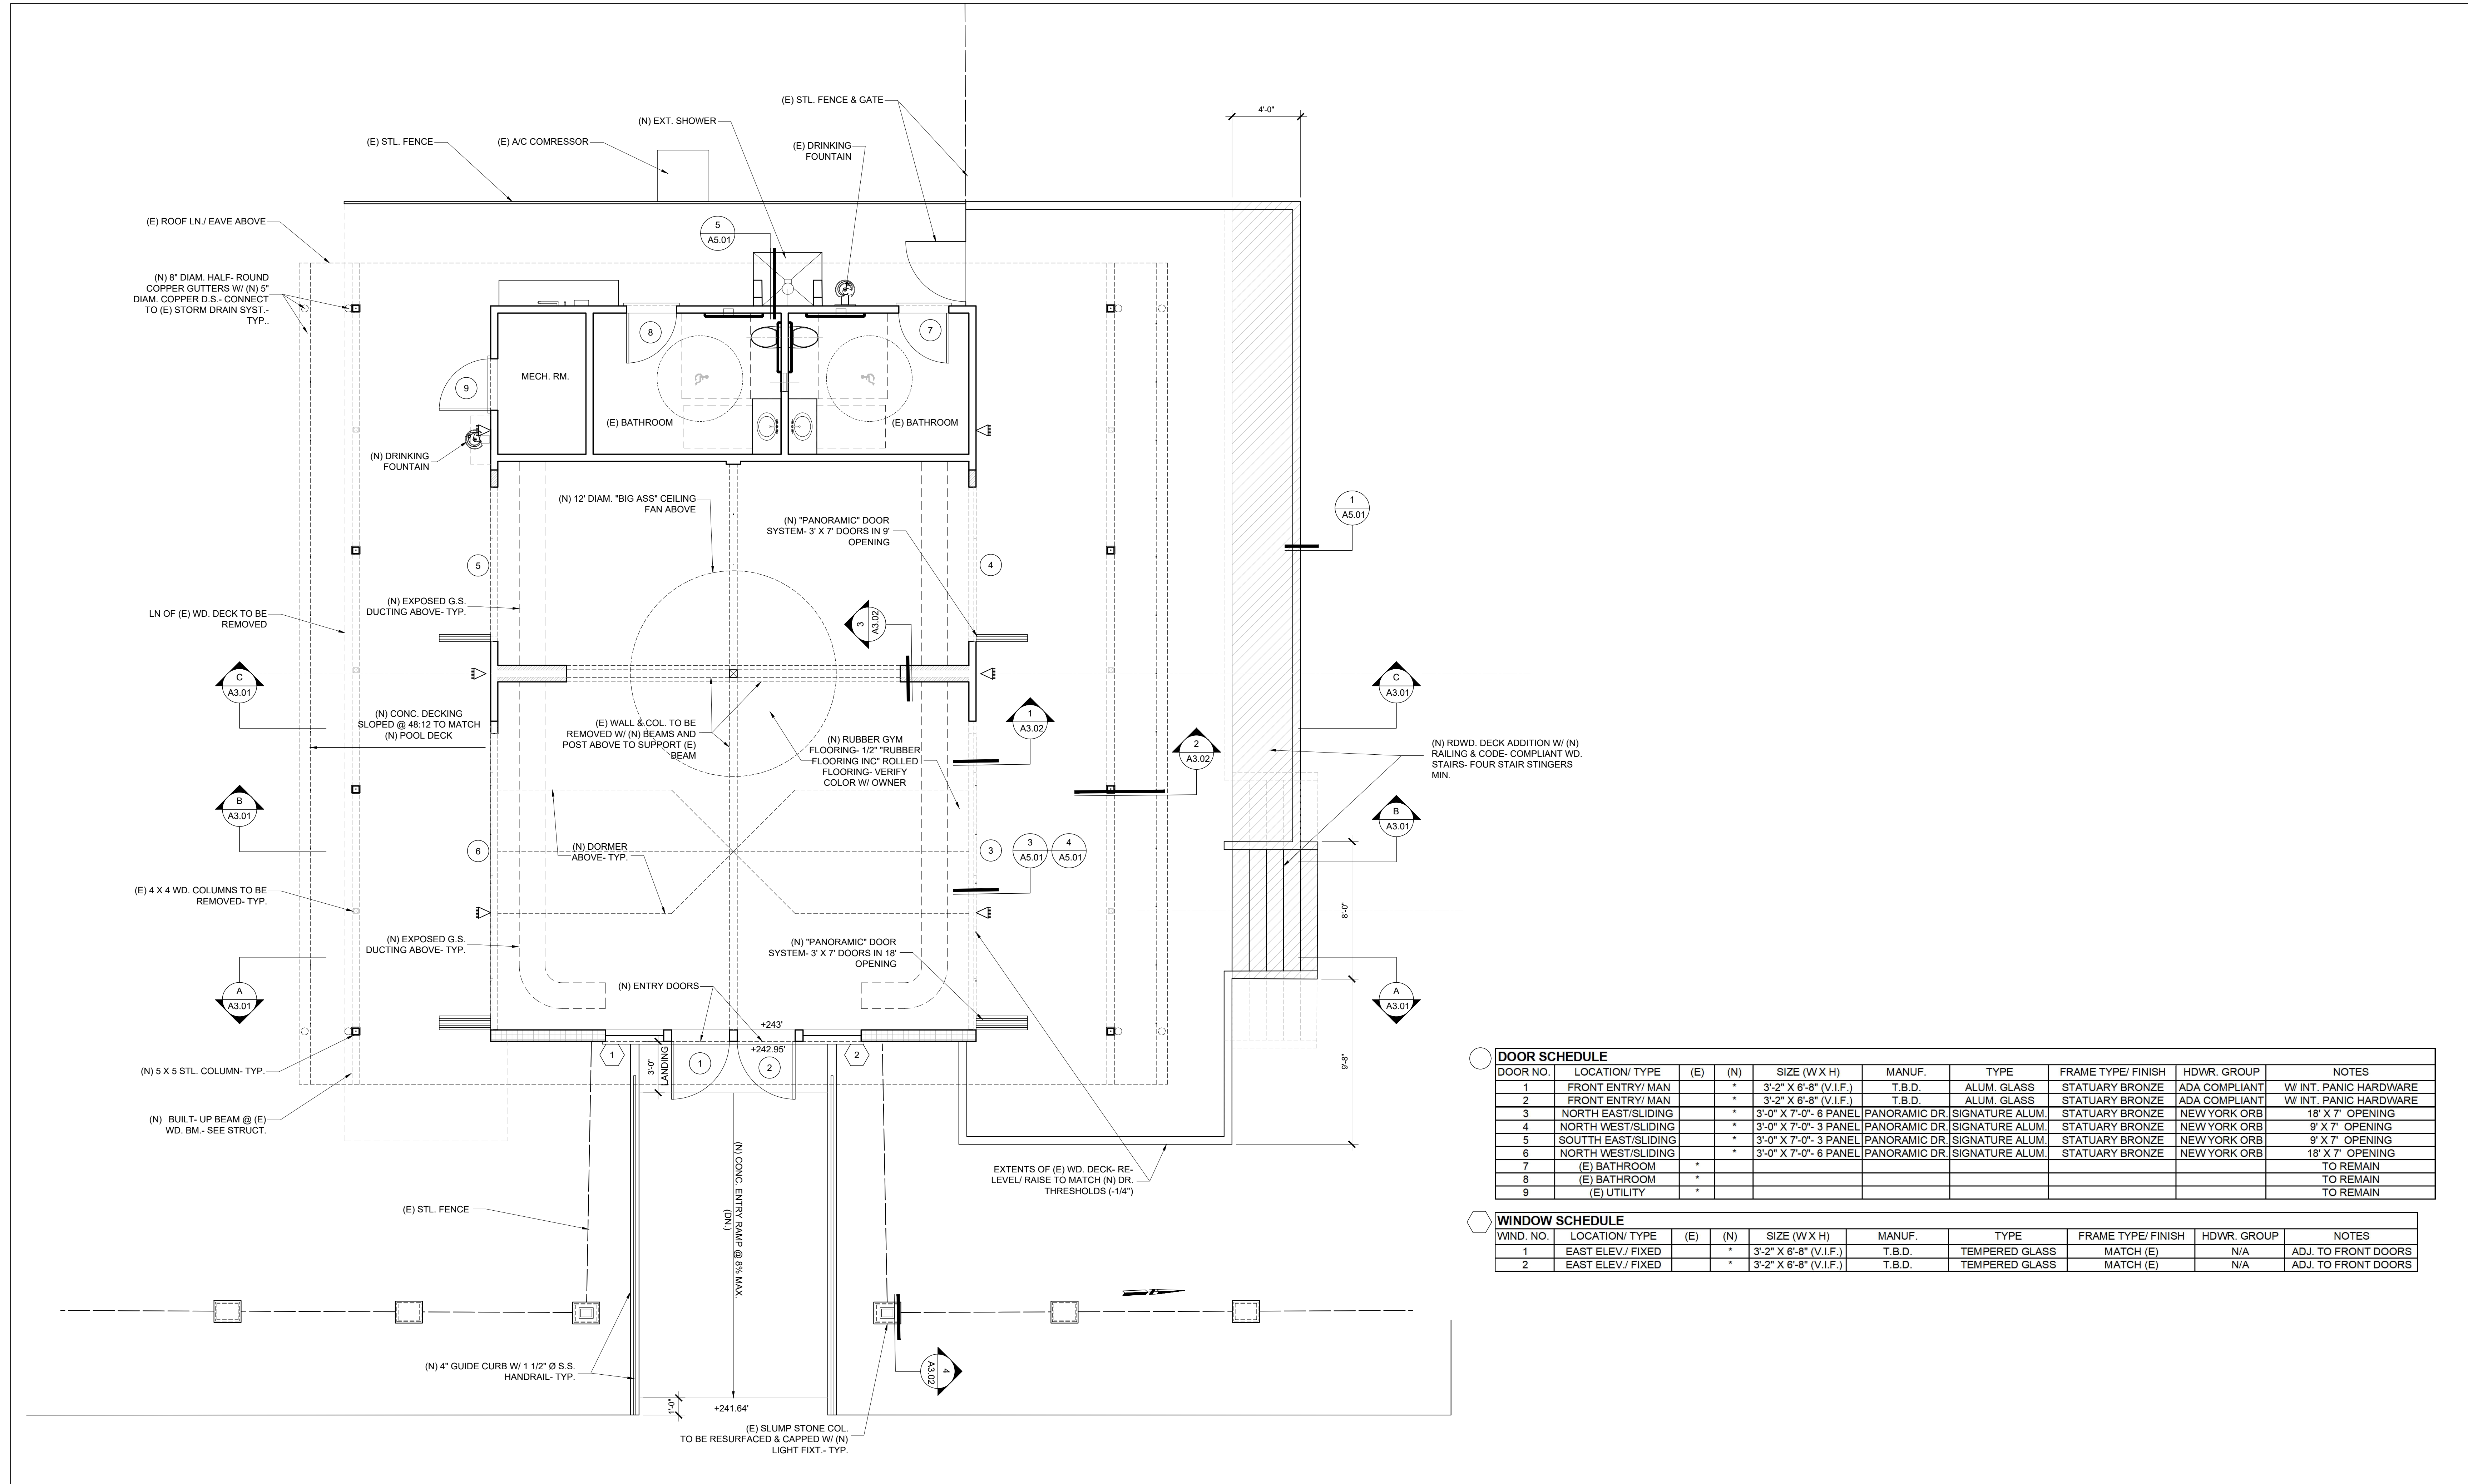
1 FITNESS CENTER PROPOSED FLOOR PLAN
1/4" = 1'-0"

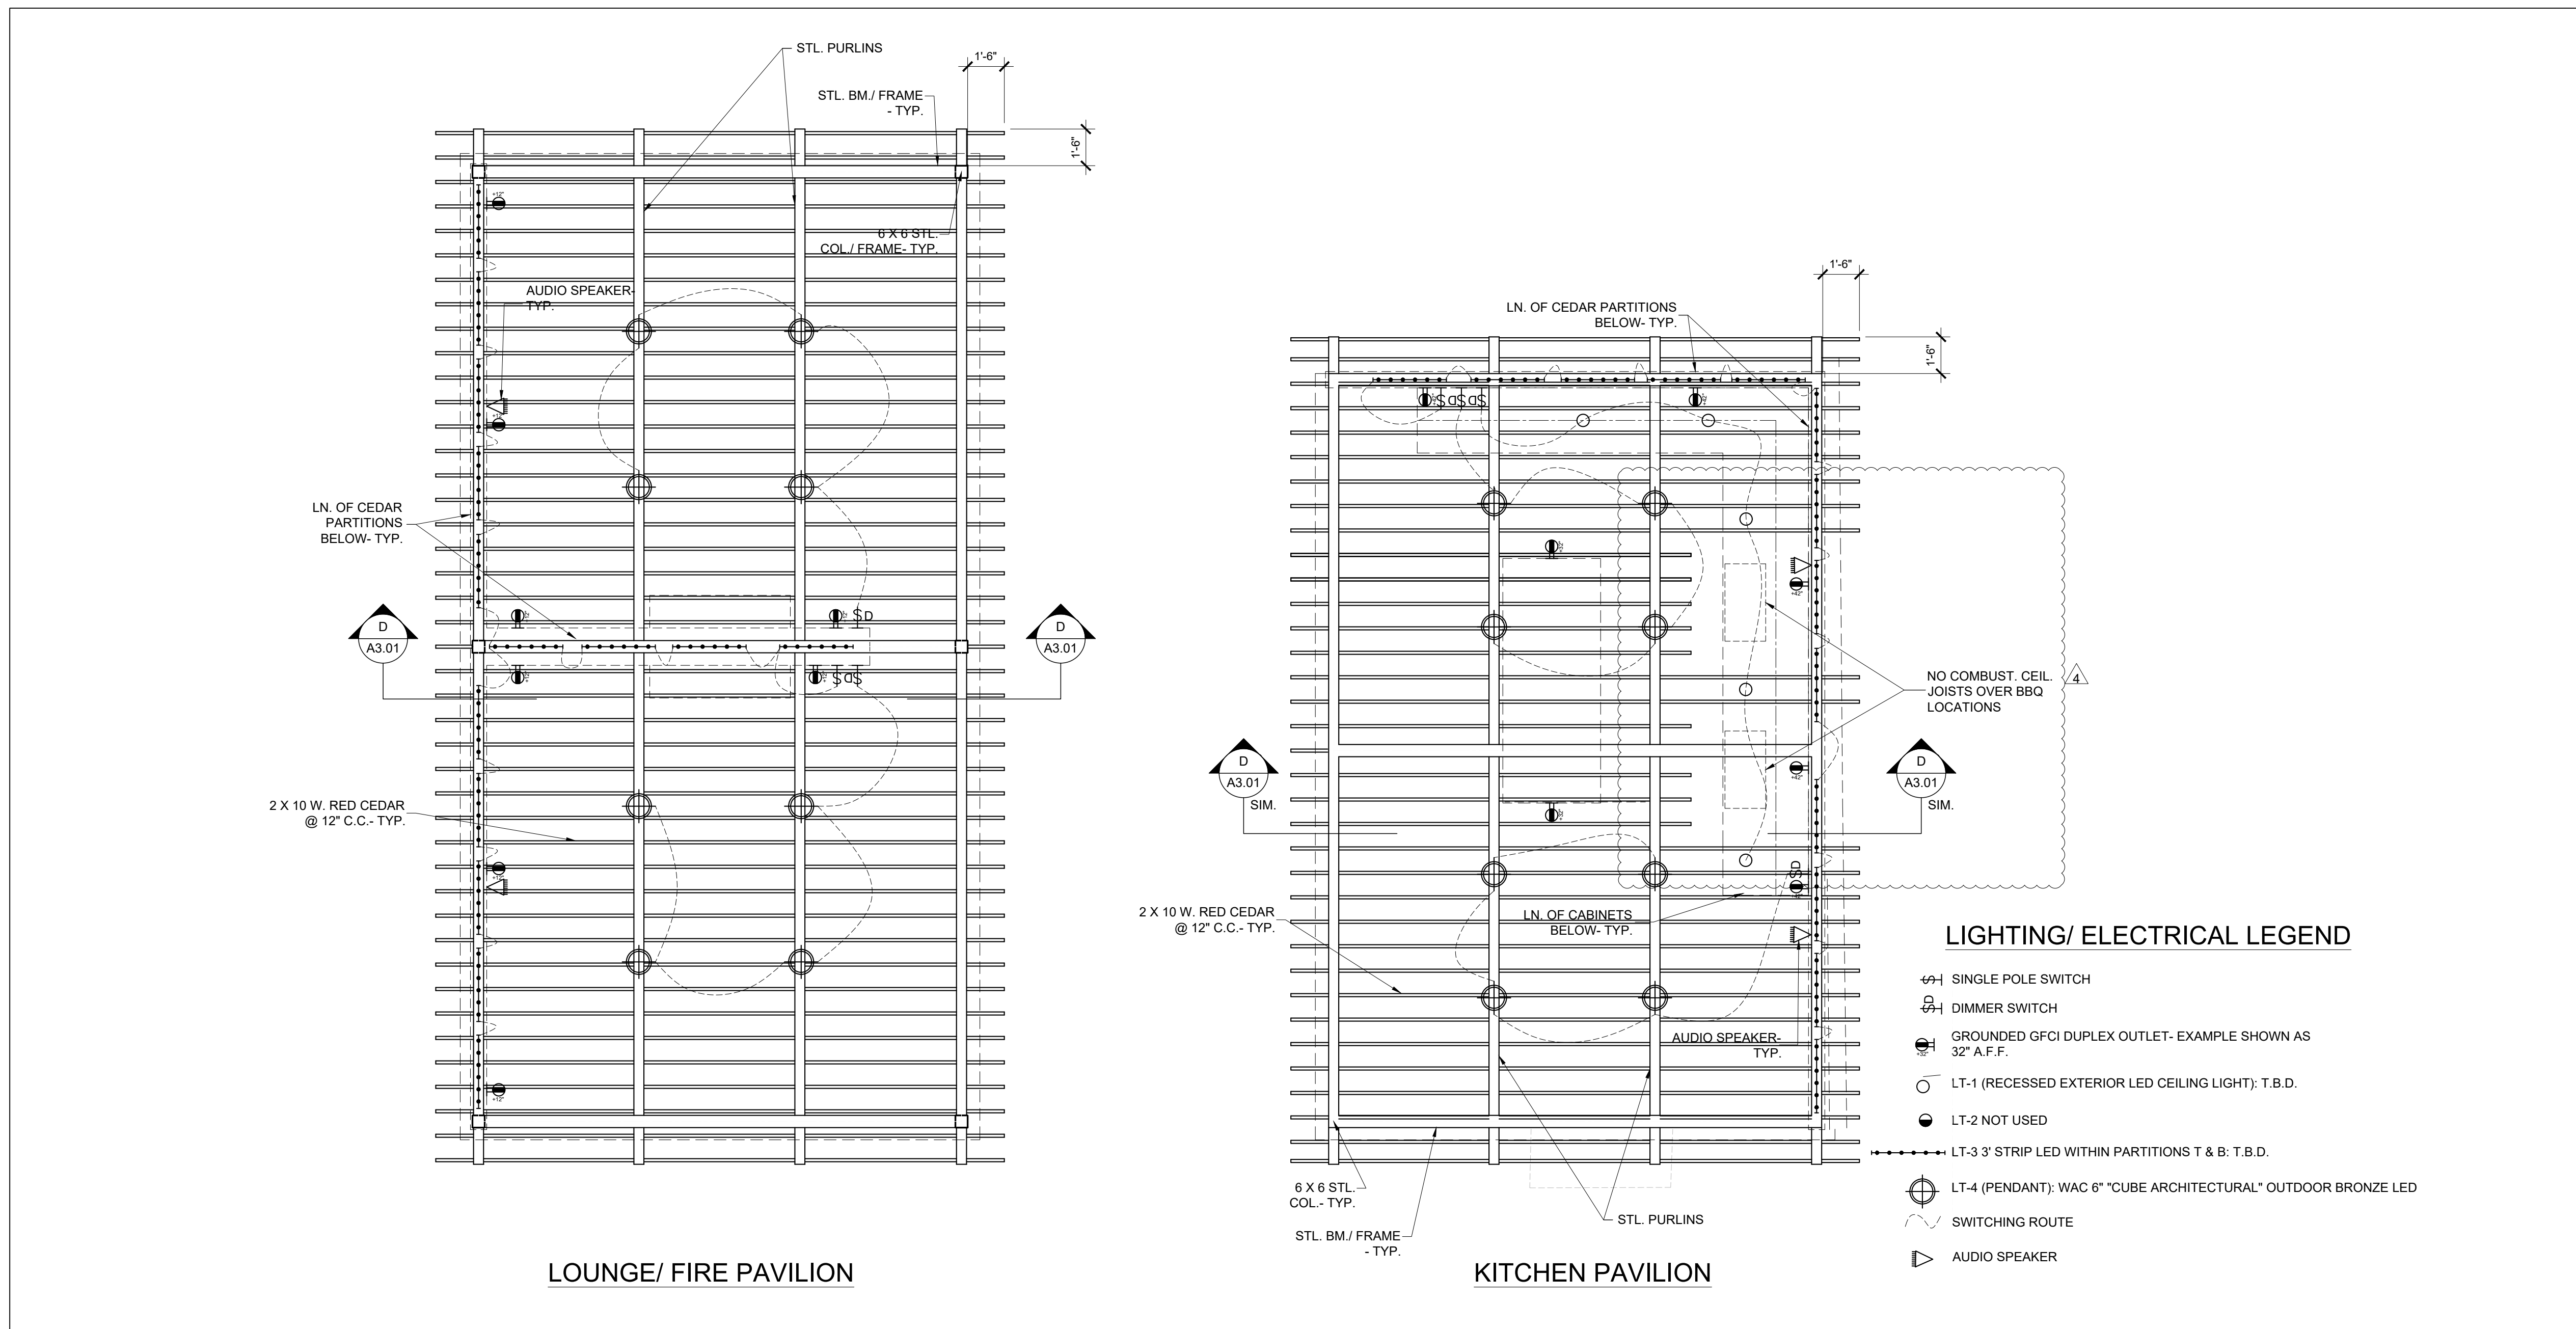


3 PAVILIONS REFLECTED CEILING PLANS PLANS SHOWING LIGHTING & ELECTRICAL
1/4" = 1'-0"

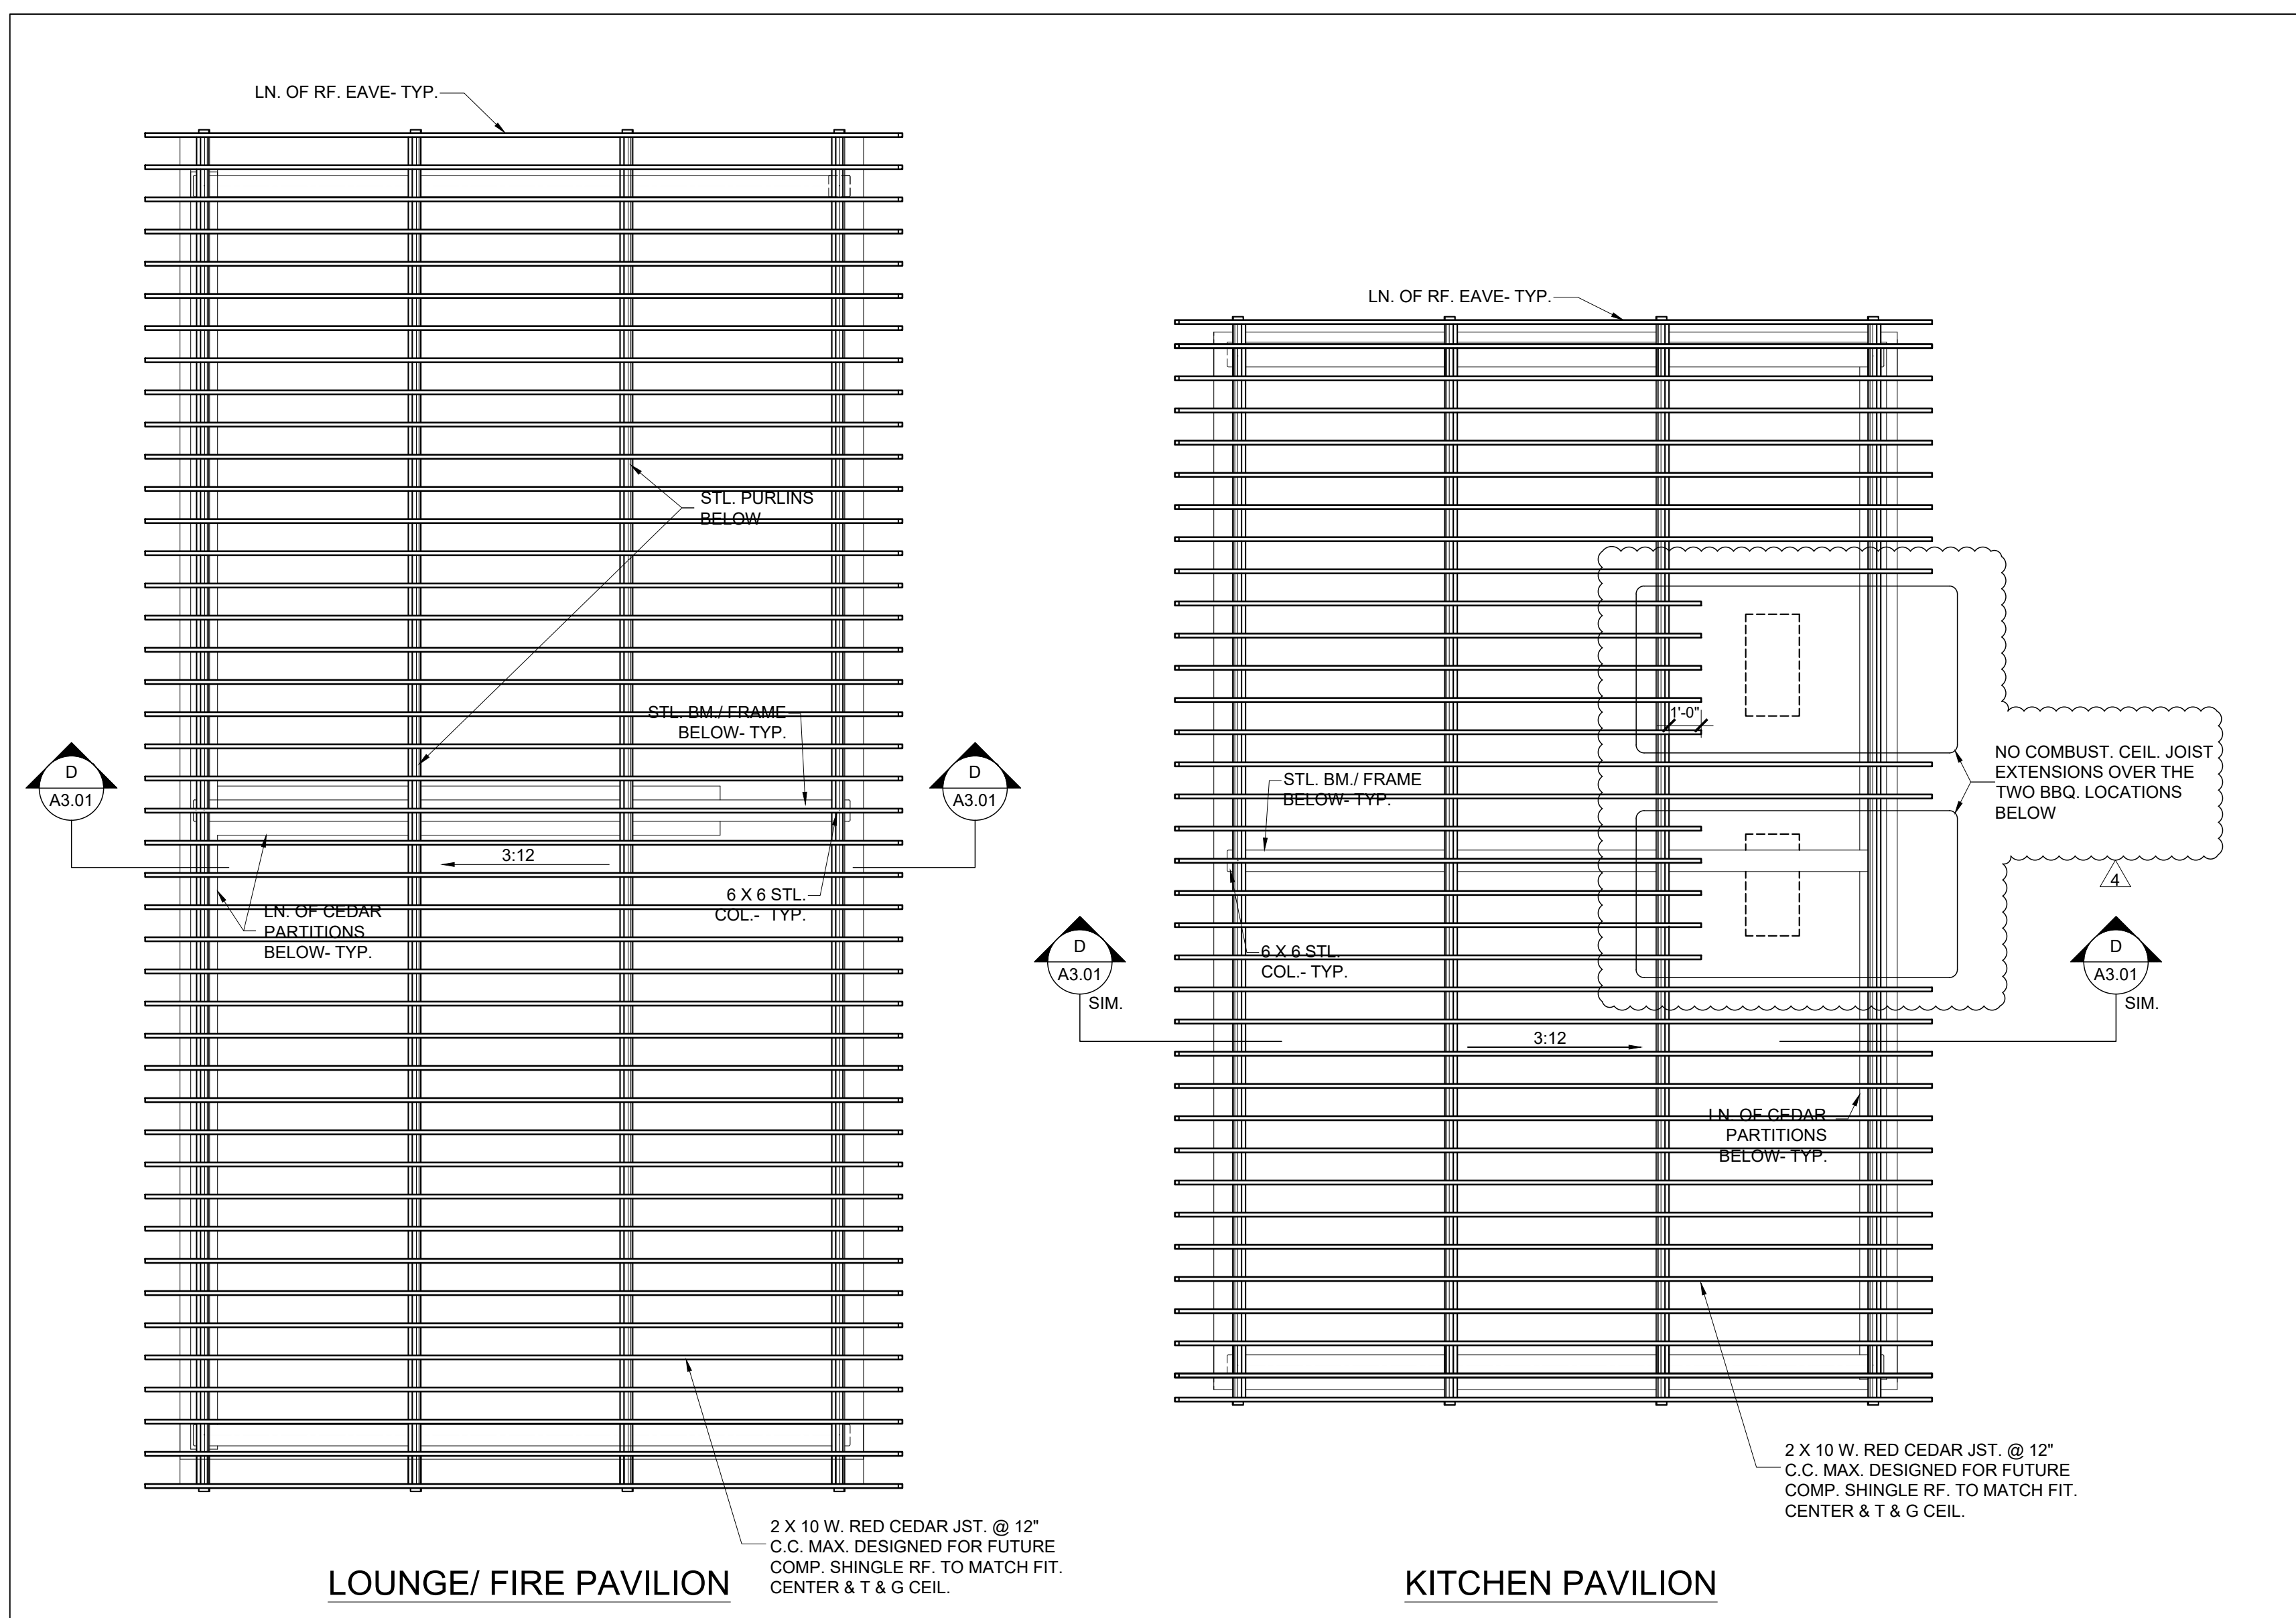


2 PAVILIONS PROPOSED ROOF PLANS
1/4" = 1'-0"

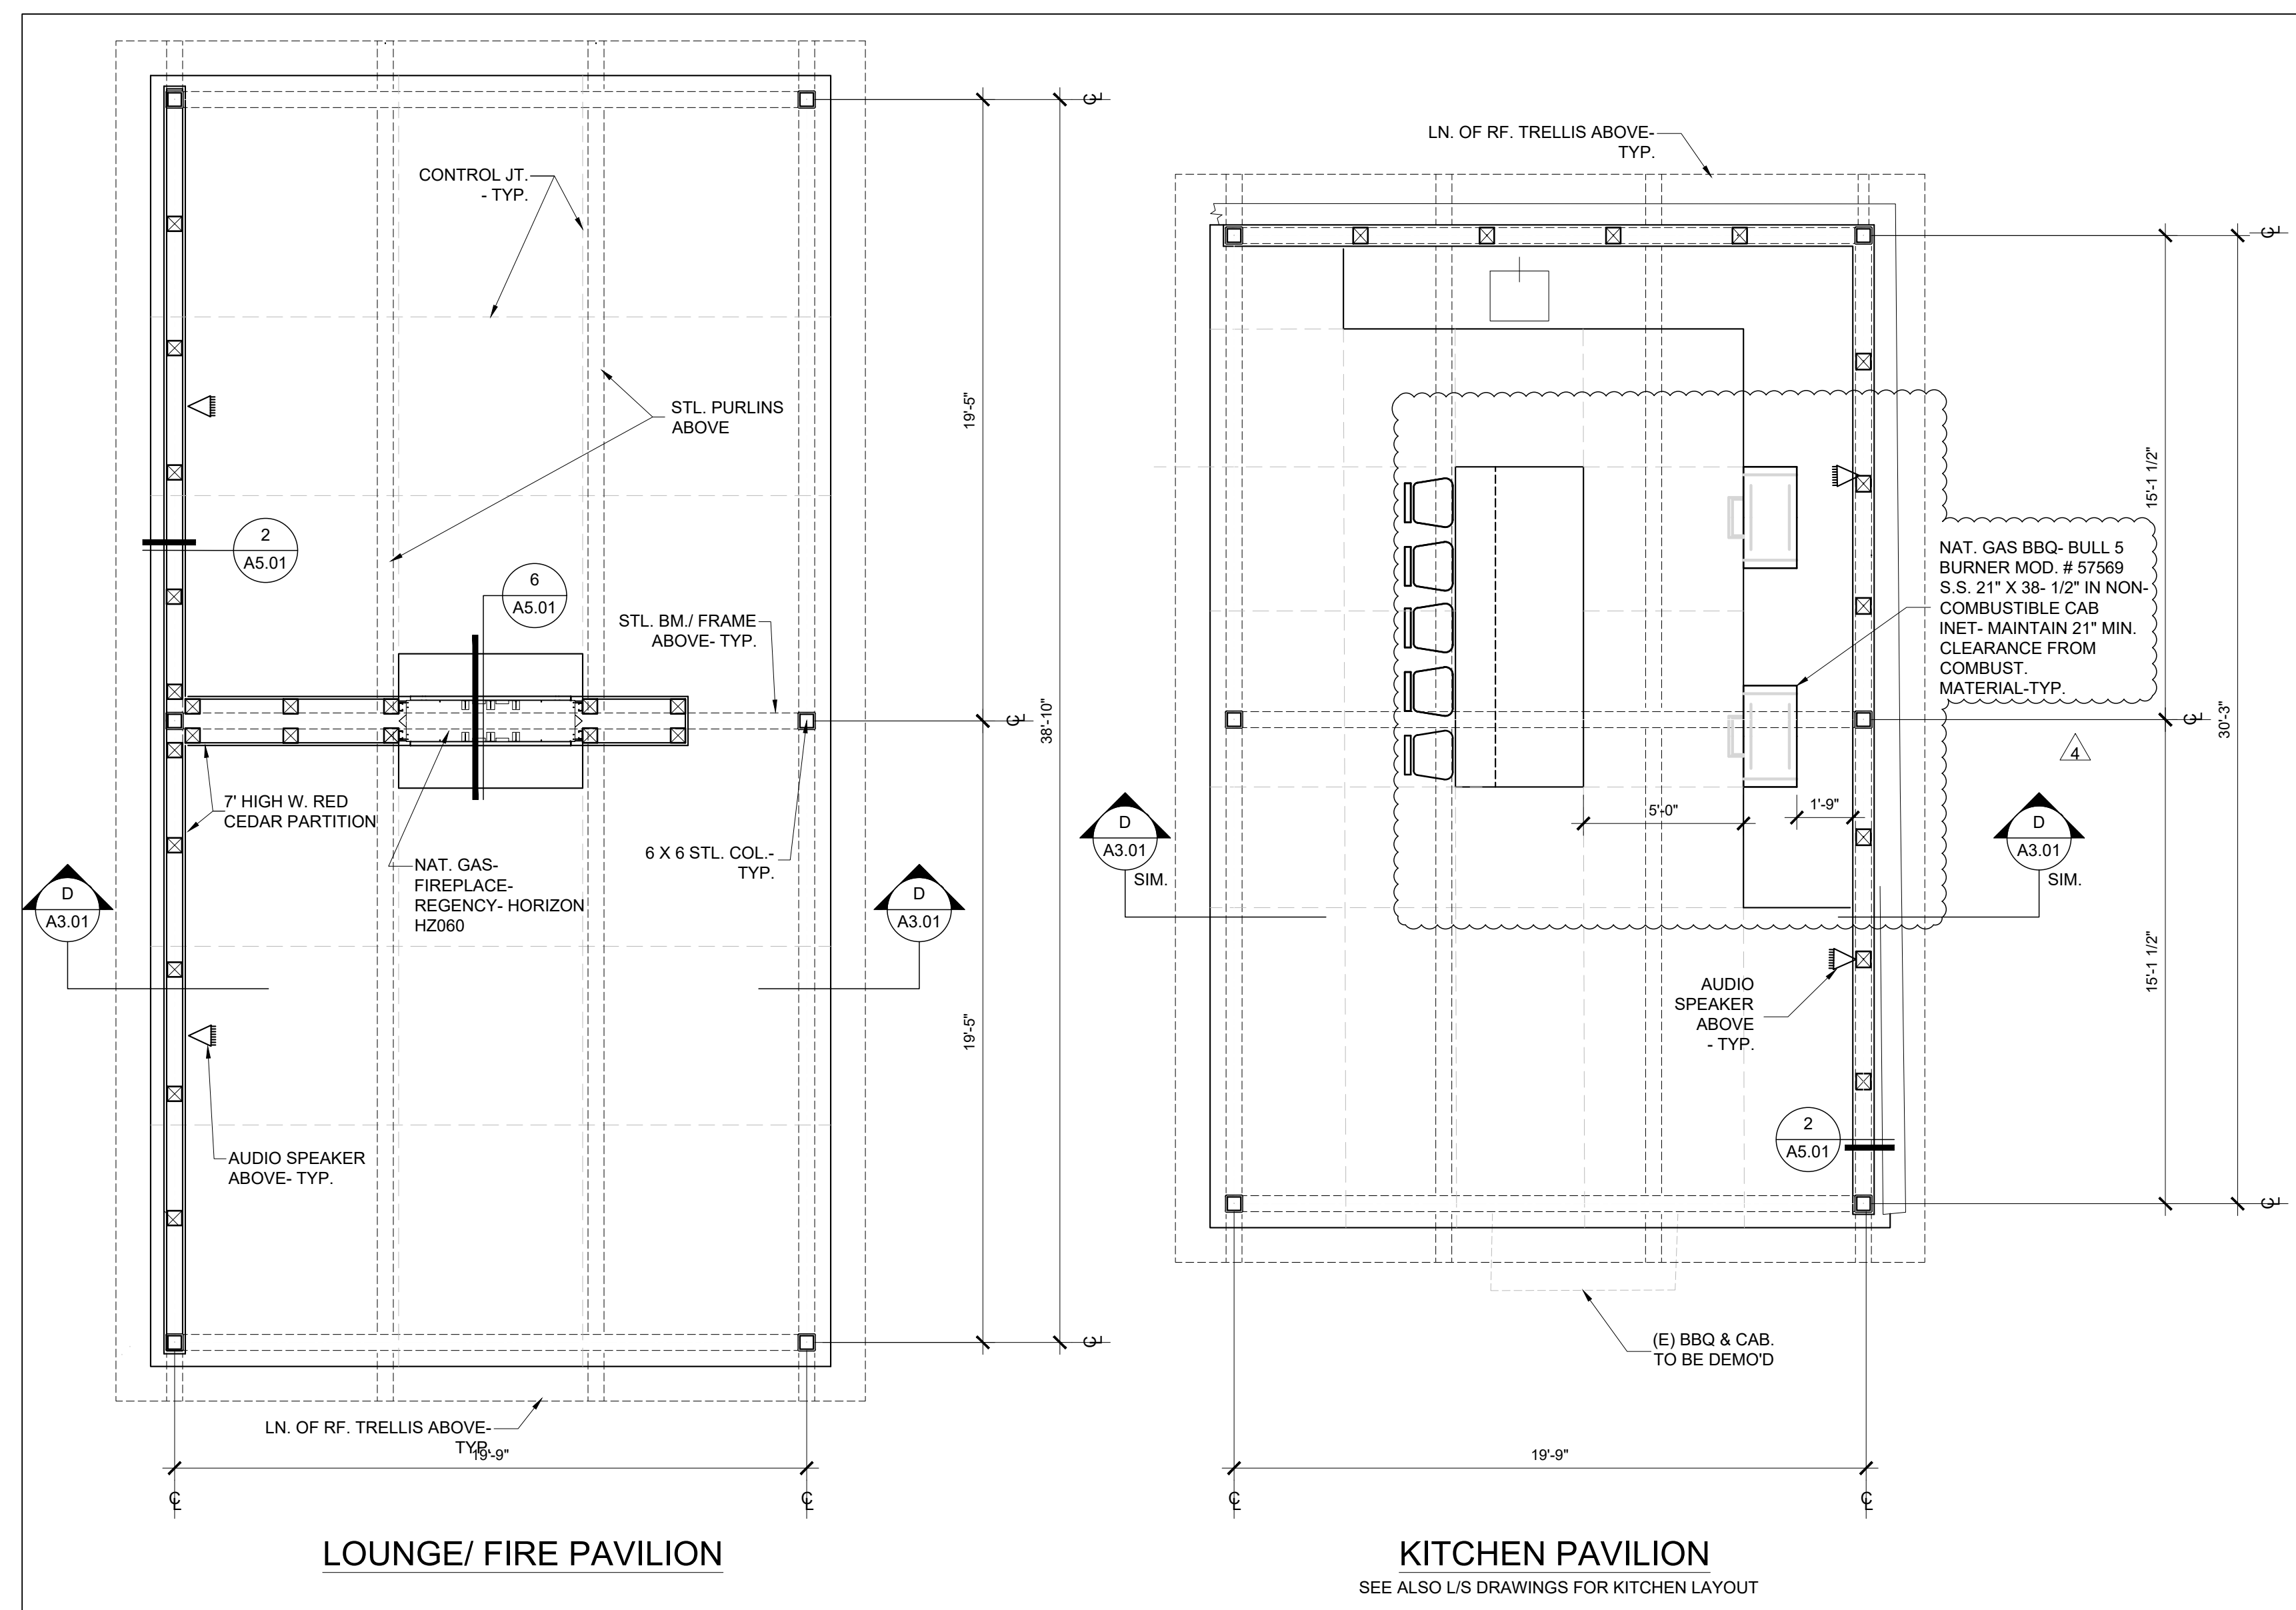


1 PAVILIONS PROPOSED FLOOR PLANS
1/4" = 1'-0"

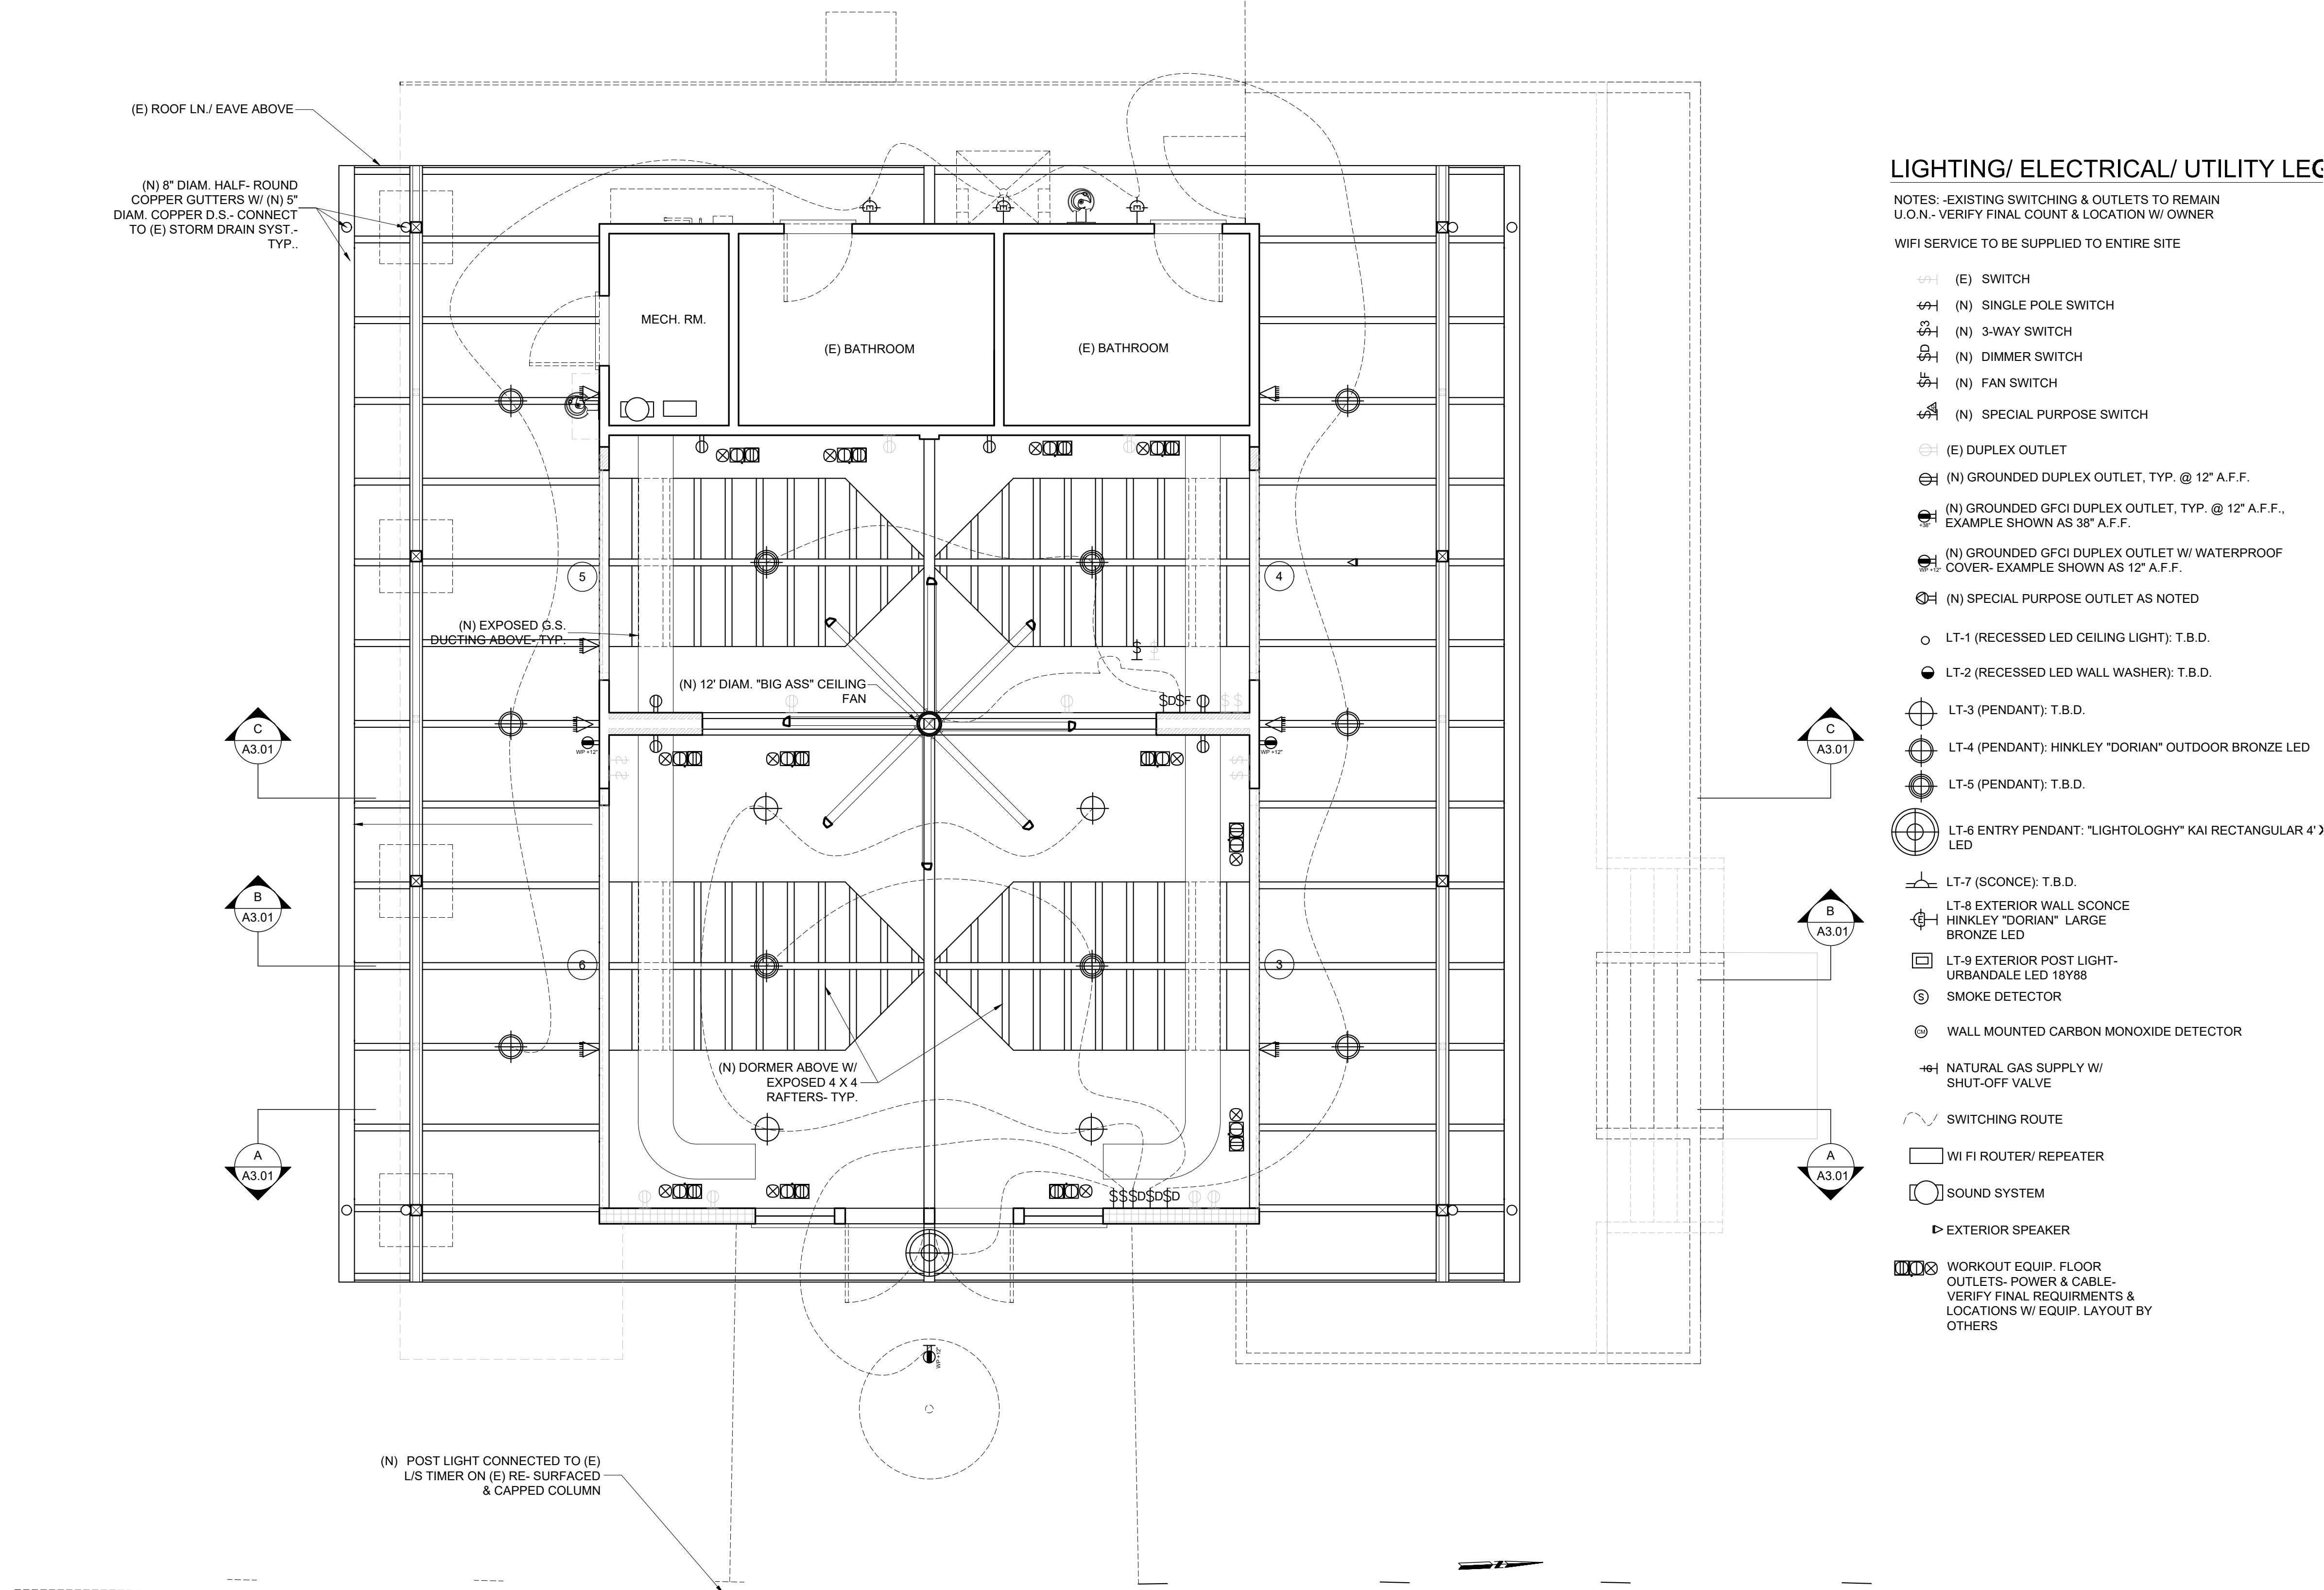

1 PROPOSED REFLECTED CEILING PLAN SHOWING LIGHTING & ELECTRICAL
1/4" = 1'-0"

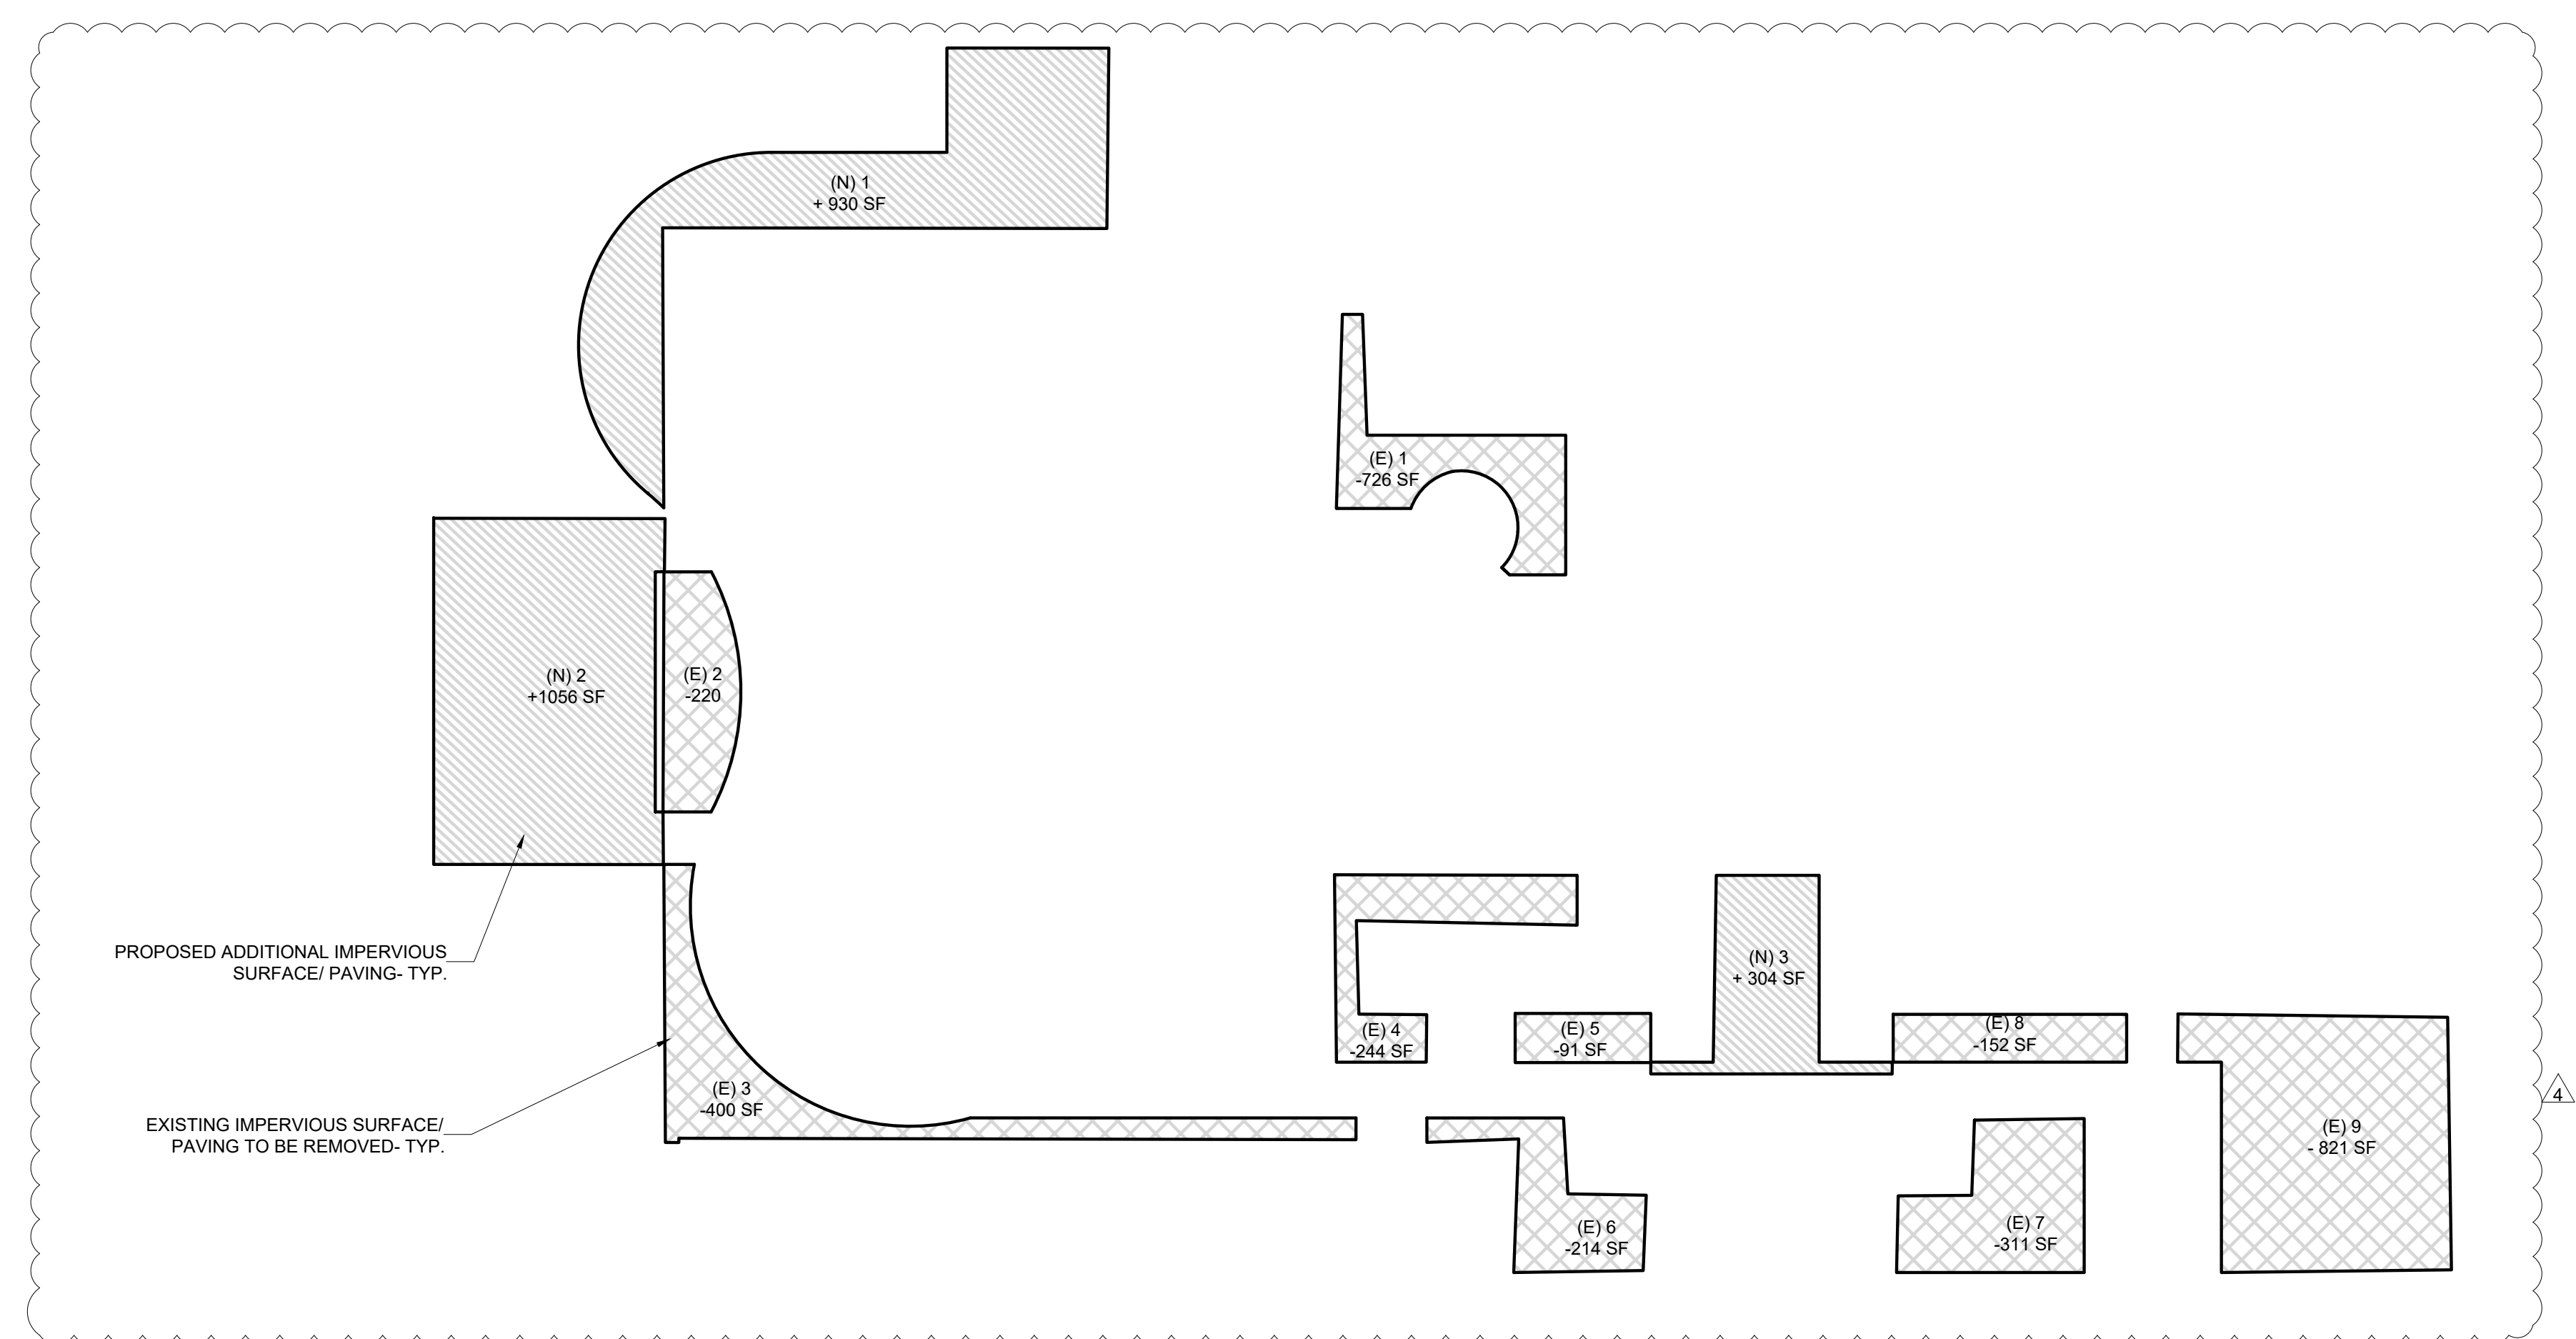


2 SITE PLAN IMPERVIOUS SURFACE AREA ANALYSIS/ SCHEMATIC

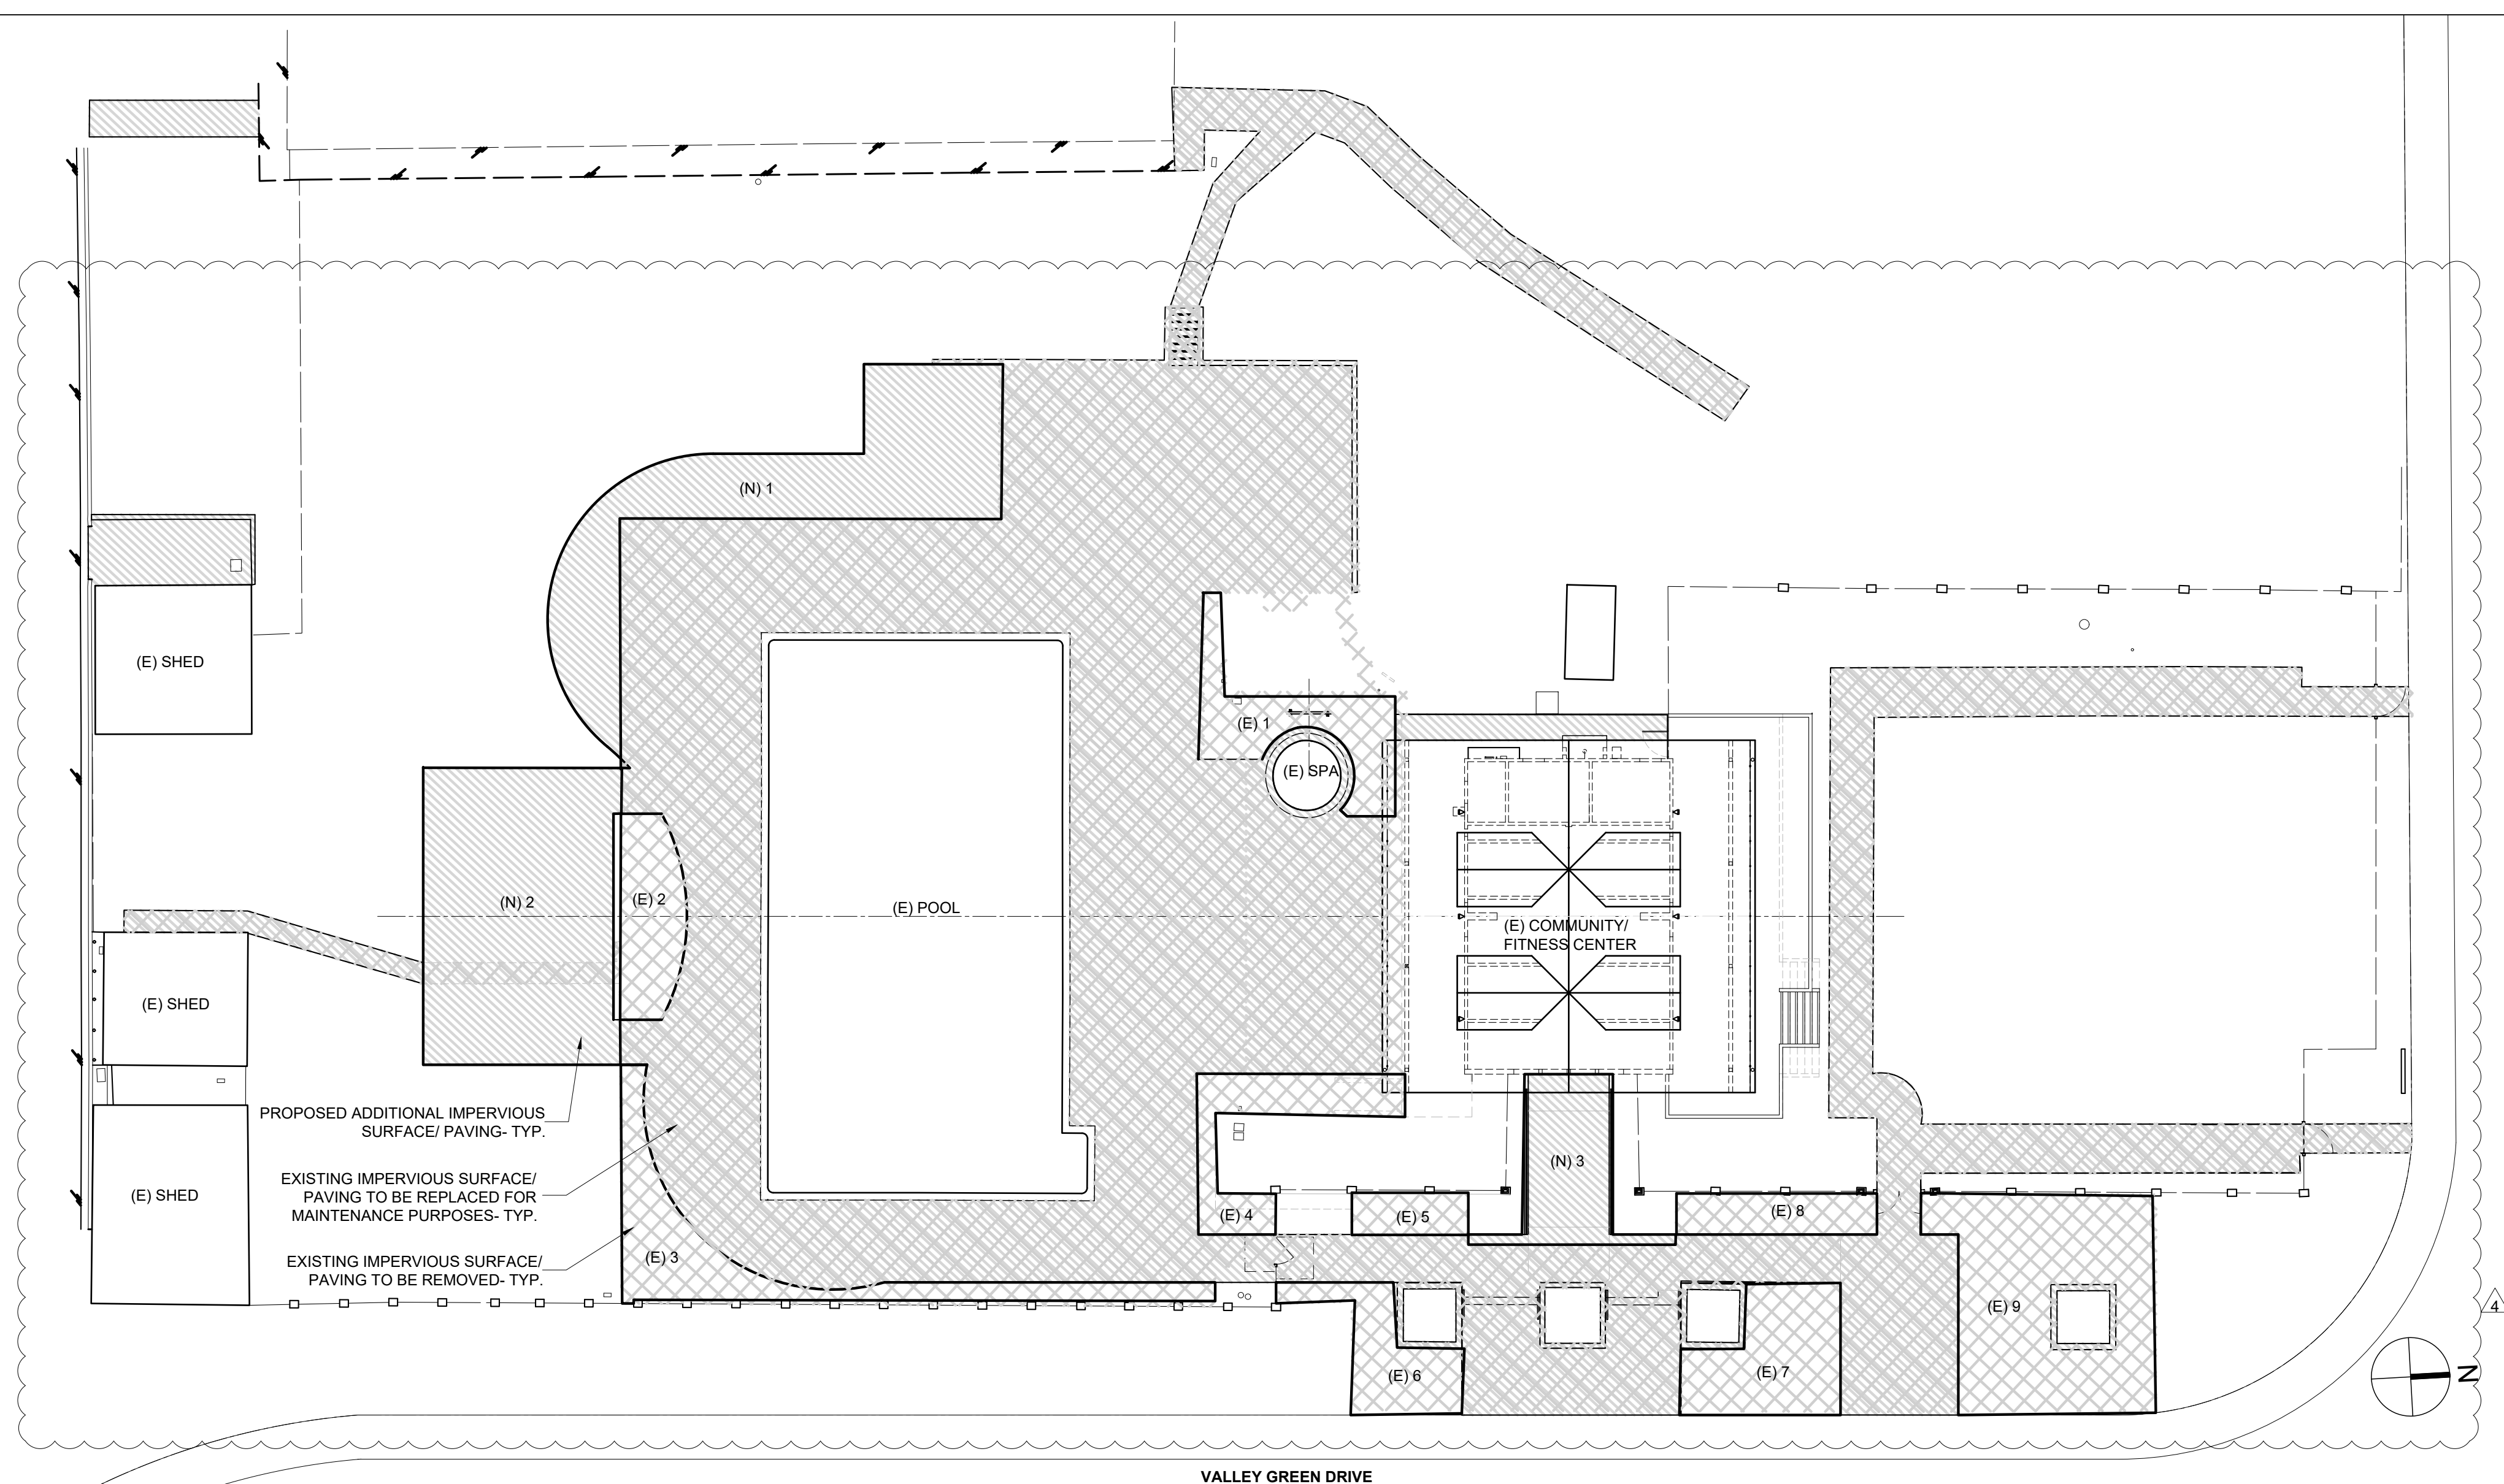

1 SITE PLAN/ IMPERVIOUS SURFACES

IMPERVIOUS SURFACE ANALYSIS

TOTAL PARCEL AREA:	117,307 SF (2,693 ACRES)
IMPERVIOUS SURFACE:	
AS-BUILT IMPERVIOUS SURFACE:	13,200 SF, 11.25% PARCEL COVERAGE
PROPOSED IMPERVIOUS SURFACE:	12,311 SF, 10.49% PARCEL COVERAGE
	-889 SF, .76% REDUCED COVERAGE
(N) 1: + 590 SF	
(N) 2: +1056	
(N) 3: + 304	
TOTAL	+ 2290 SF ADDED PAVING/ IMPERVIOUS SURFACE
(E) 1: -726 SF	
(E) 2: -220	
(E) 3: -400	
(E) 4: -244	
(E) 5: -91	
(E) 6: -214	
(E) 7: -311	
(E) 8: -152	
(E) 9: -821	
TOTAL	- 3179 SF REMOVED PAVING/ IMPERVIOUS SURFACE
3179	
-2290	
889 SF REDUCTION IN IMPERVIOUS/ PAVING SURFACES	

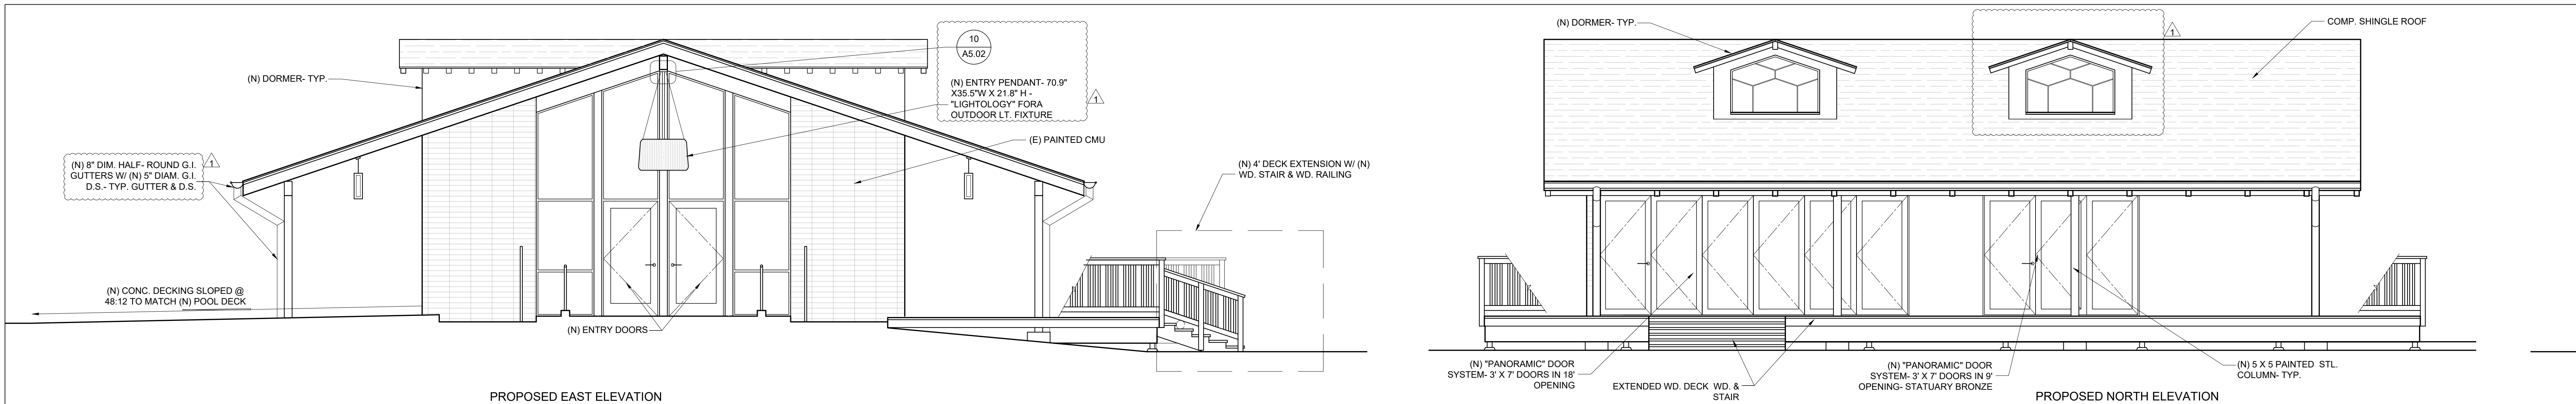

1 PROPOSED EXTERIOR ELEVATIONS
1/4" = 1'-0"


2 PROPOSED EXTERIOR ELEVATIONS
1/4" = 1'-0"

Revisions:
07/20/18
01/28/19
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12/24/20 ASA/ PLANNING REV.


PROPOSED FITNESS
CENTER EXTERIOR
ELEVATIONS

DATE 7/9/18
SCALE 1/4" = 1'-0"
DRAWN: ek


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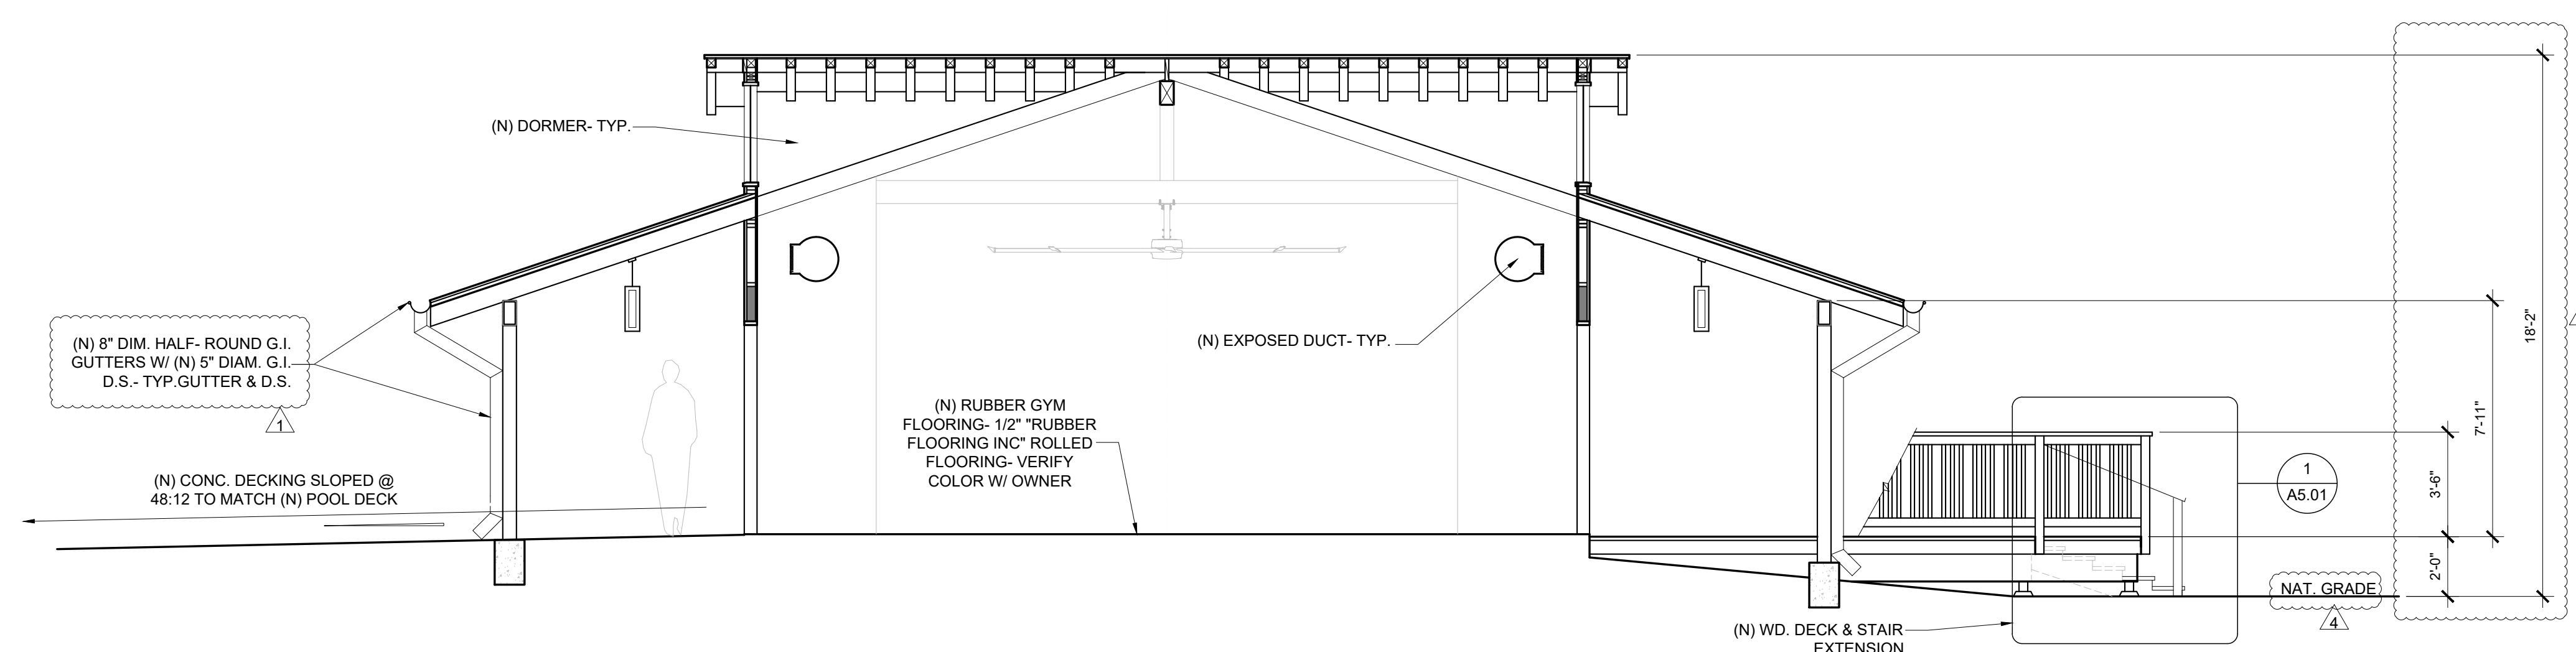
1 PROPOSED LOUNGE PAVILION EXTERIOR ELEVATIONS
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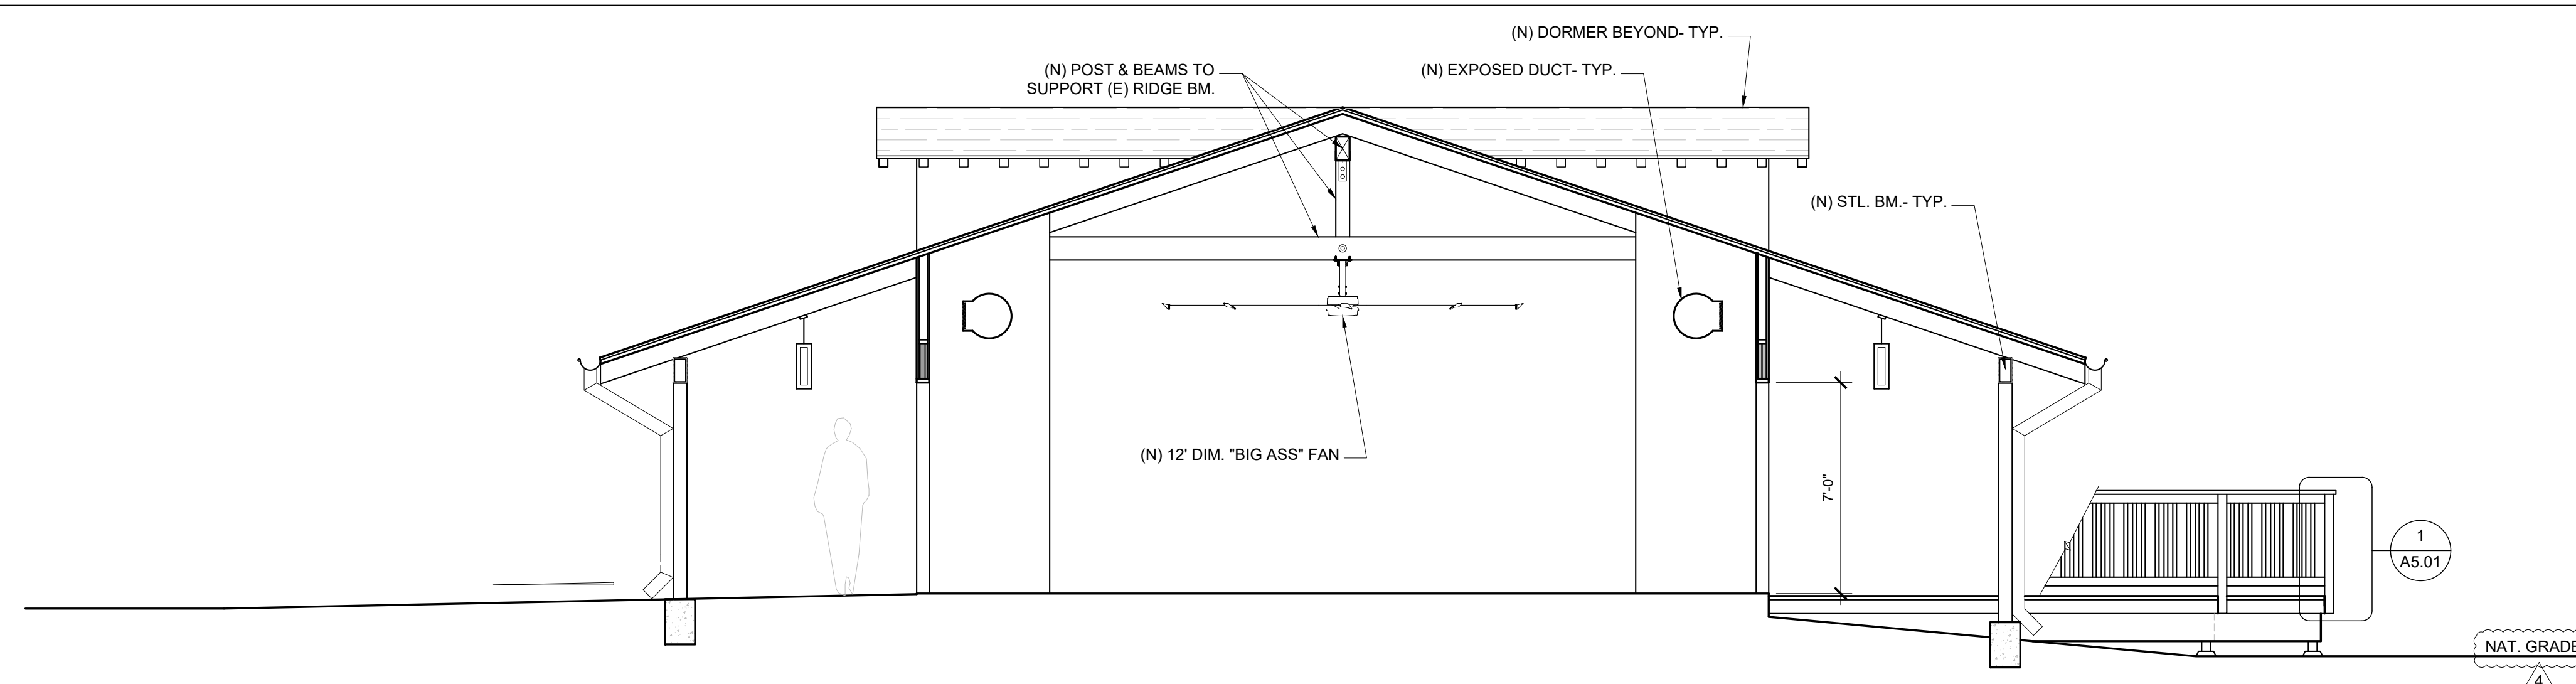
2 PROPOSED KITCHEN PAVILION EXTERIOR ELEVATIONS
1/4" = 1'-0"

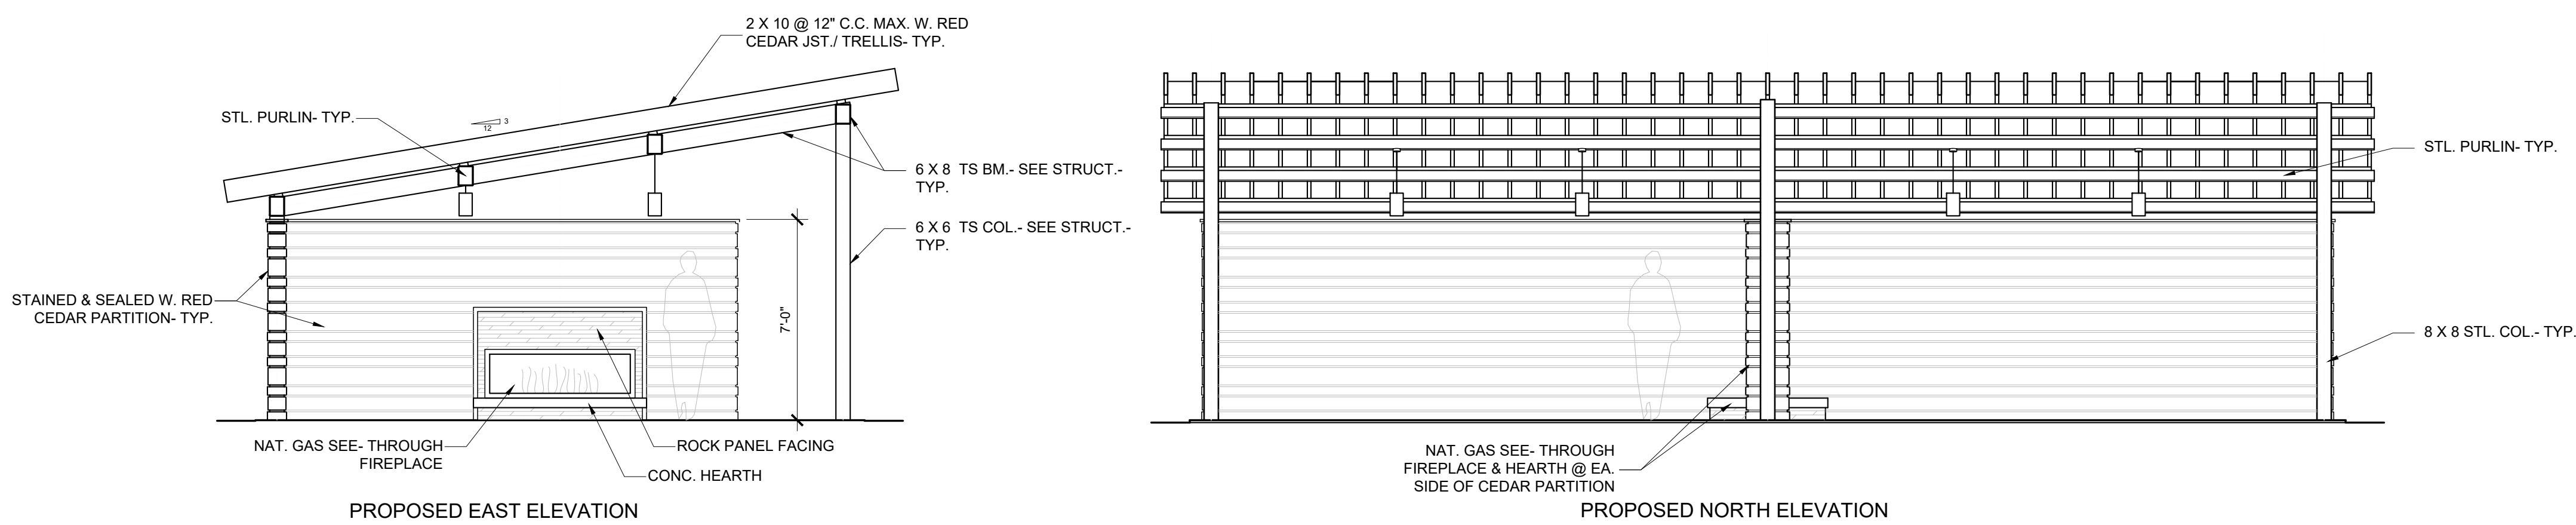


A-A PROPOSED BUILDING SECTION
1/4" = 1'-0"

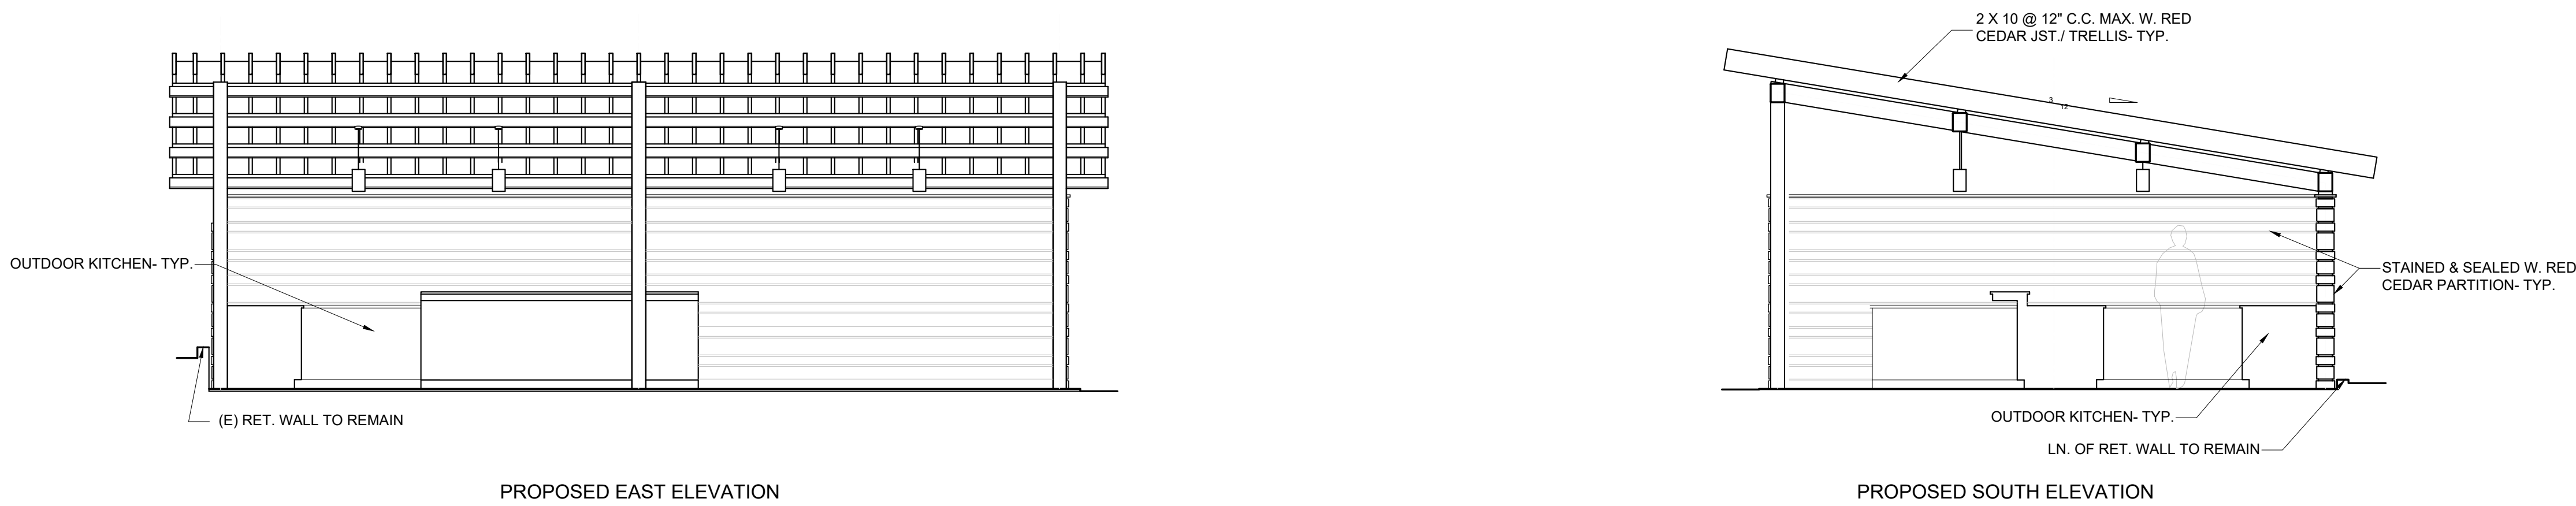

B-B PROPOSED BUILDING SECTION
1/4" = 1'-0"

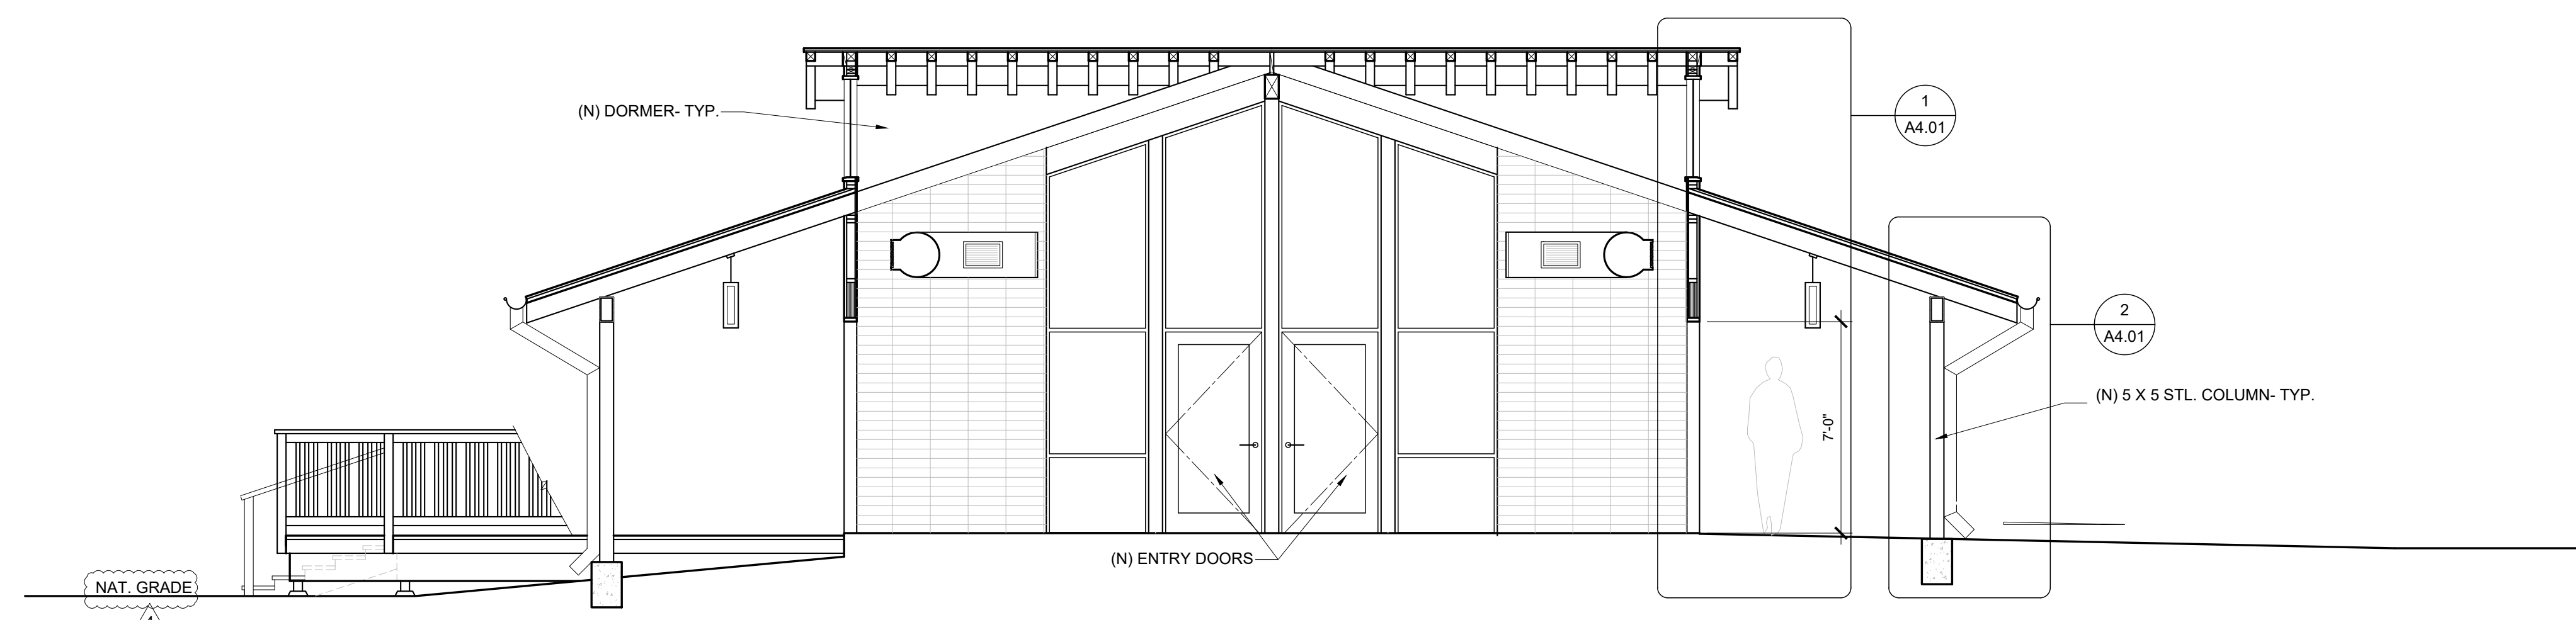

C-C PROPOSED BUILDING SECTION
1/4" = 1'-0"

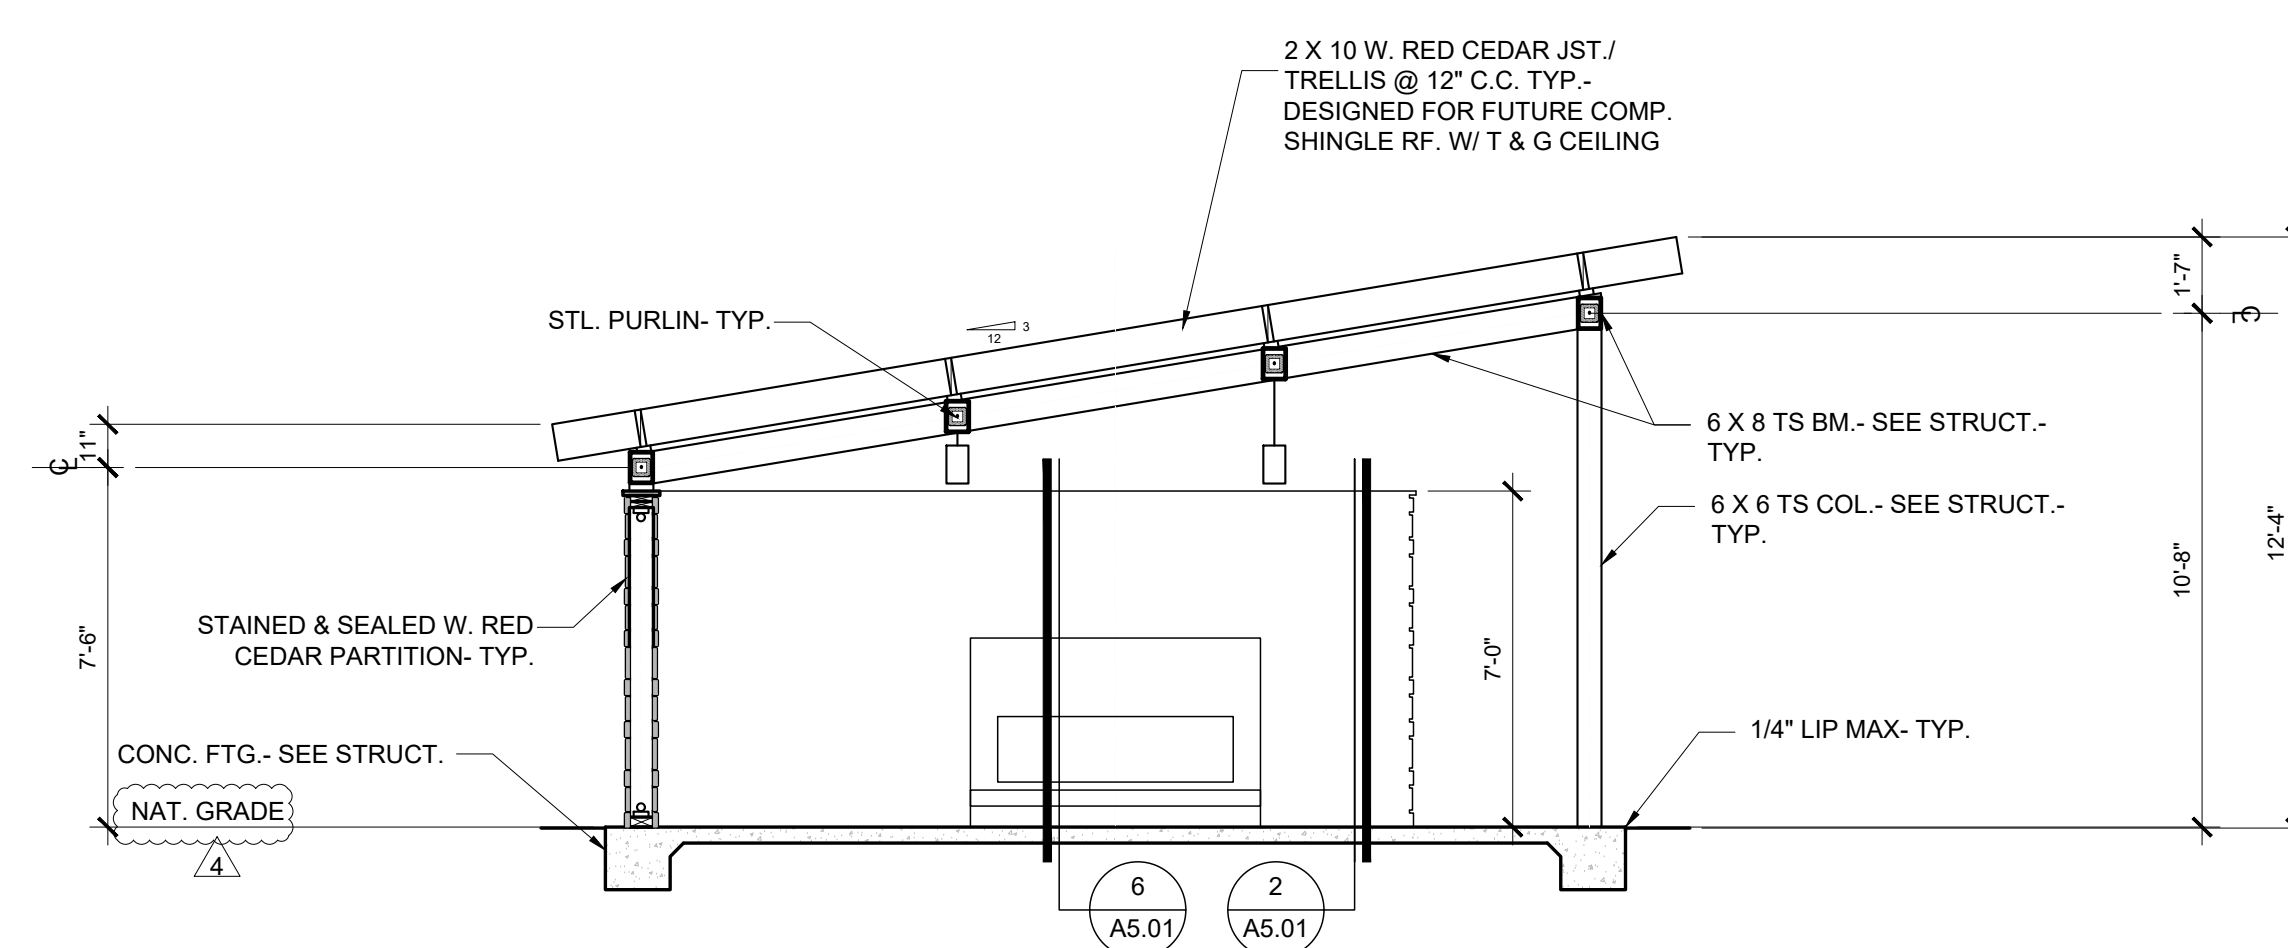

D-D PROPOSED PAVILION SECTION
1/4" = 1'-0"

THE VILLAGES AT CUPERTINO
20875 VALLEY GREEN DRIVE
CUPERTINO, CALIFORNIA







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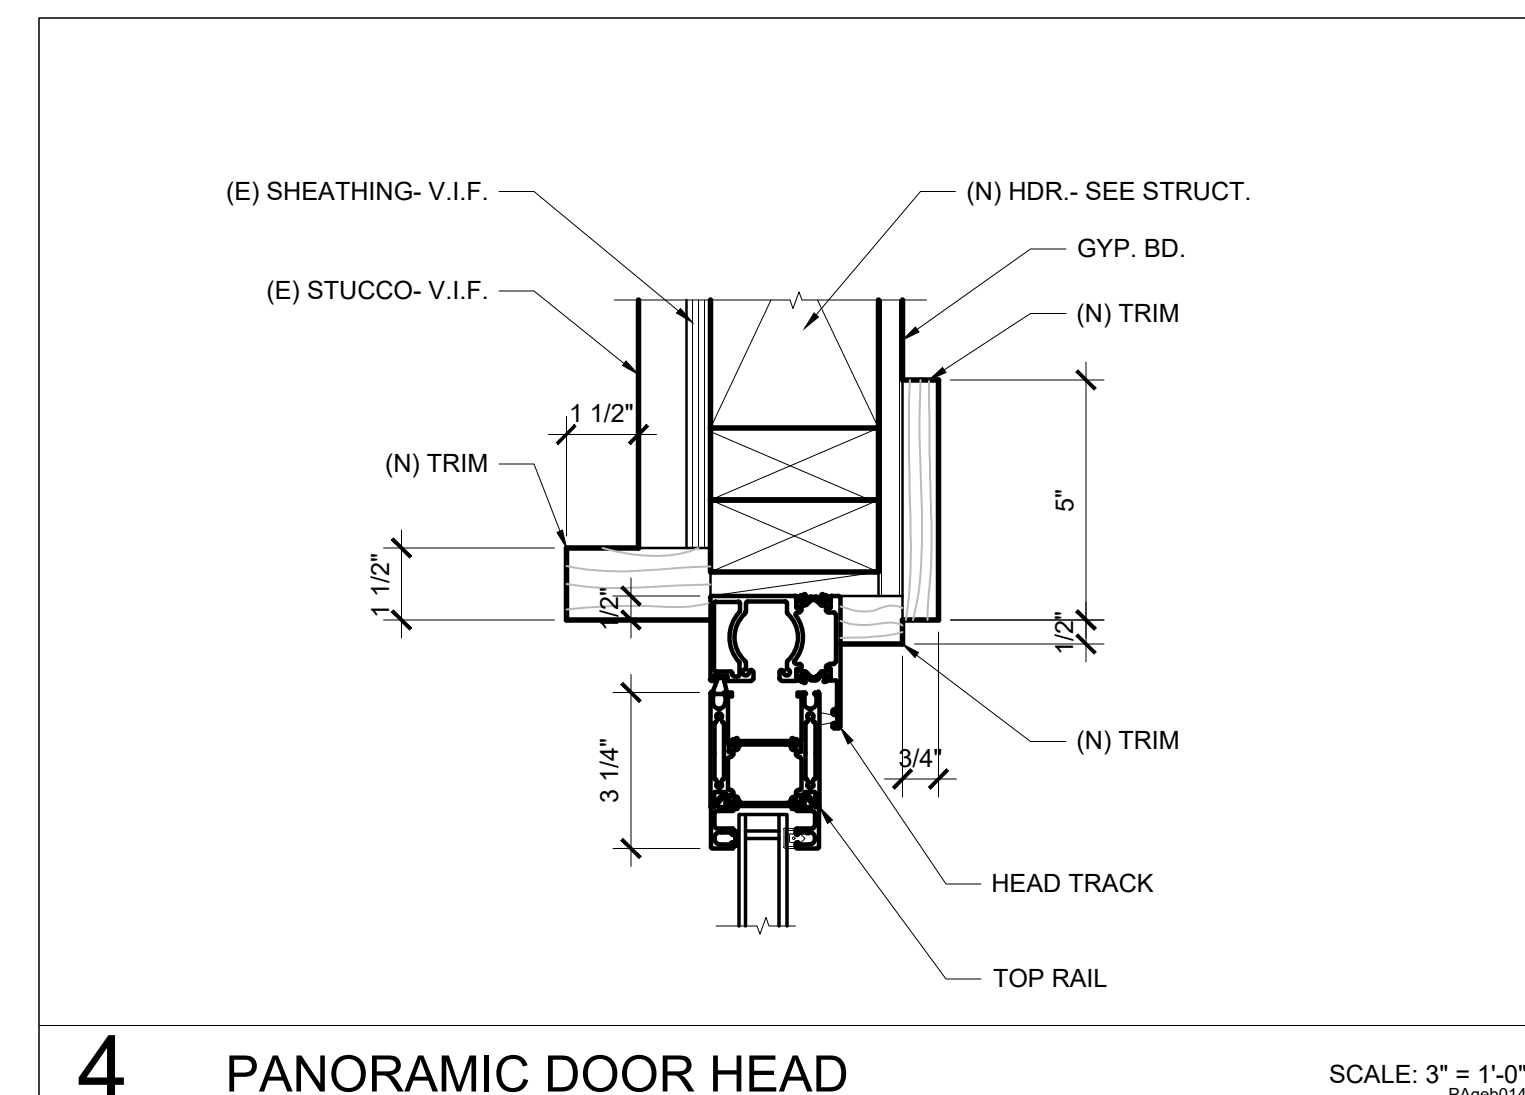
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2	8/12/20 PERMIT/ BUILD. REV.
3	9/25/20 ASA/ PLANNING REV.
4	12/24/20 ASA/ PLANNING REV.

FITNESS CENTER PROPOSED WALL SECTIONS

DATE: 7/9/18
SCALE: 3/4" = 1'-0"
DRAWN: ek

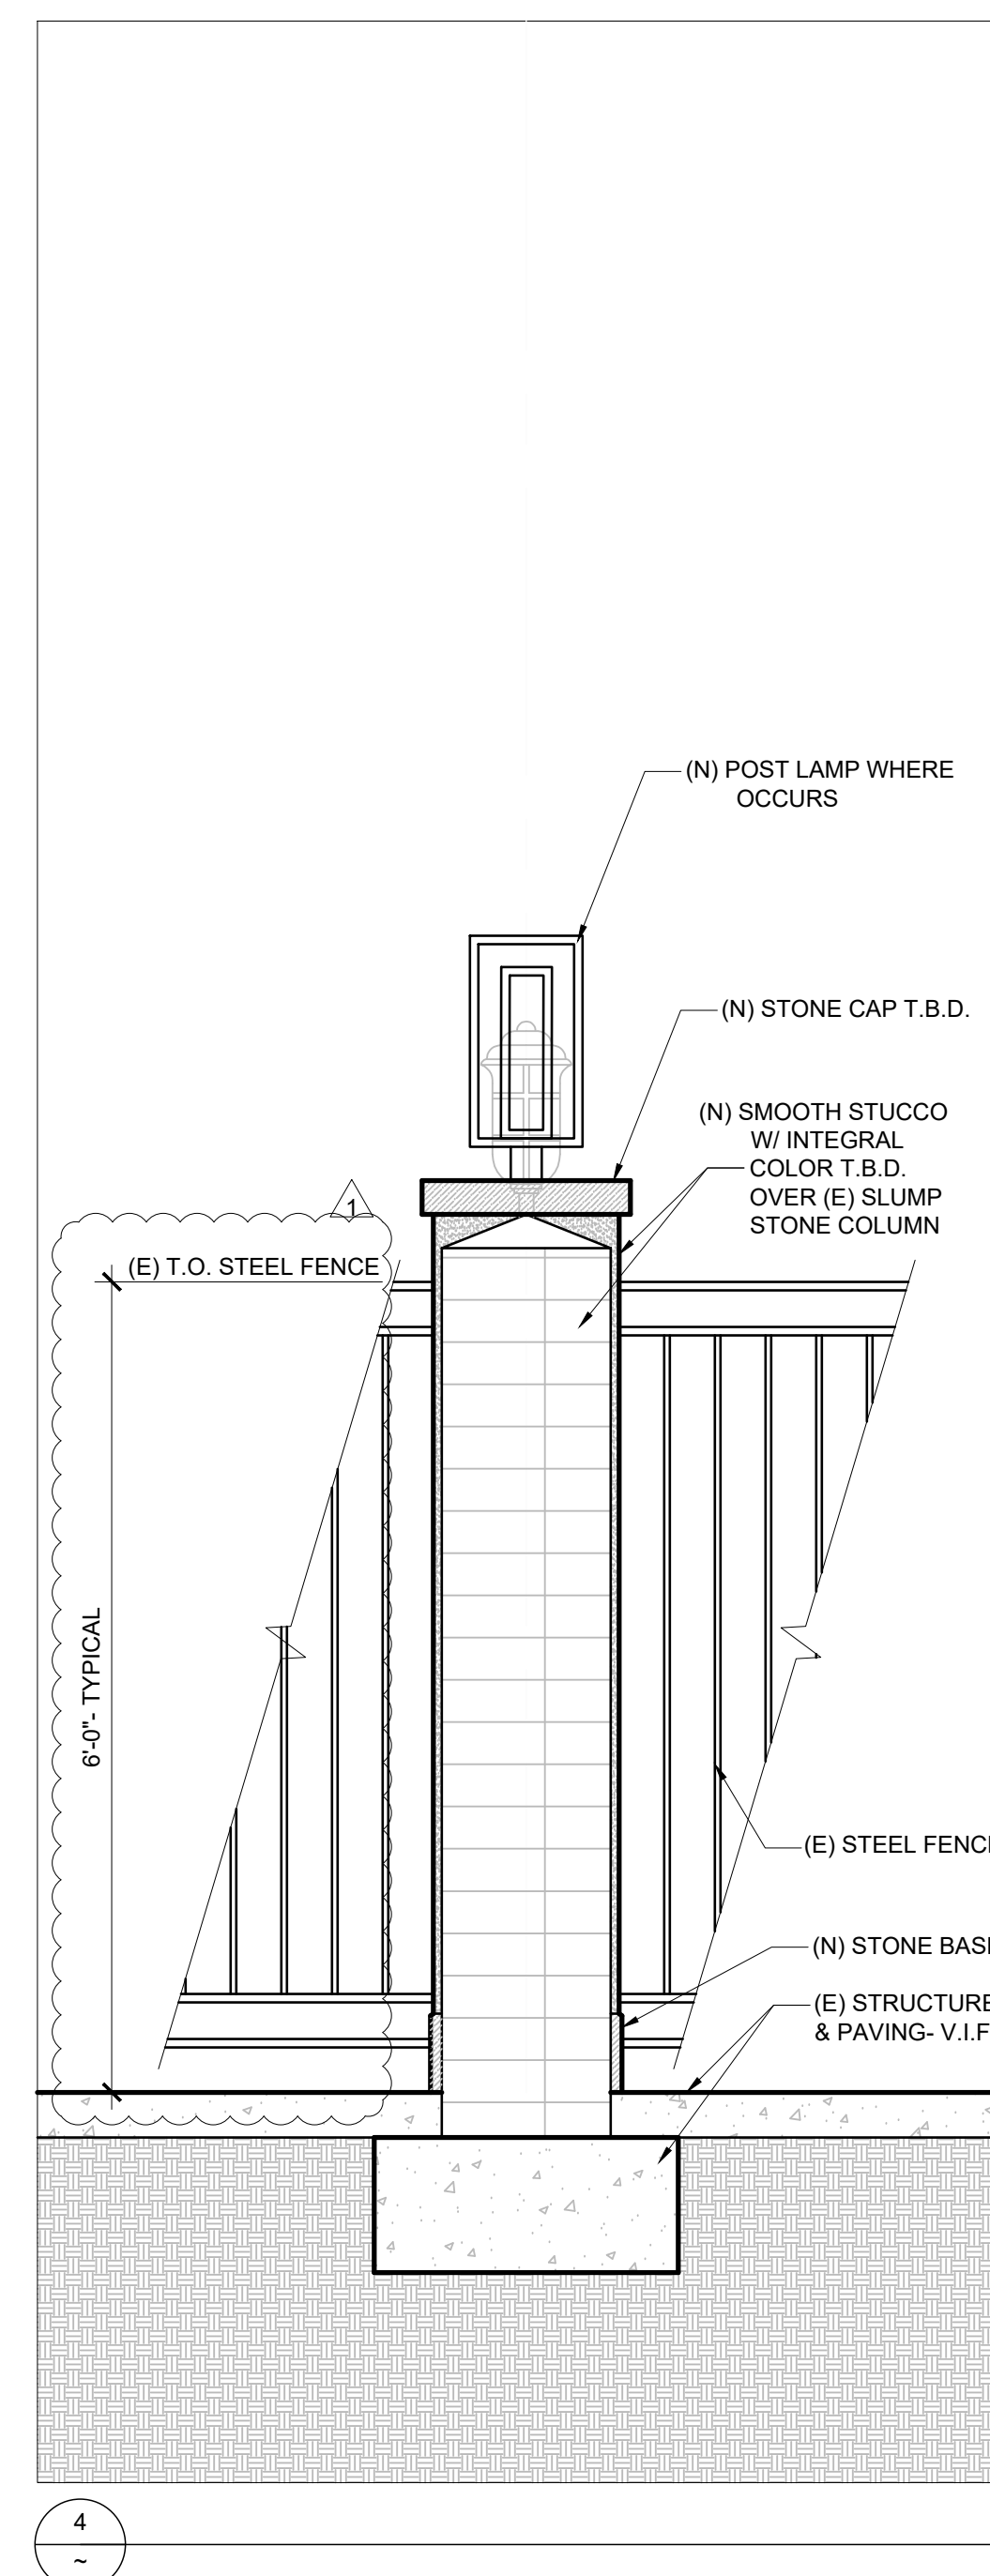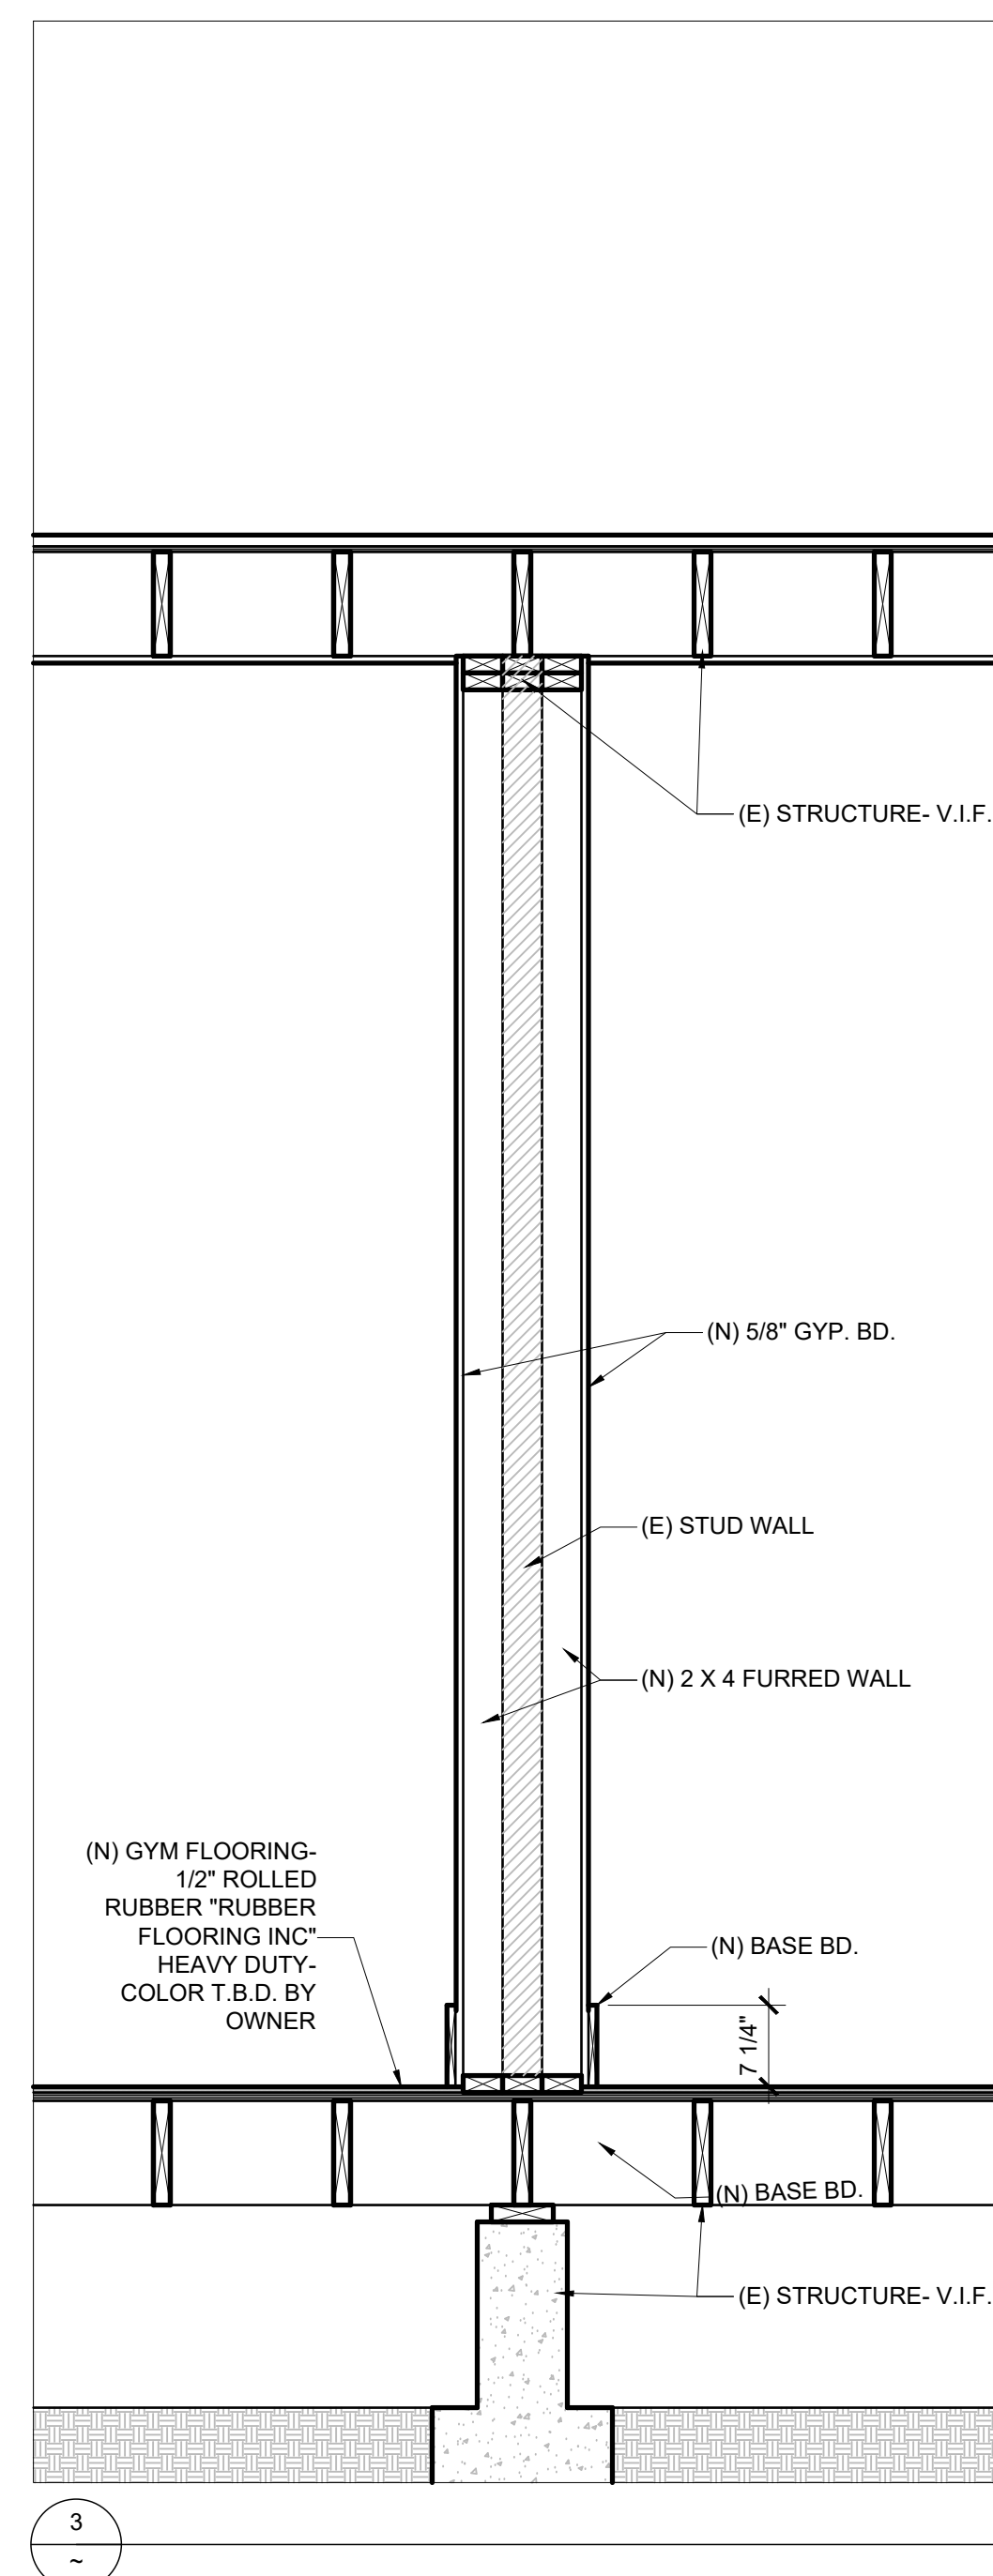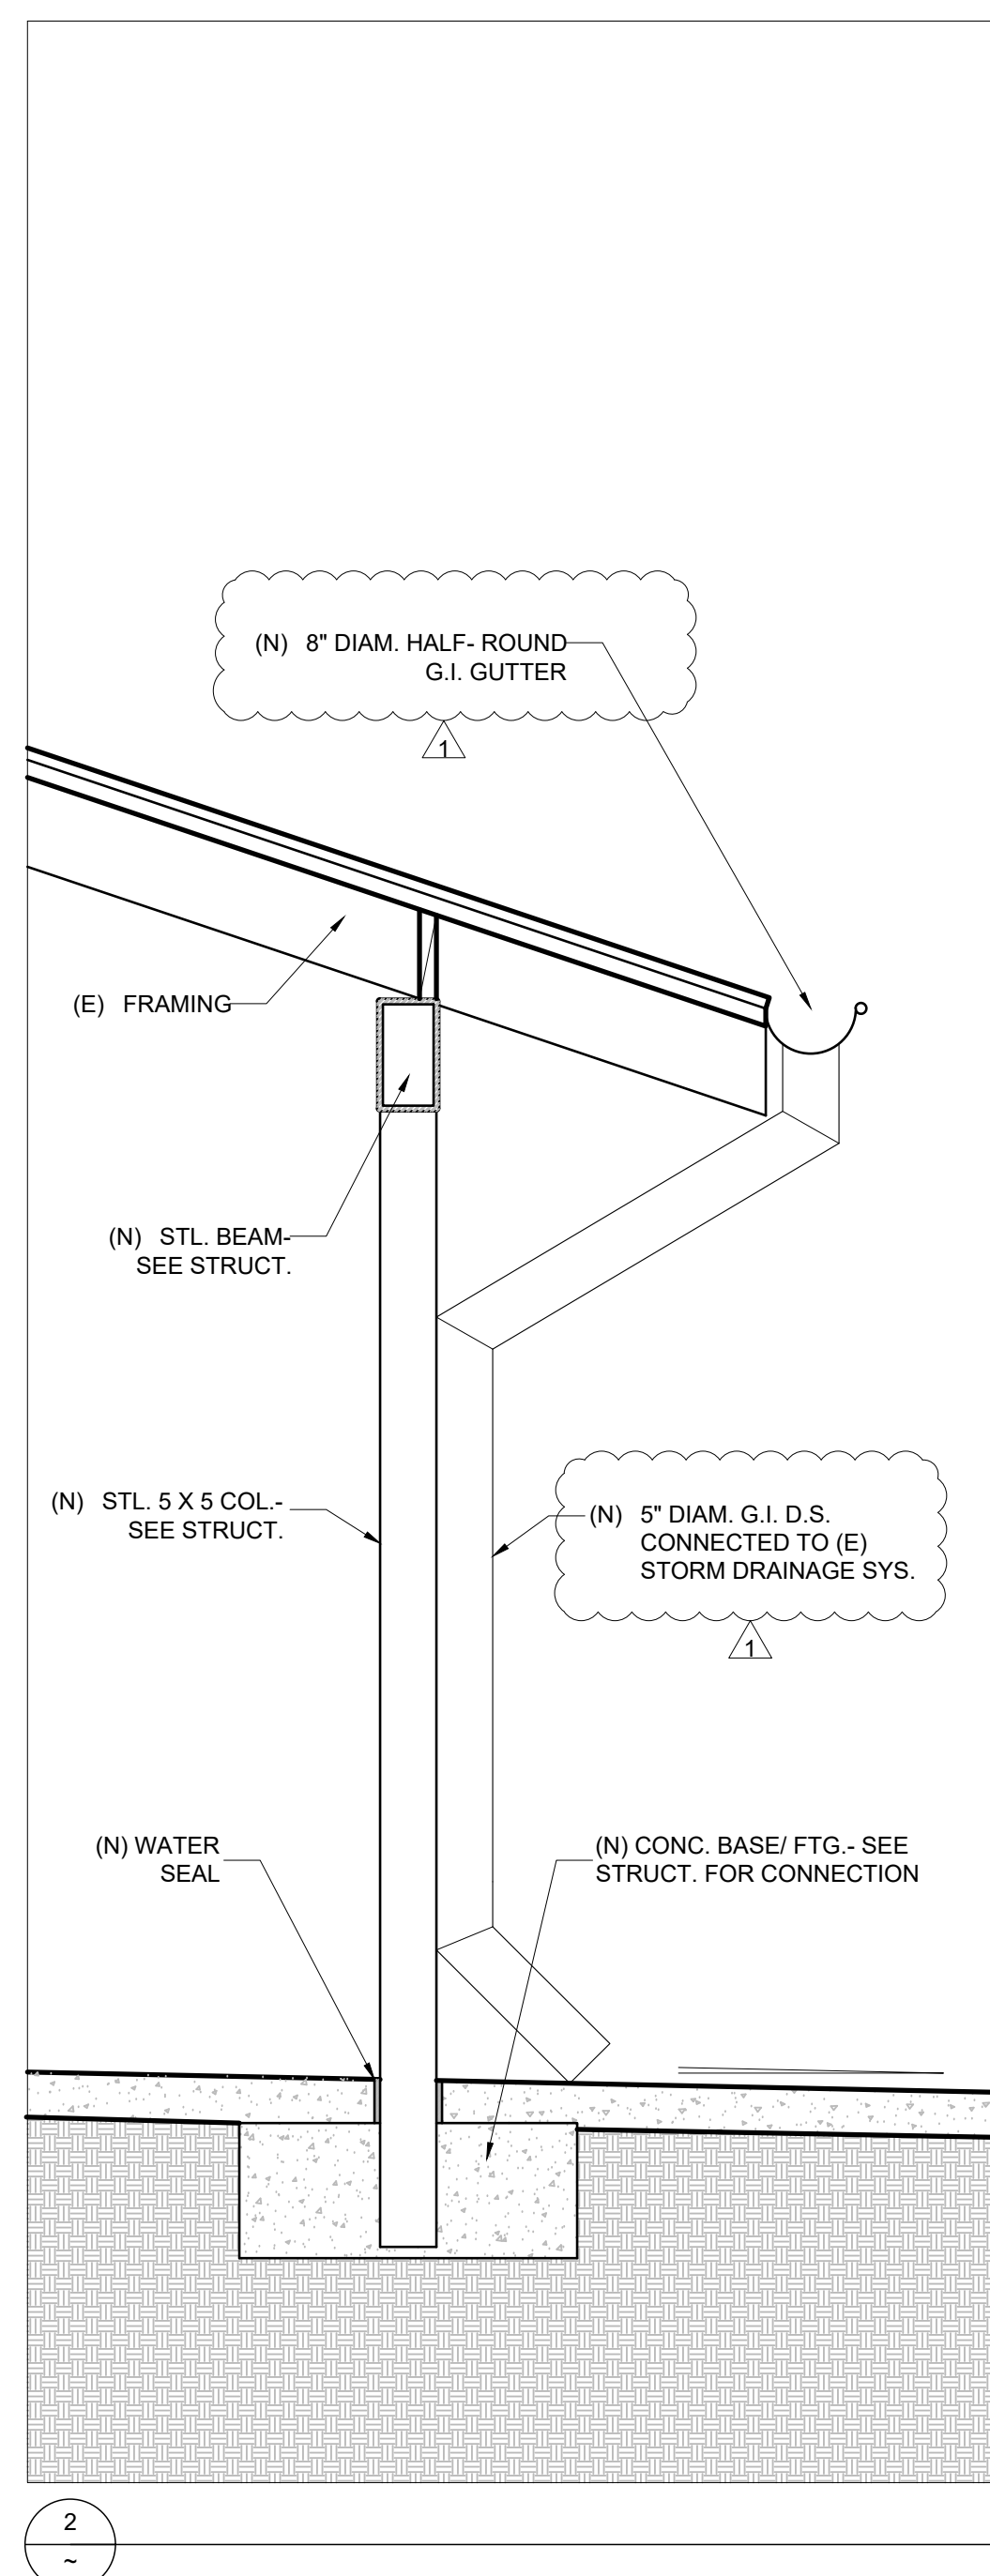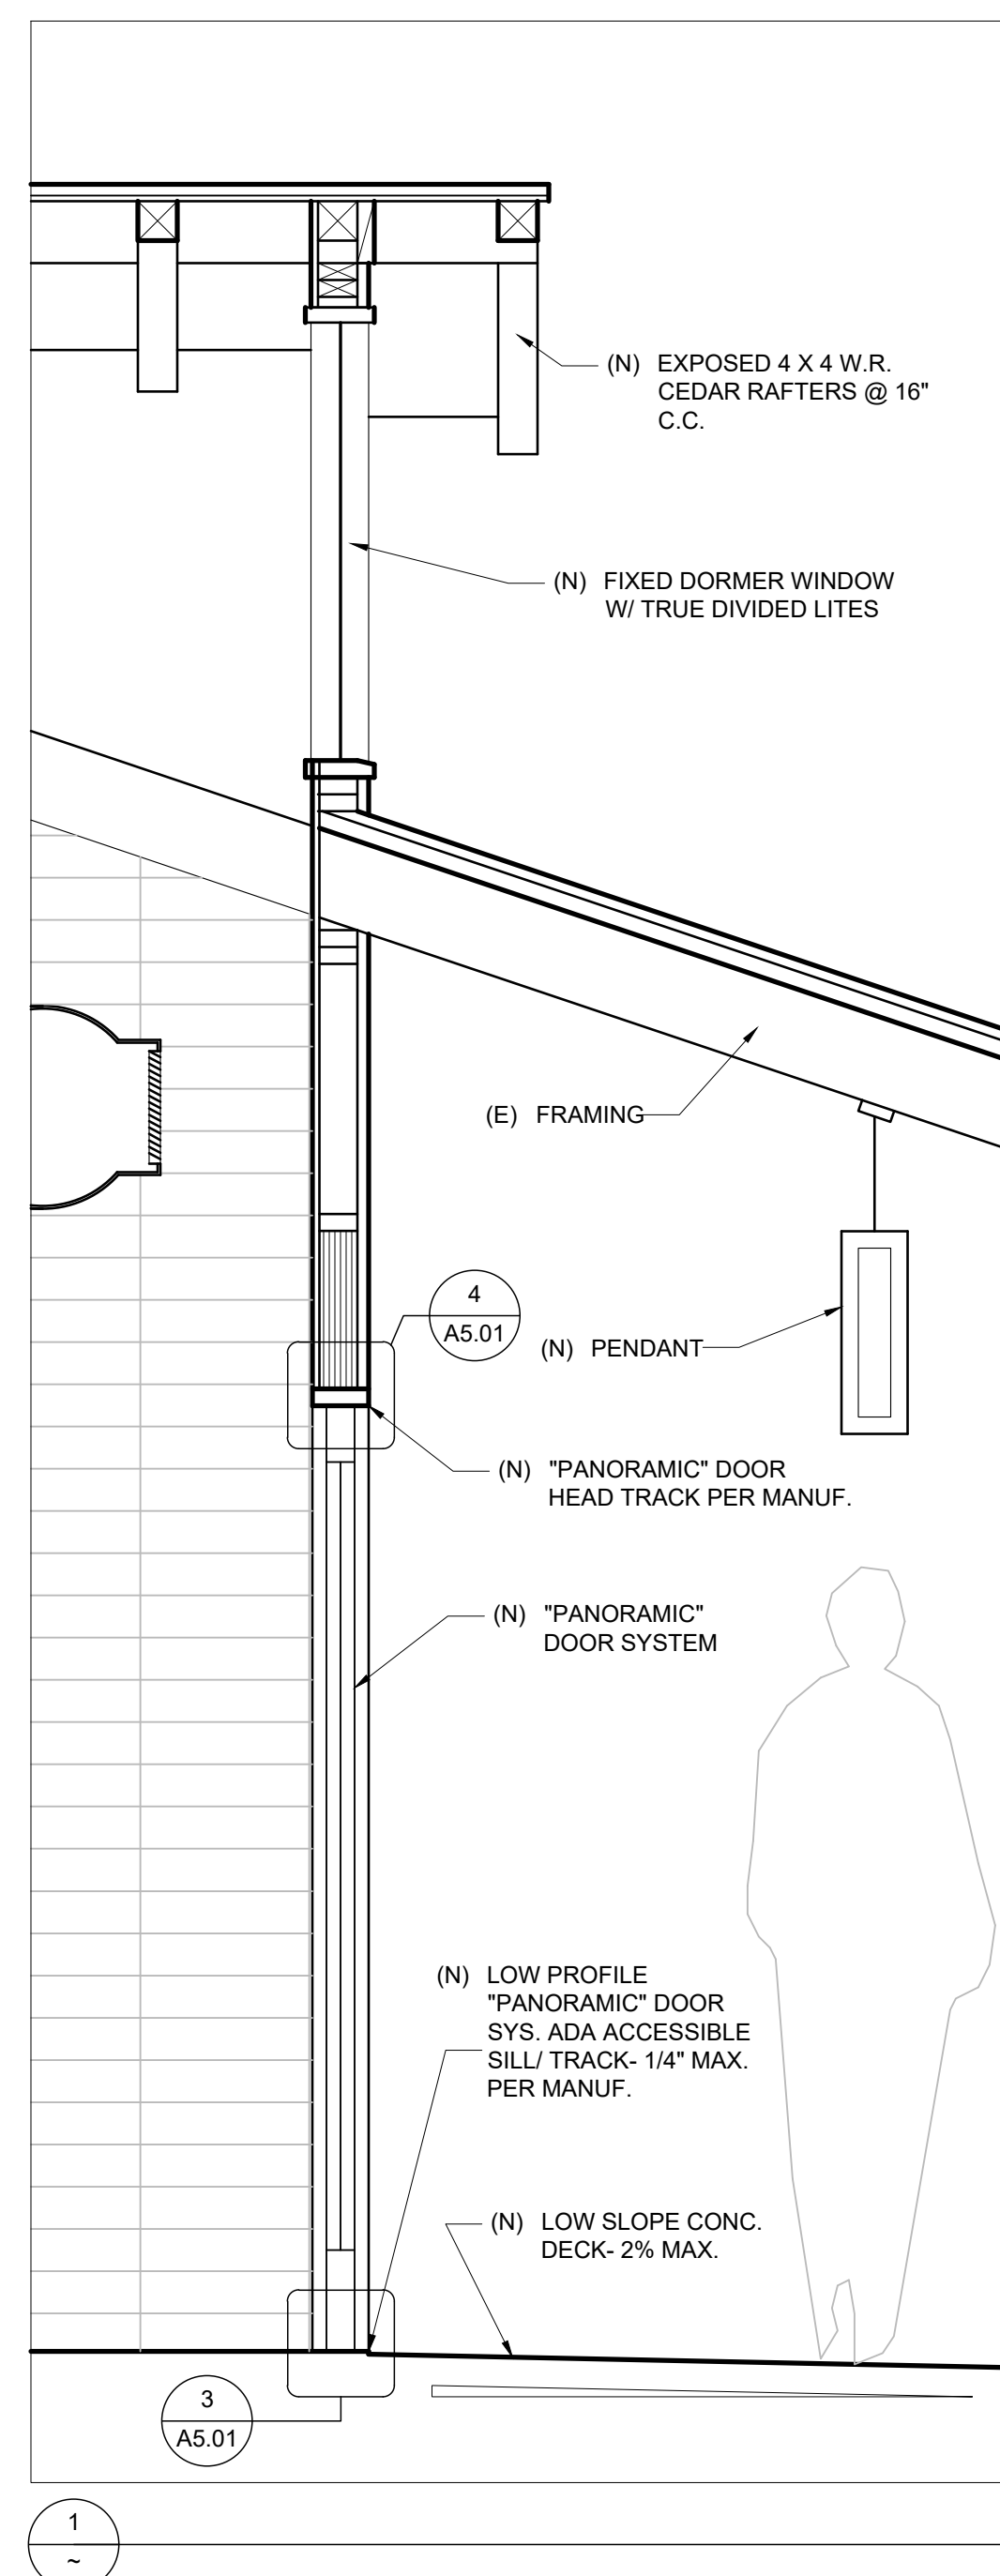


1 PROPOSED WALL/ COLUMN SECTIONS




4 PANORAMIC DOOR HEAD

SCALE: 3" = 1'-0"
VgC460014

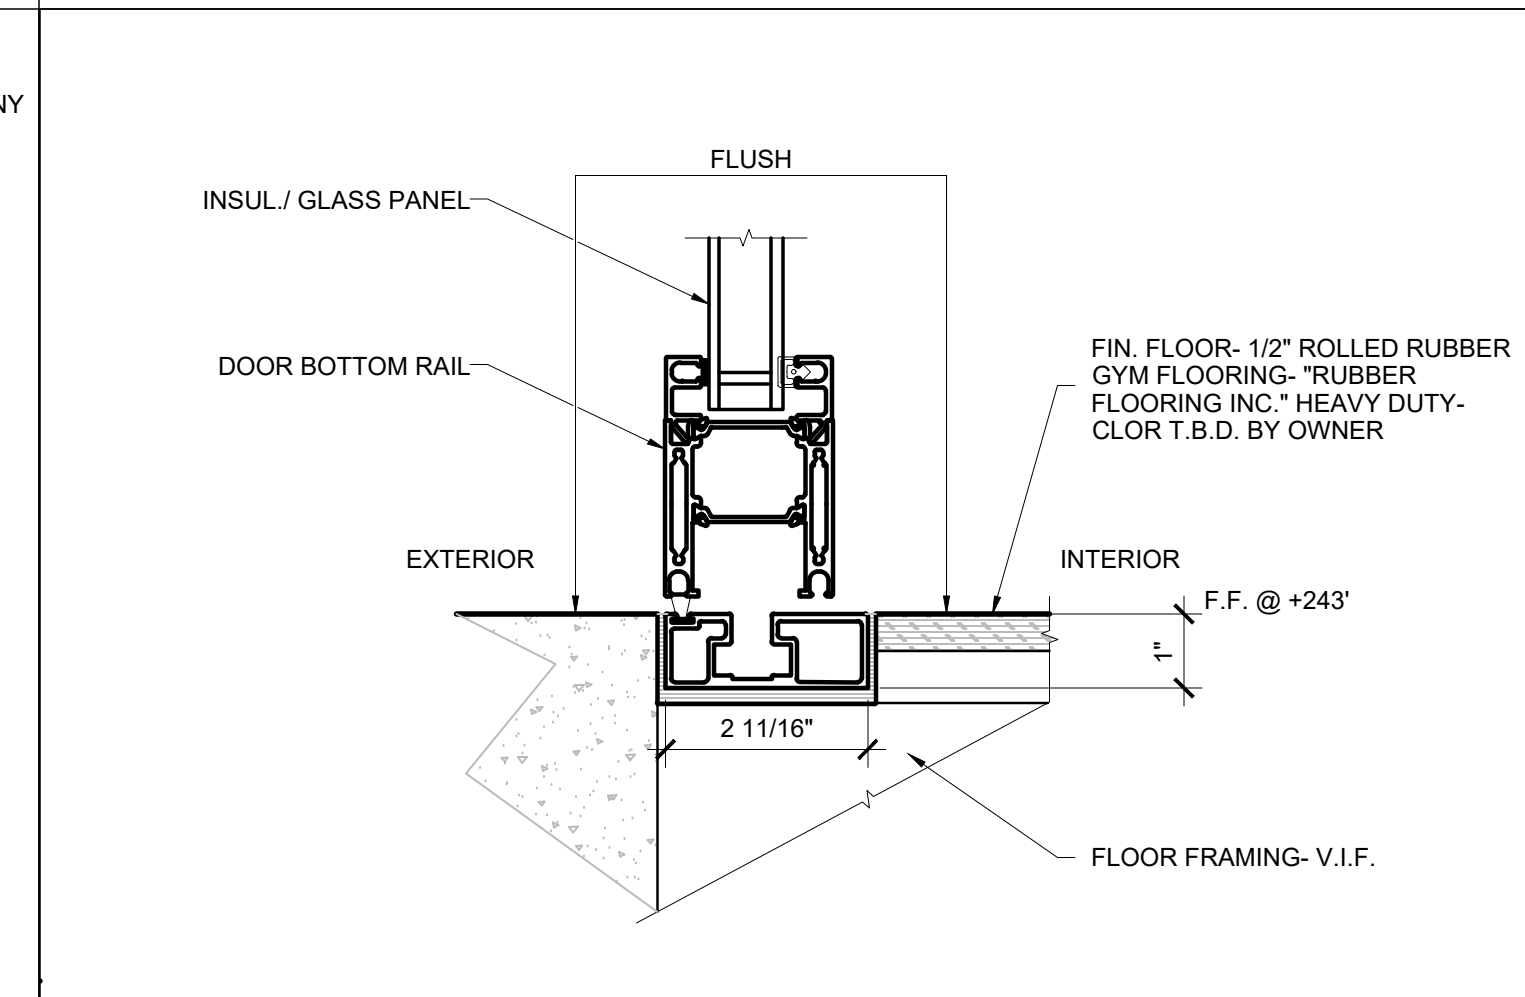


3 PANORAMIC DOOR SILL

N.T.S.
VgC46001

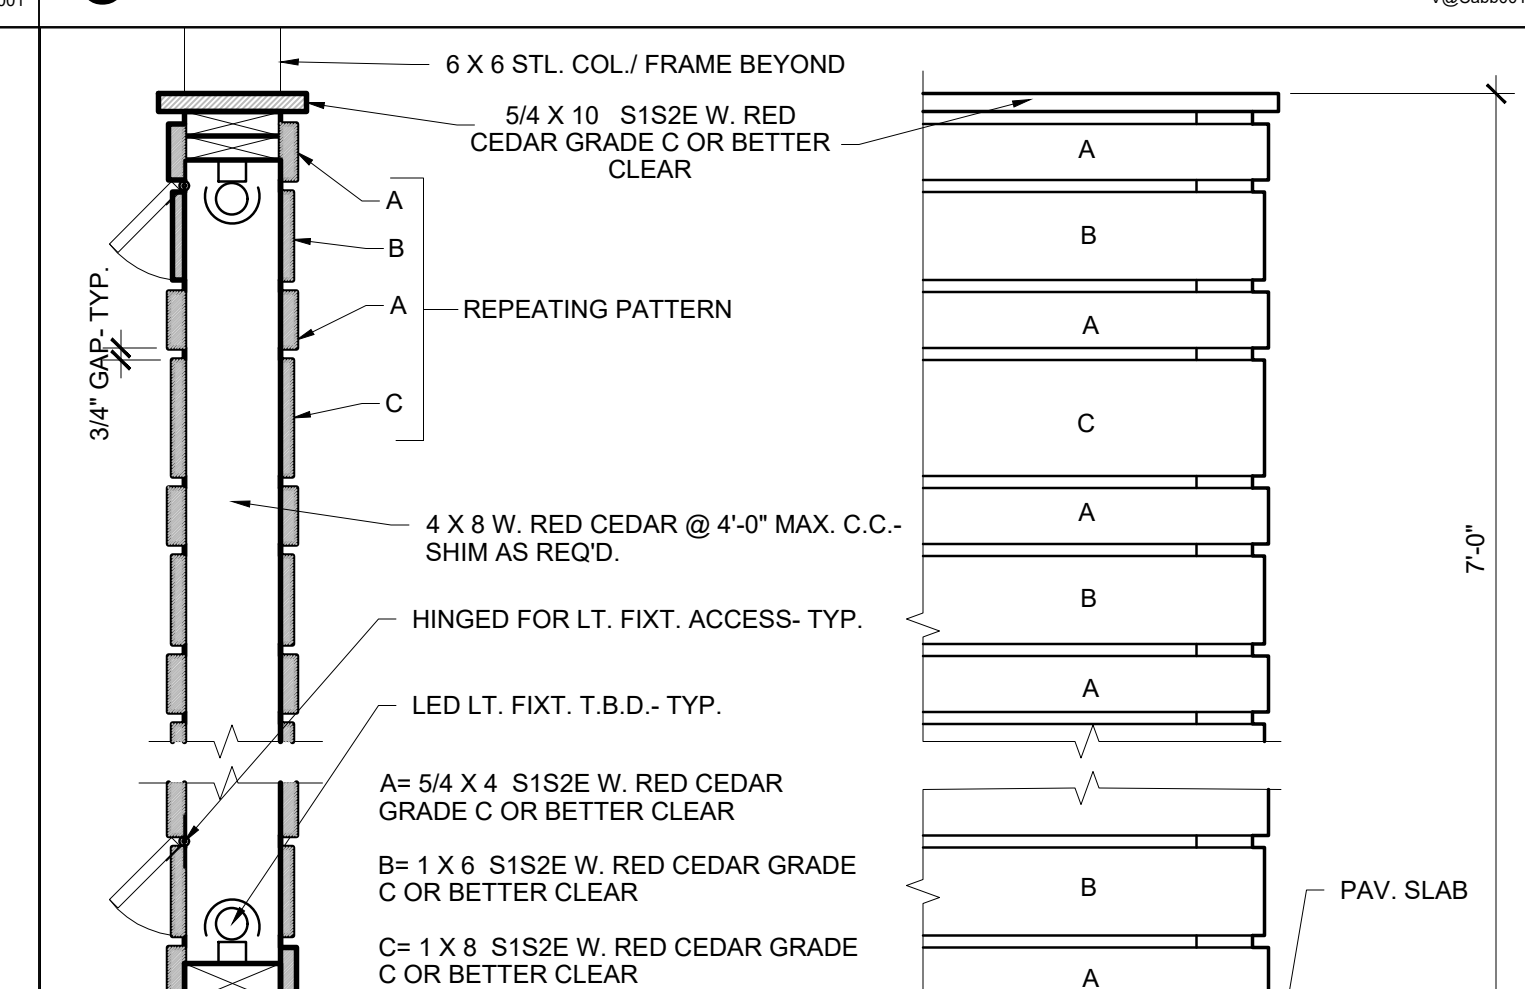


2 (N) PAVILION PARTITION WALL

SCALE: 1" = 1'-0"
VgC46001

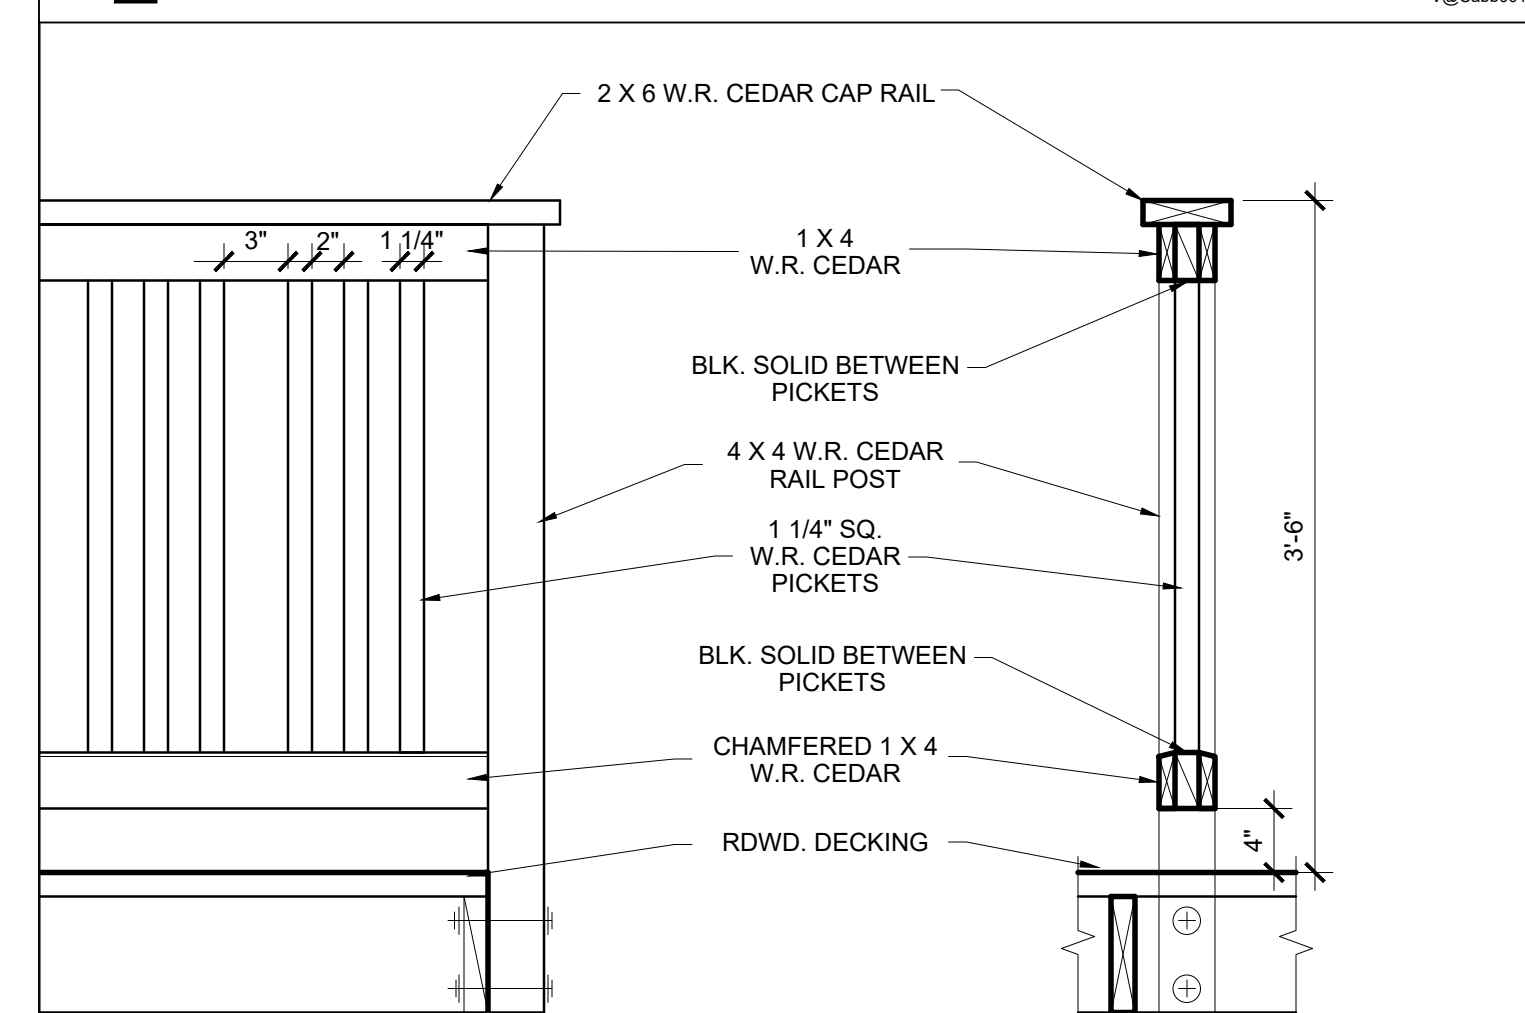


1 (N) DECK GUARDRAIL

SCALE: 1" = 1'-0"
VgC46001

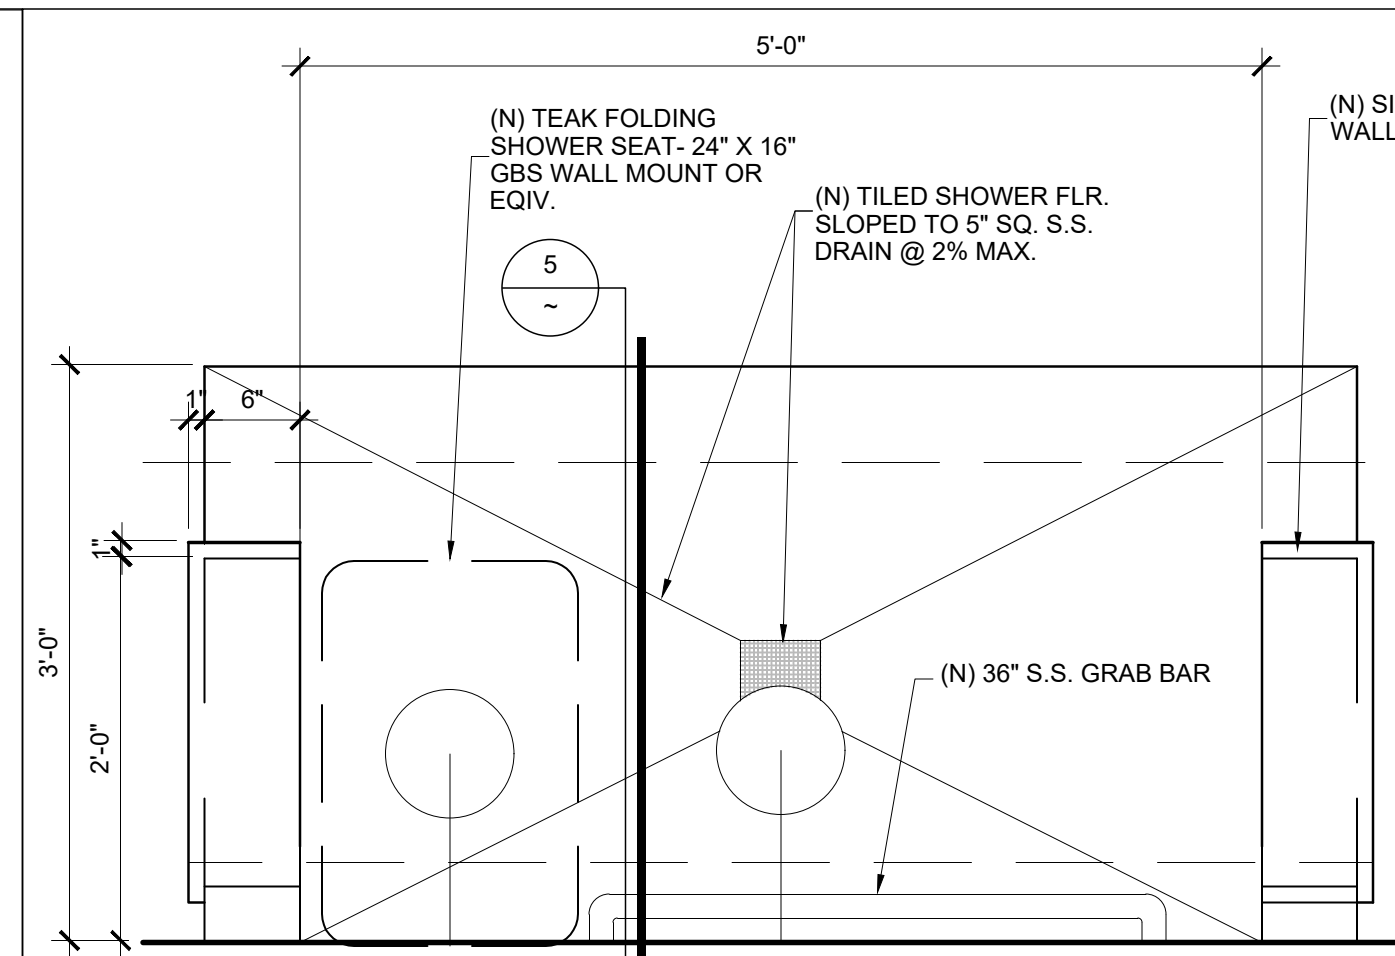


7 (N) POOL RINSE SHOWER DETAIL PLAN

SCALE: 1" = 1'-0"
VgC46001

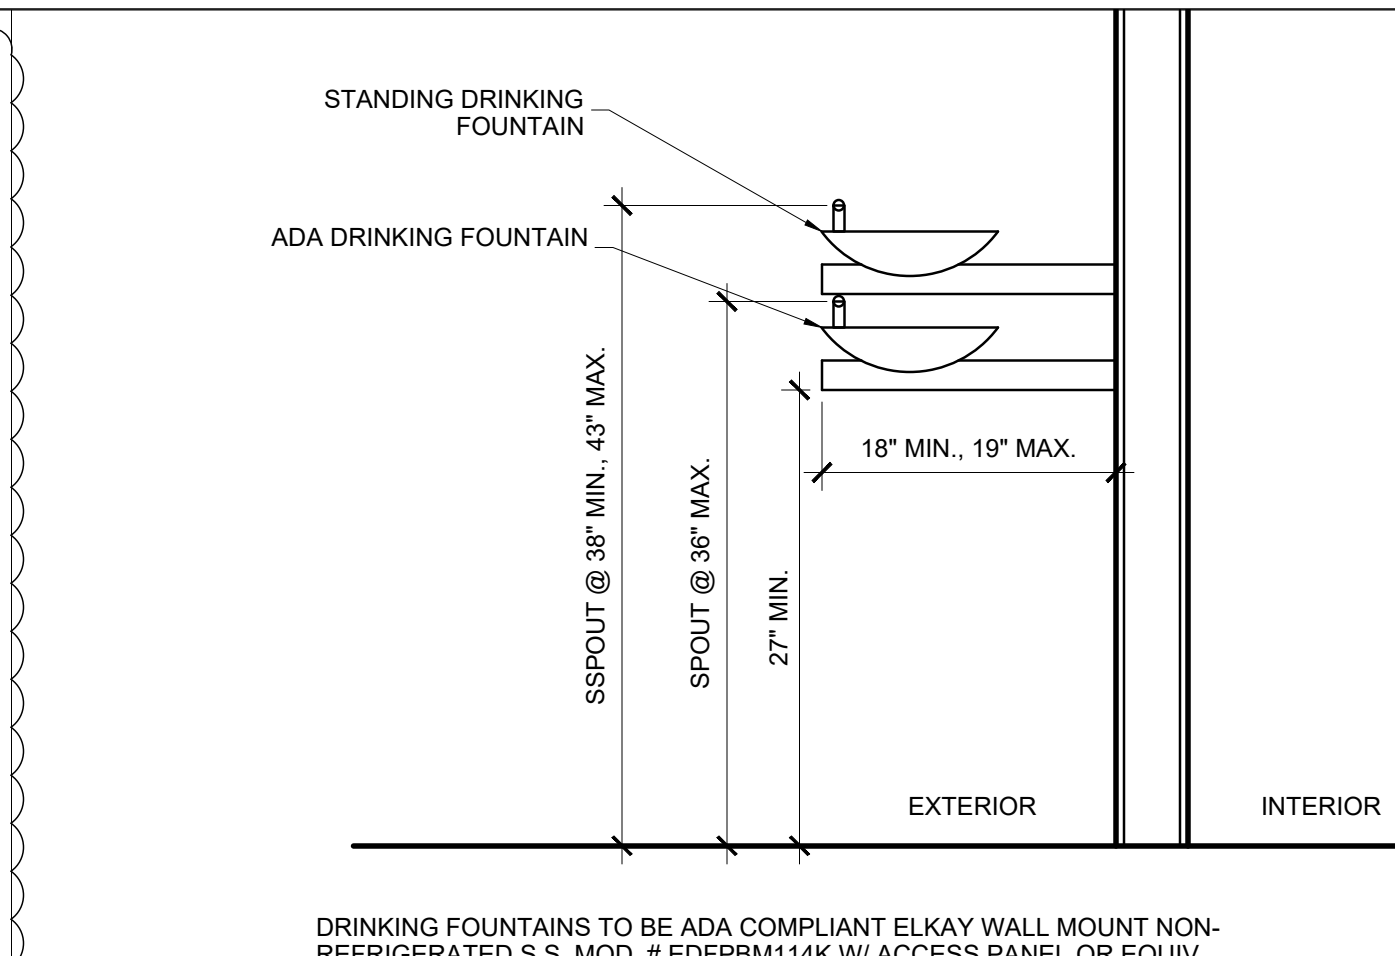


8 (N) DRINKING FOUNTAINS

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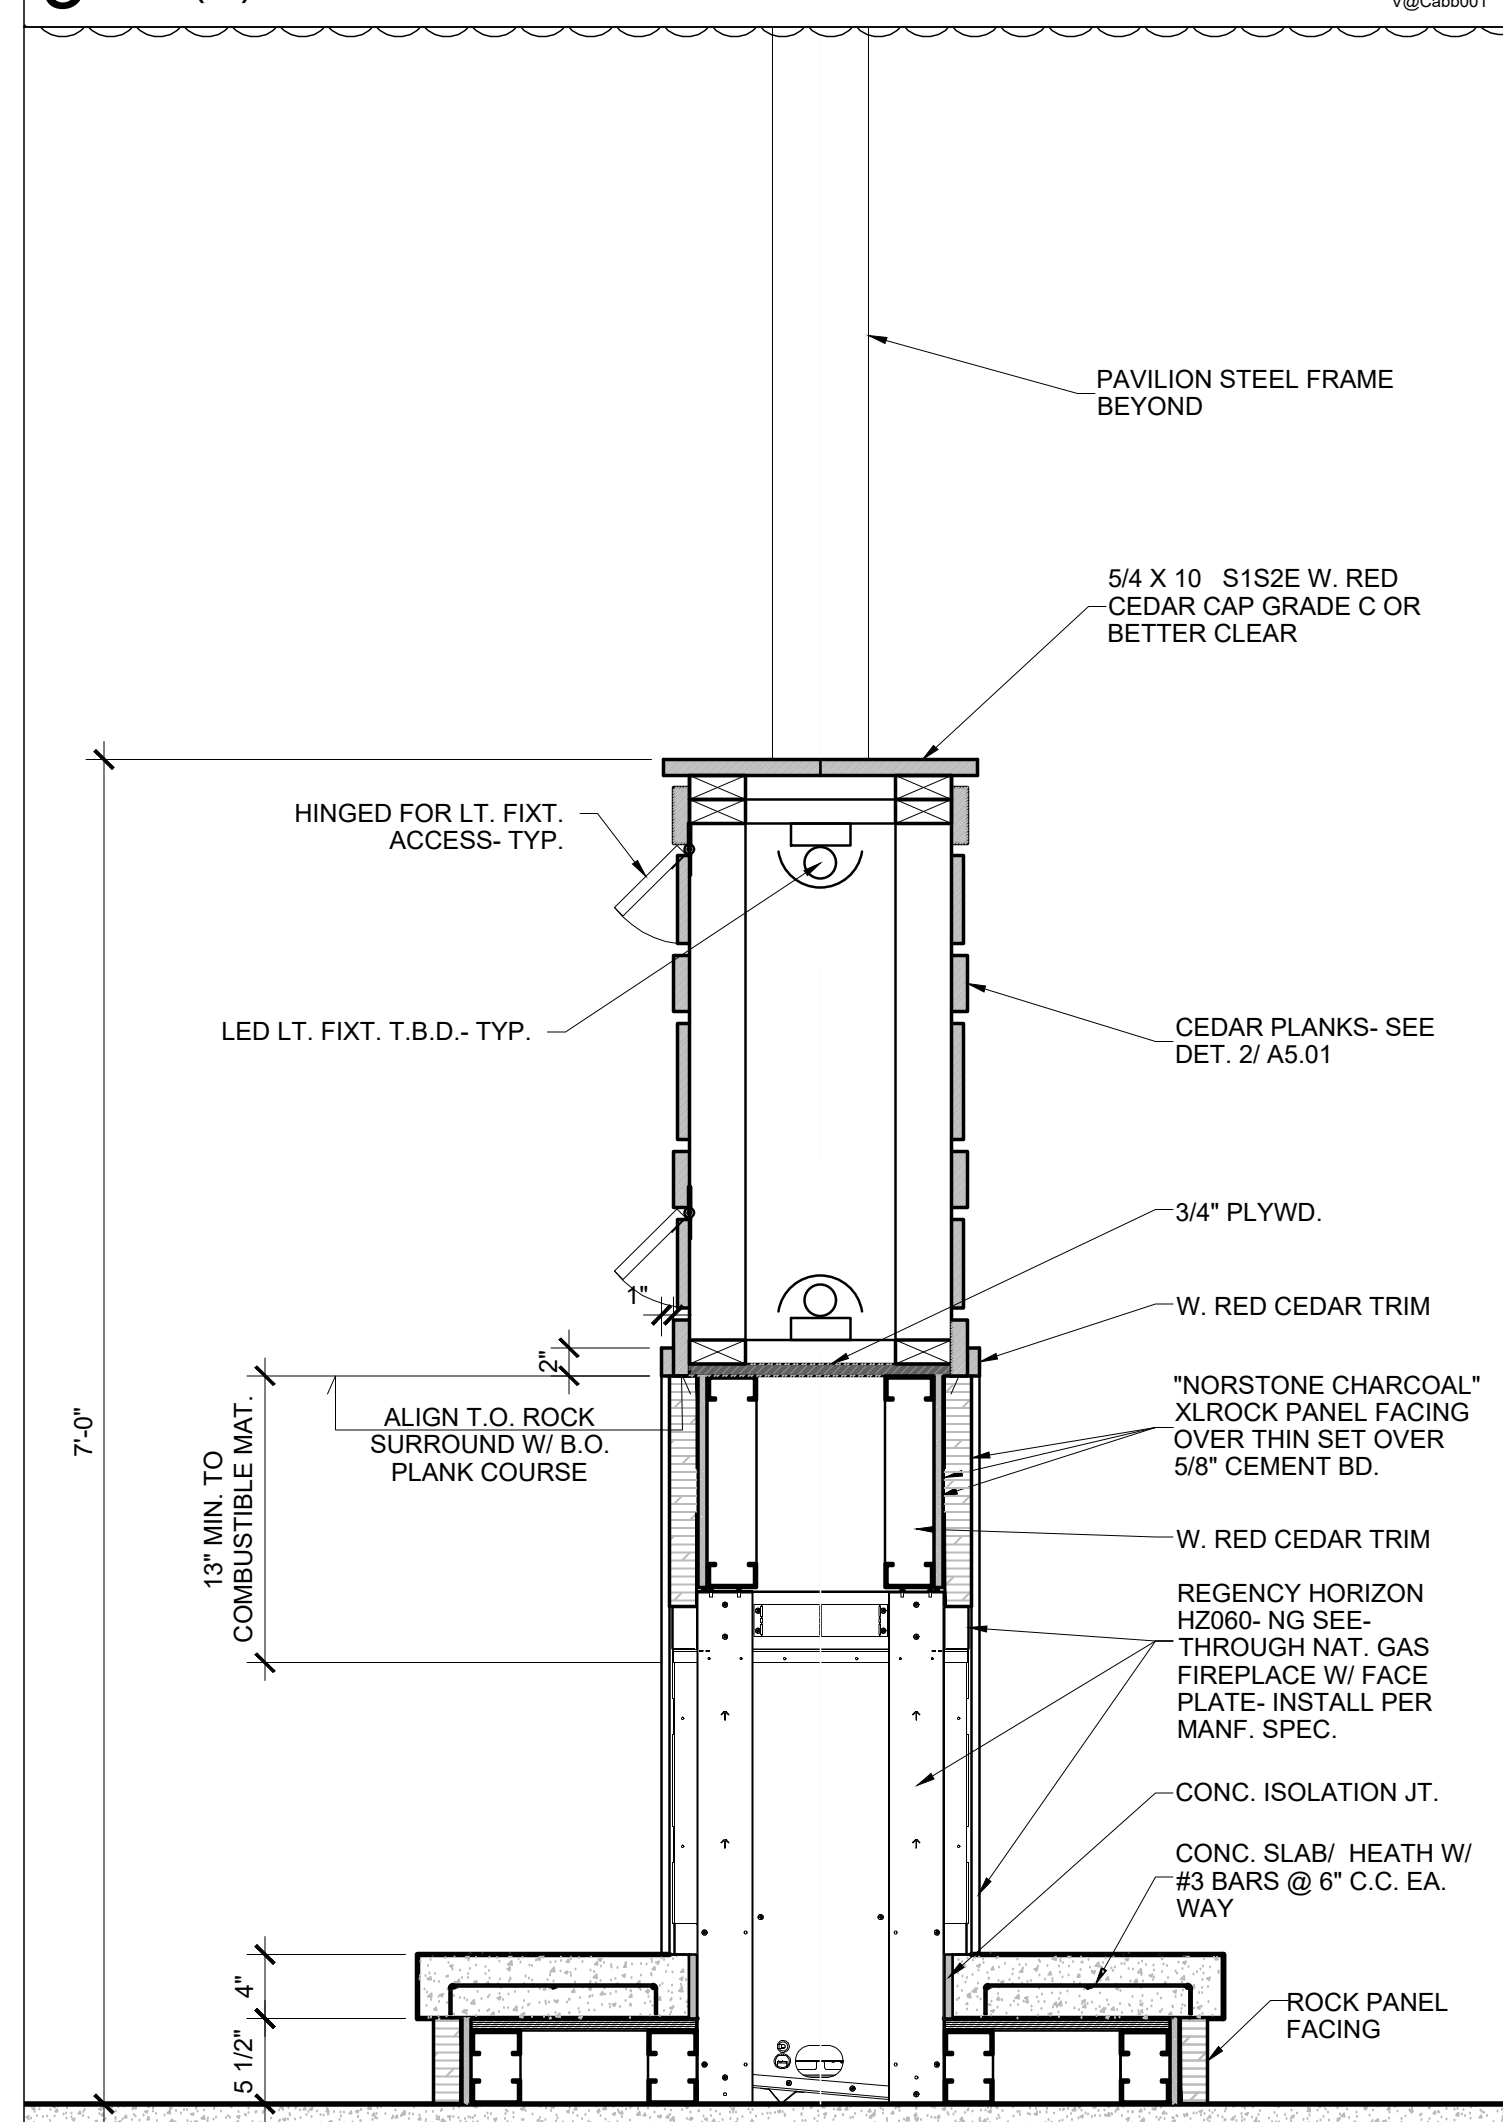


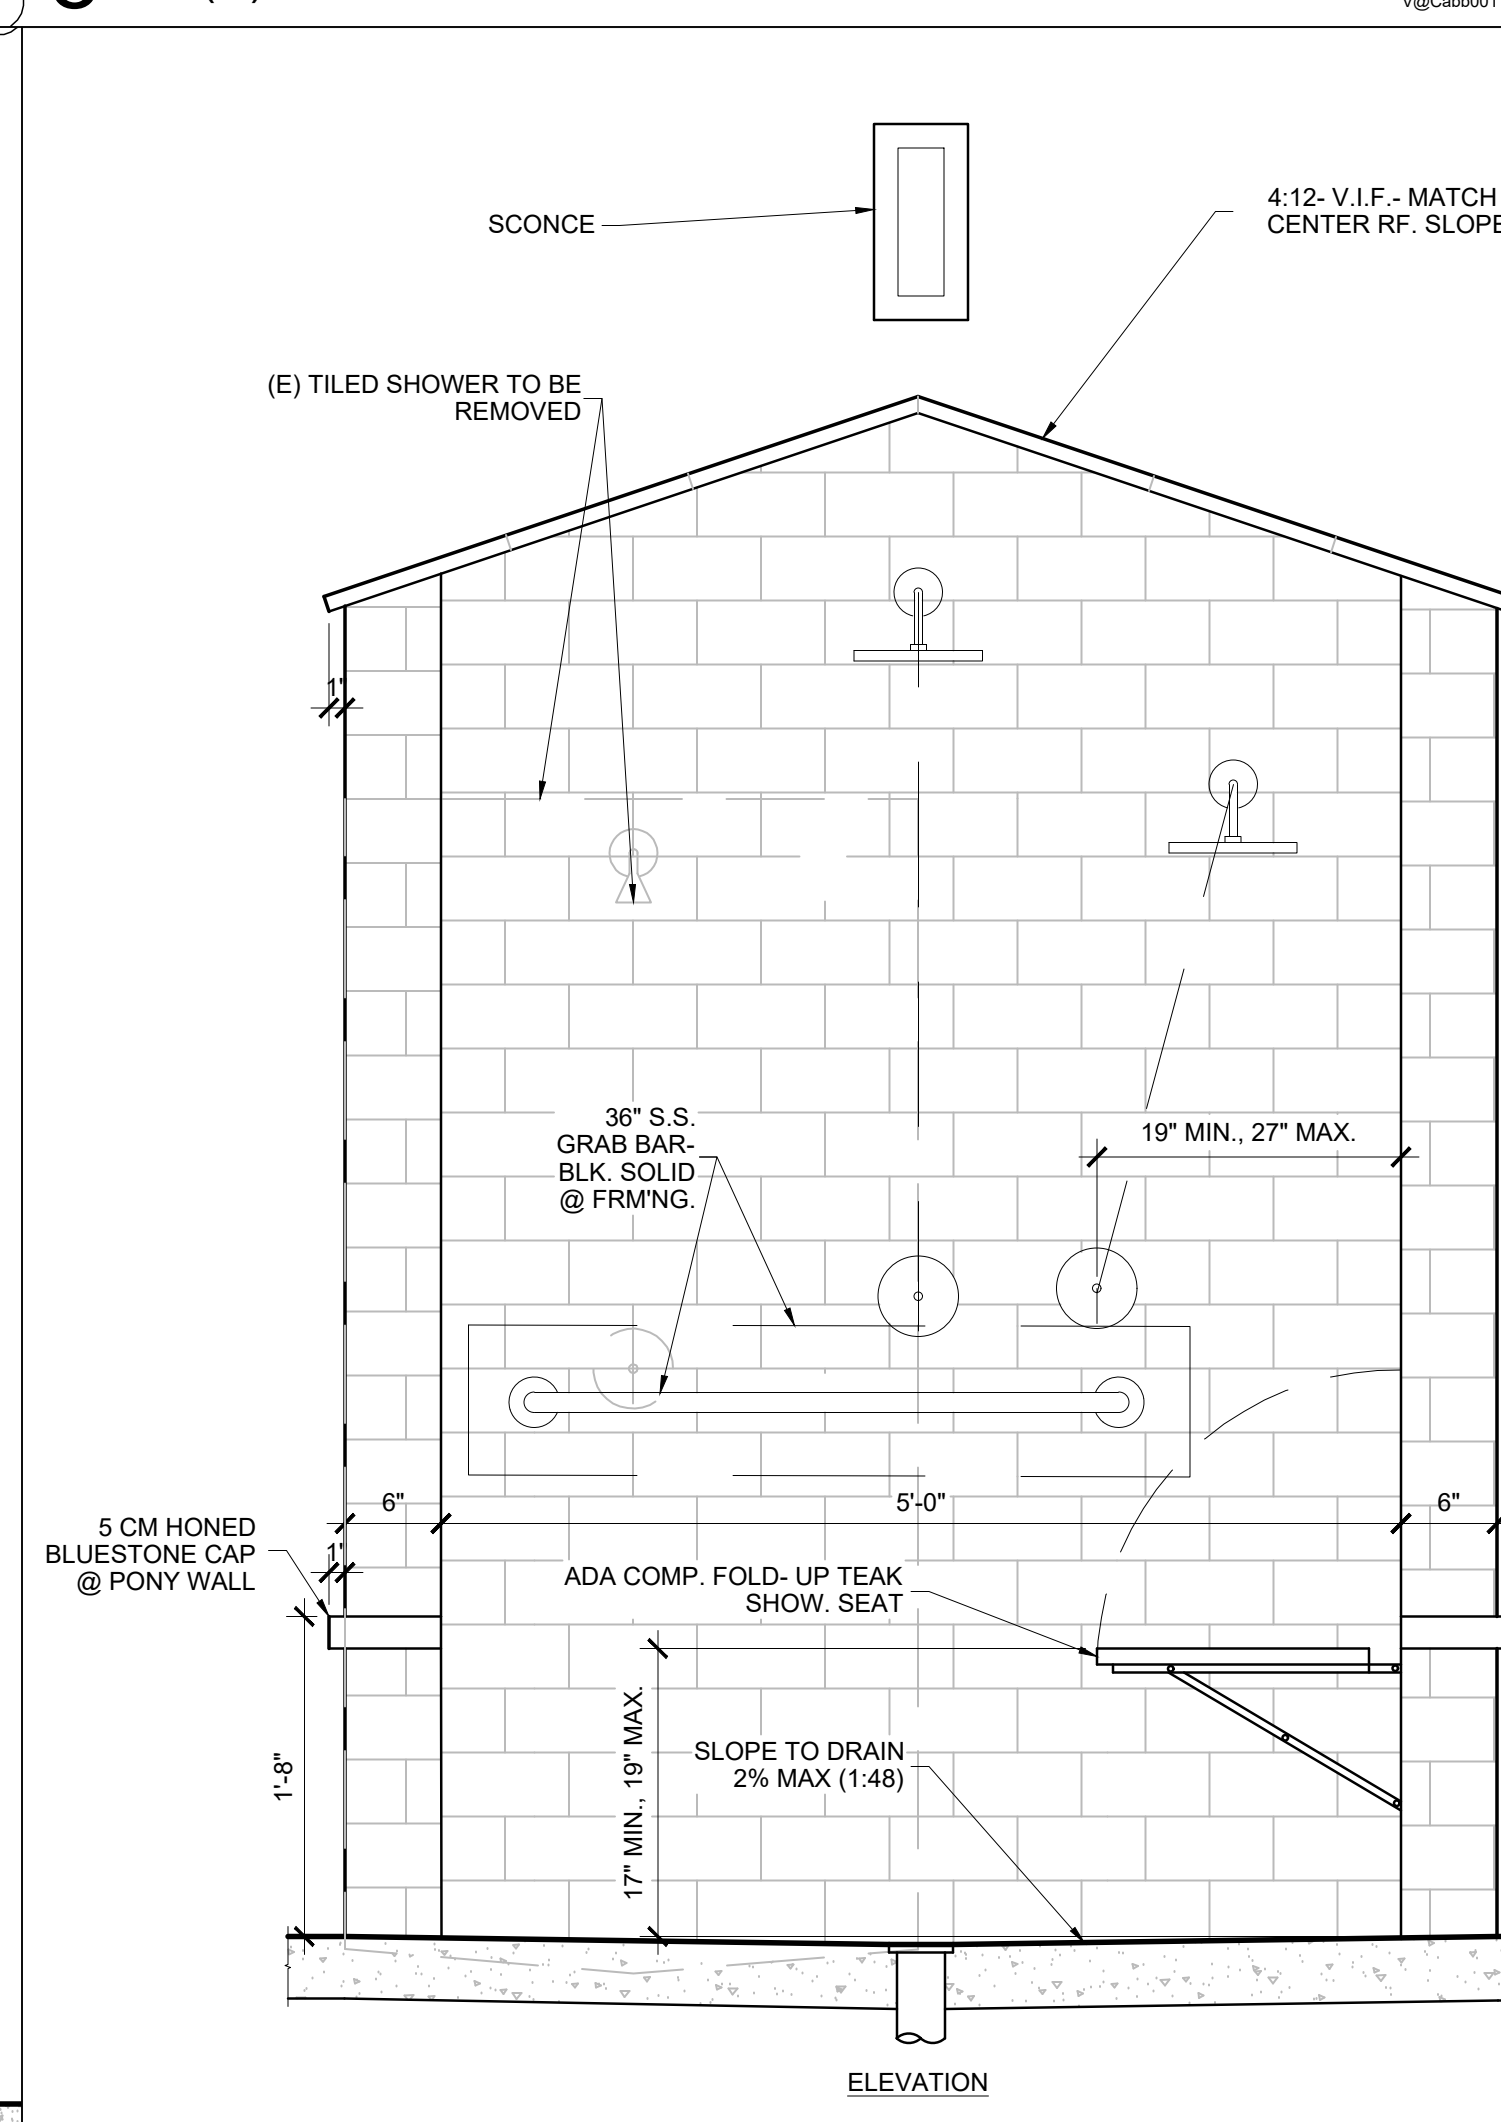5 (N) EXTERIOR POOL RINSE SHOWER

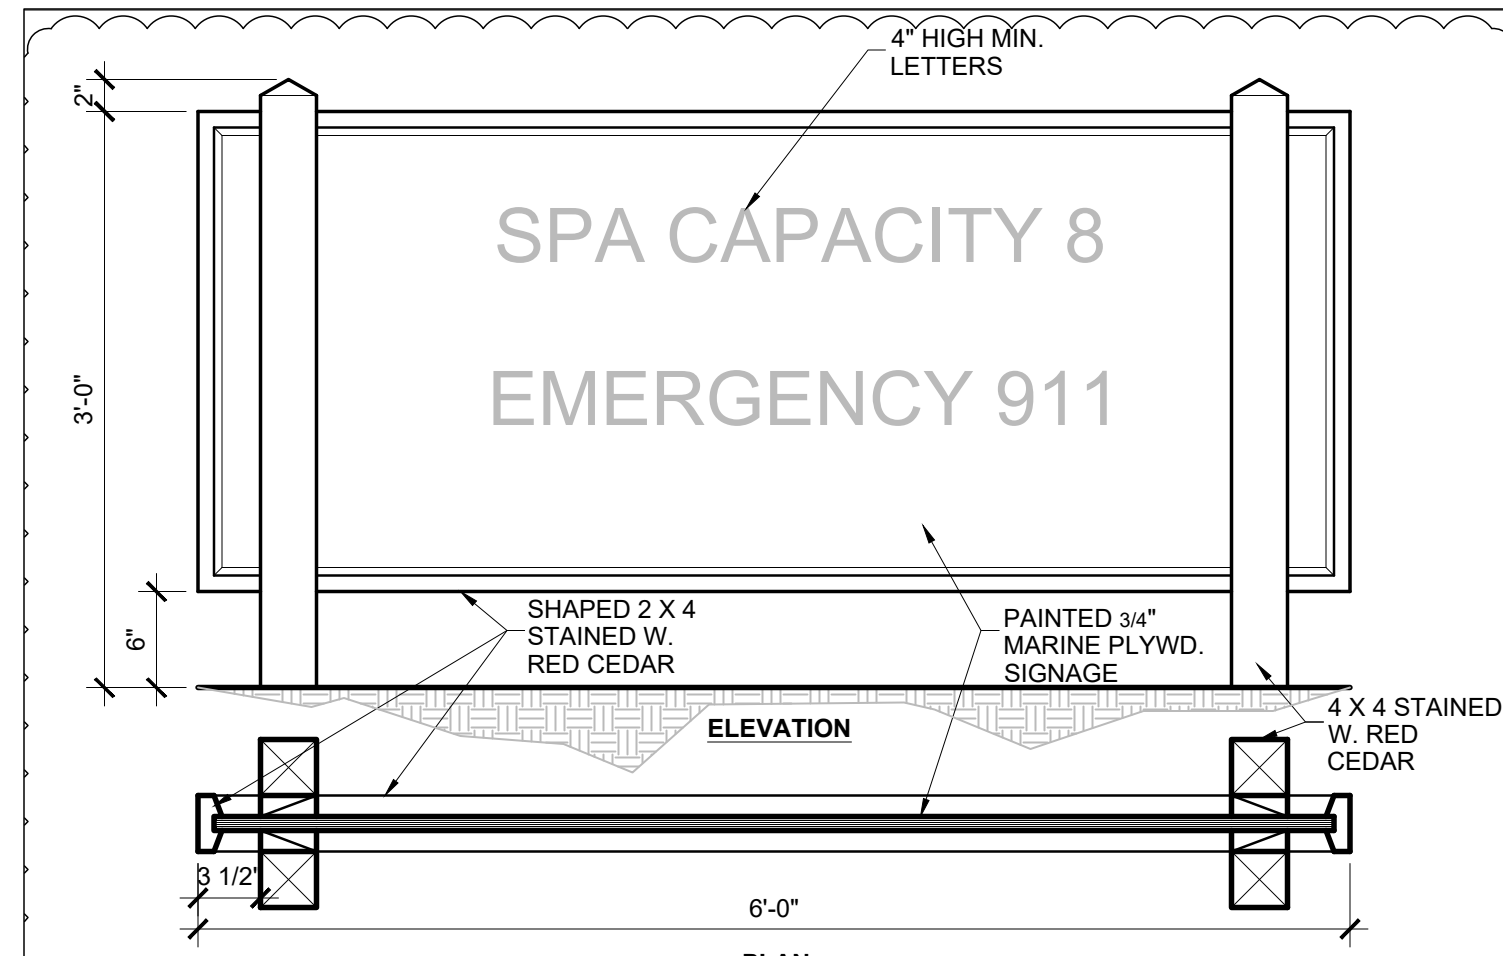


9 (N) SPA SIGN

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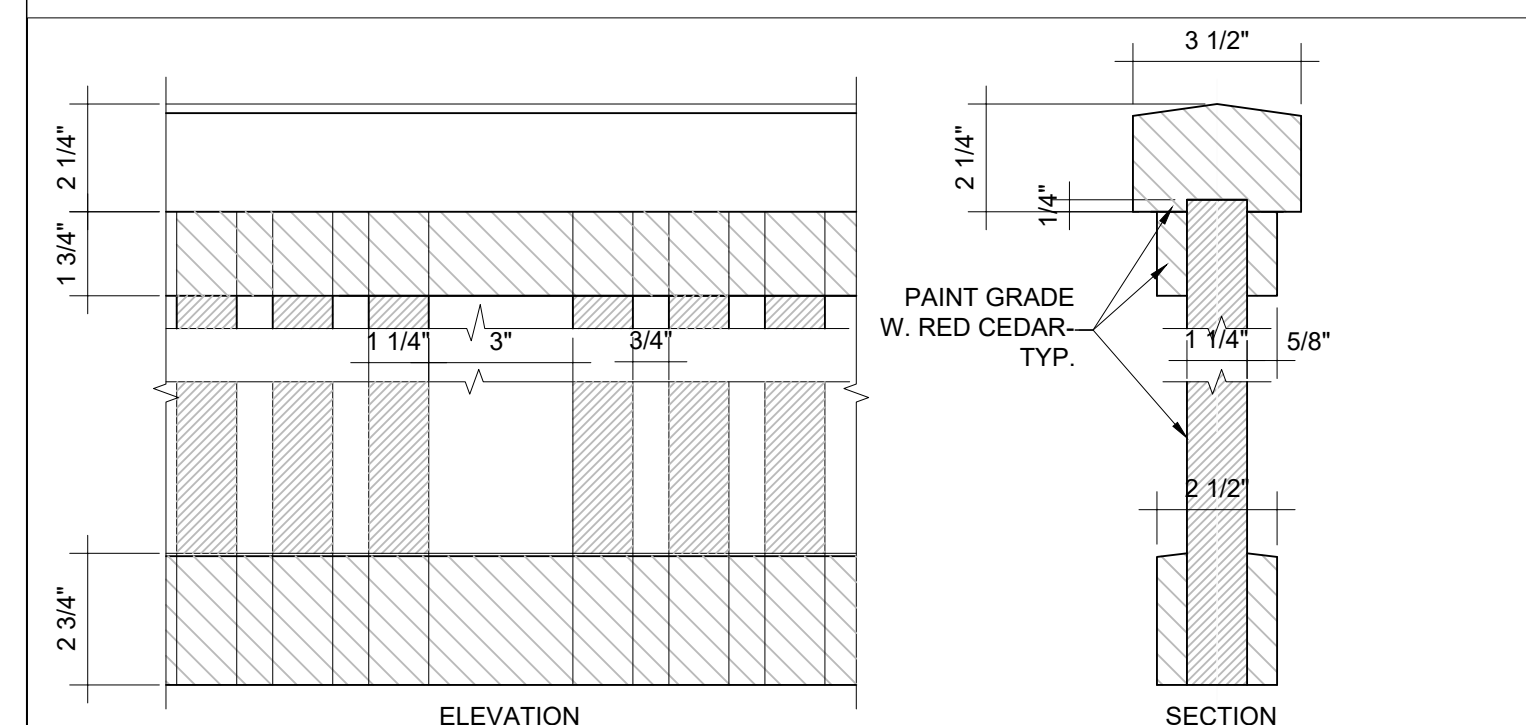


6 (N) PAVILION PARTITION WALL @ FIREPLACE


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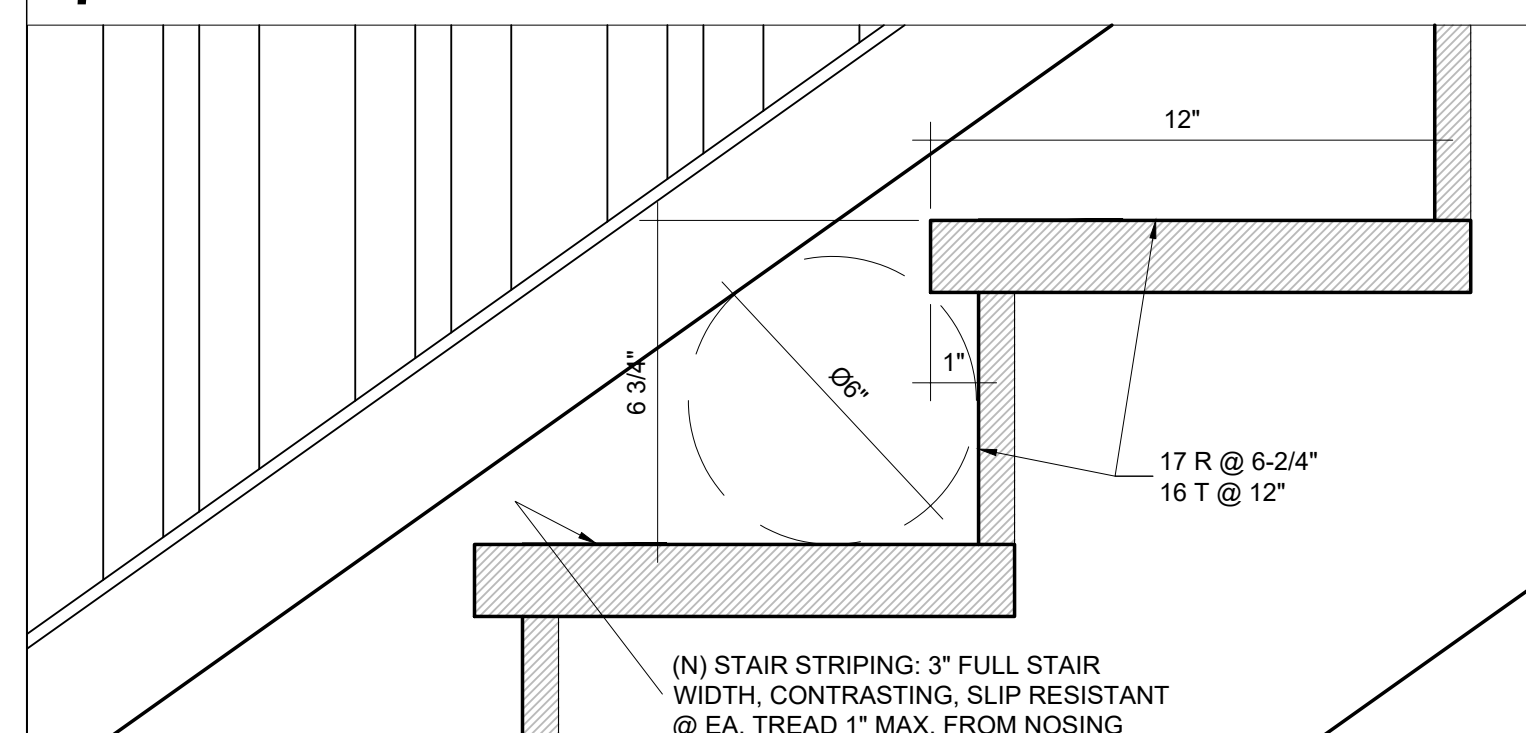
9 HANDRAIL TO GUARD RAIL SCALE: 3\"/>

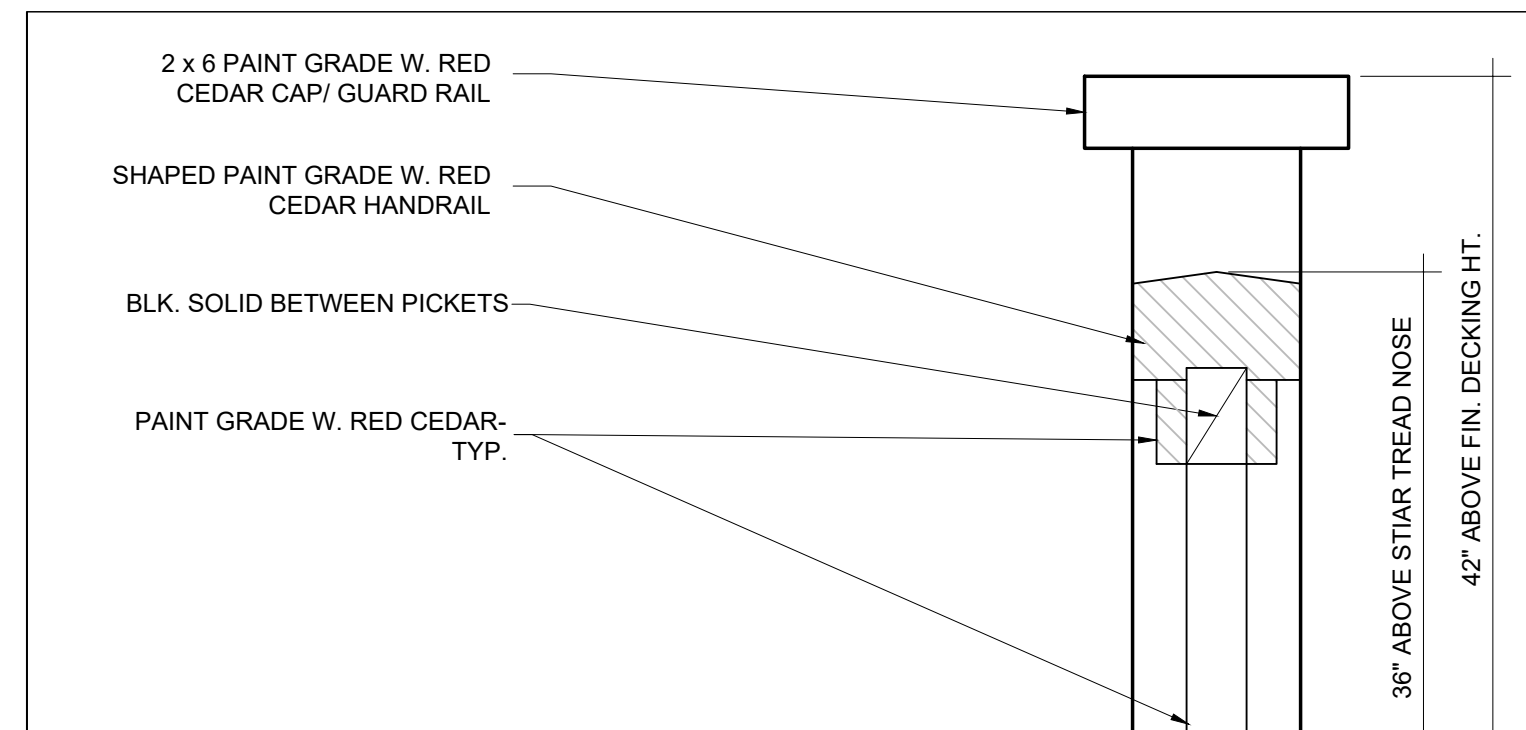


8 HAND/ GUARD RAIL PICKETS SCALE: 3\"/>




7 STAIR RAIL POST CONNECTION SCALE: 3\"/>

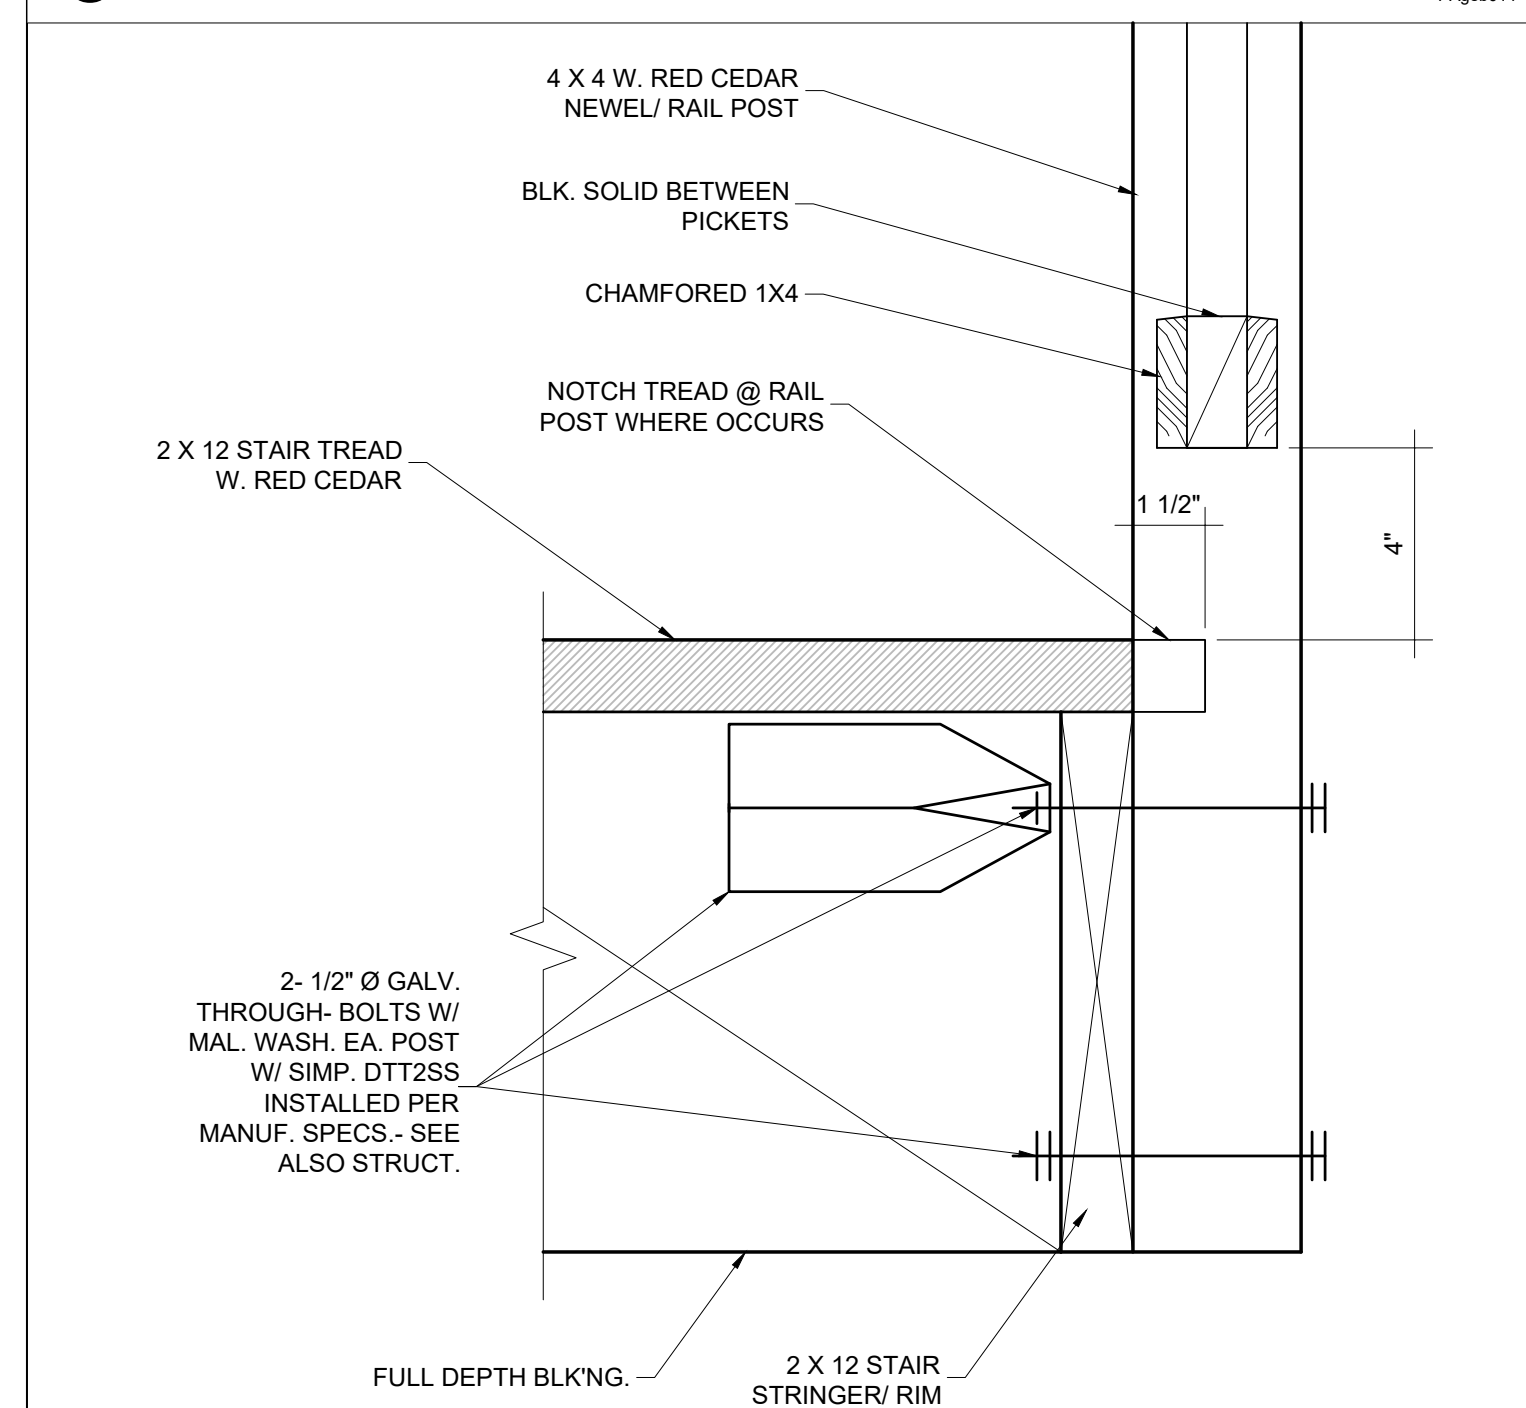


6 STAIR TREAD/ RISER & RAIL SCALE: 3\"/>

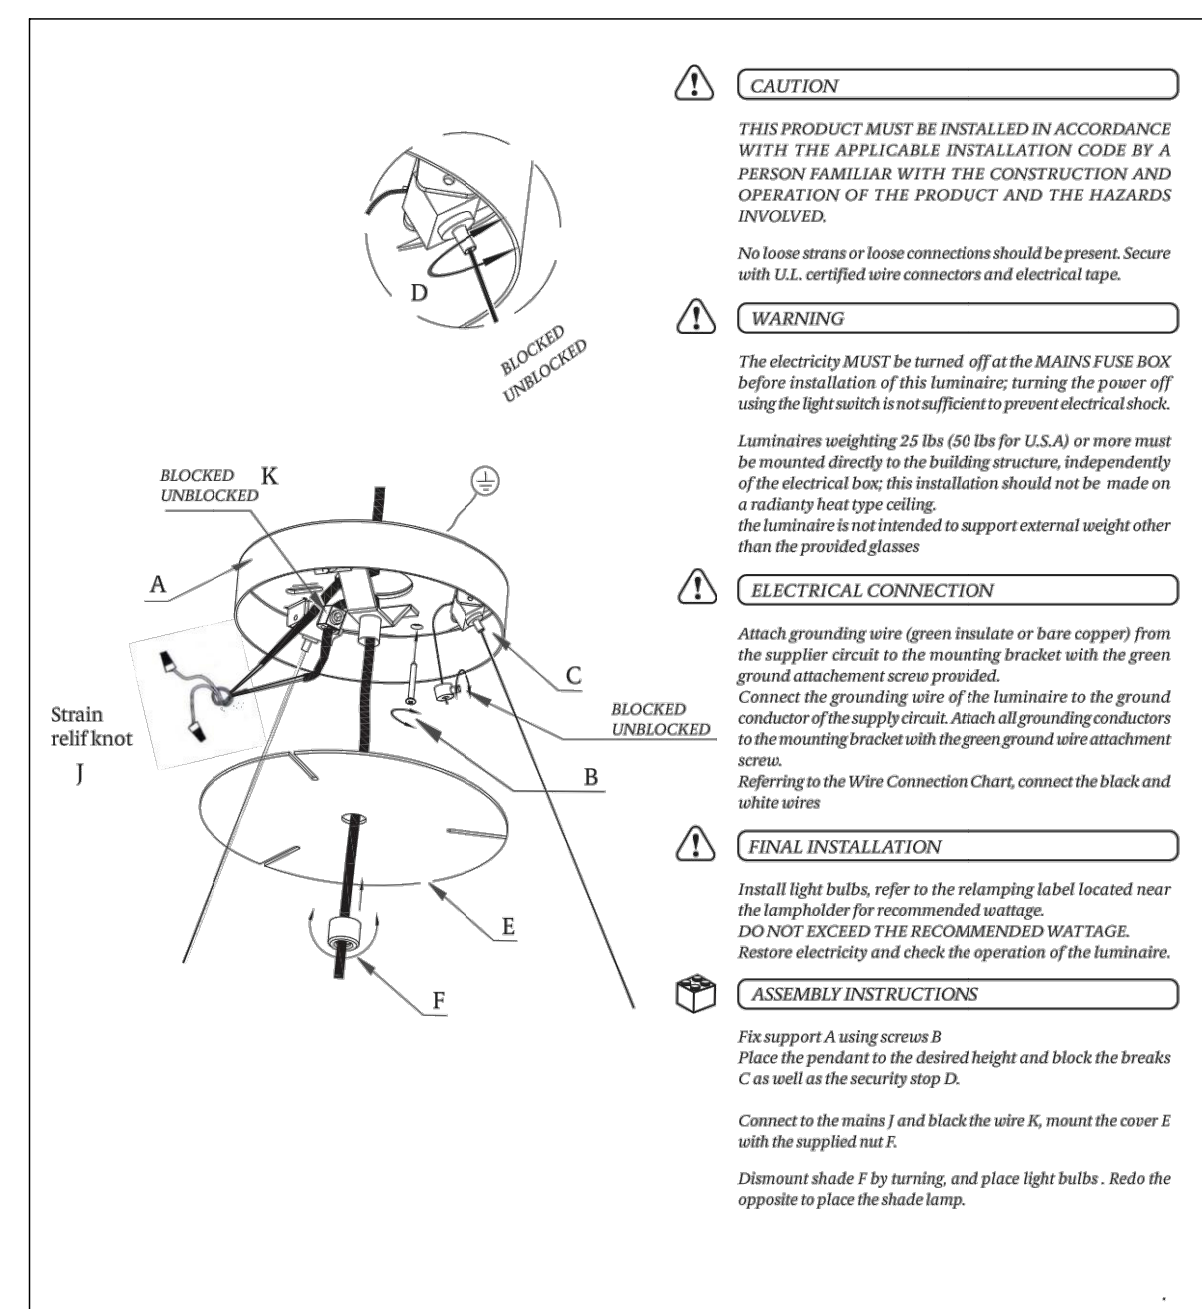


10 ENTRY PENDANT ATTACHMENT N.T.S. Page 014

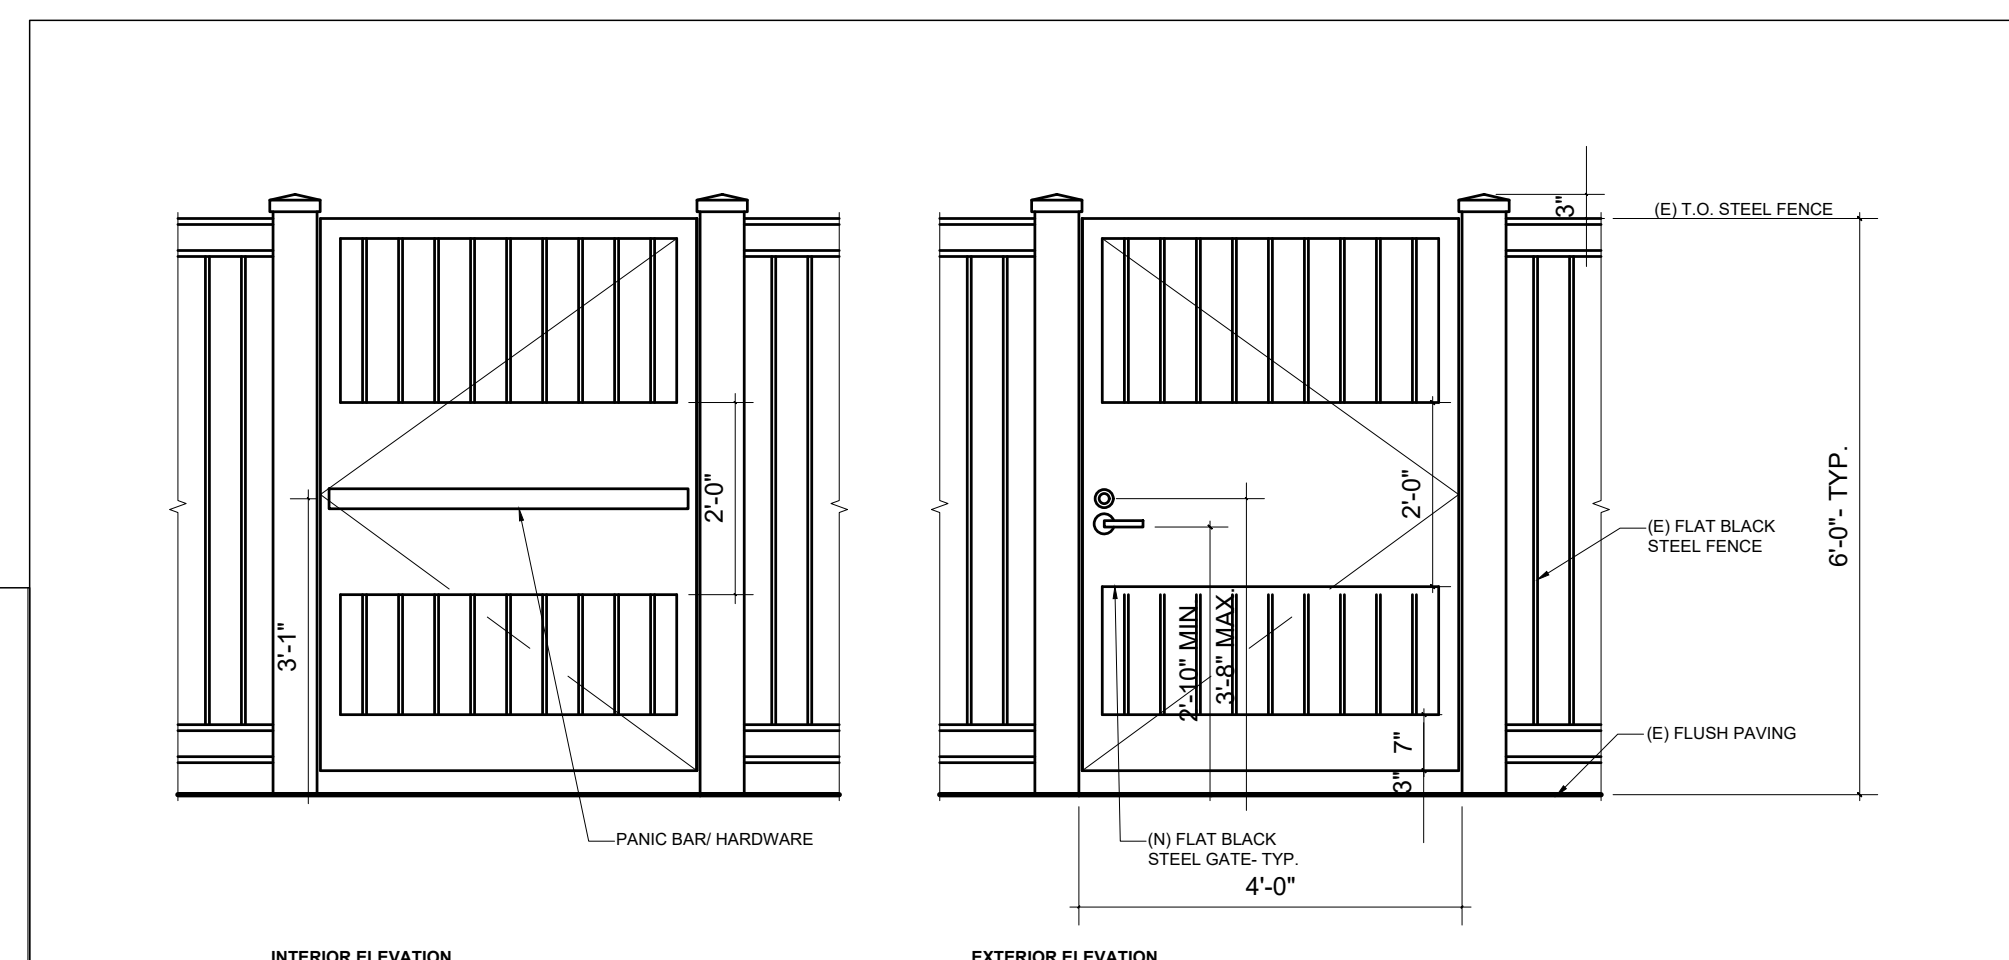


5 FENCE/ ENTRY GATES SCALE: 1/2\"/>

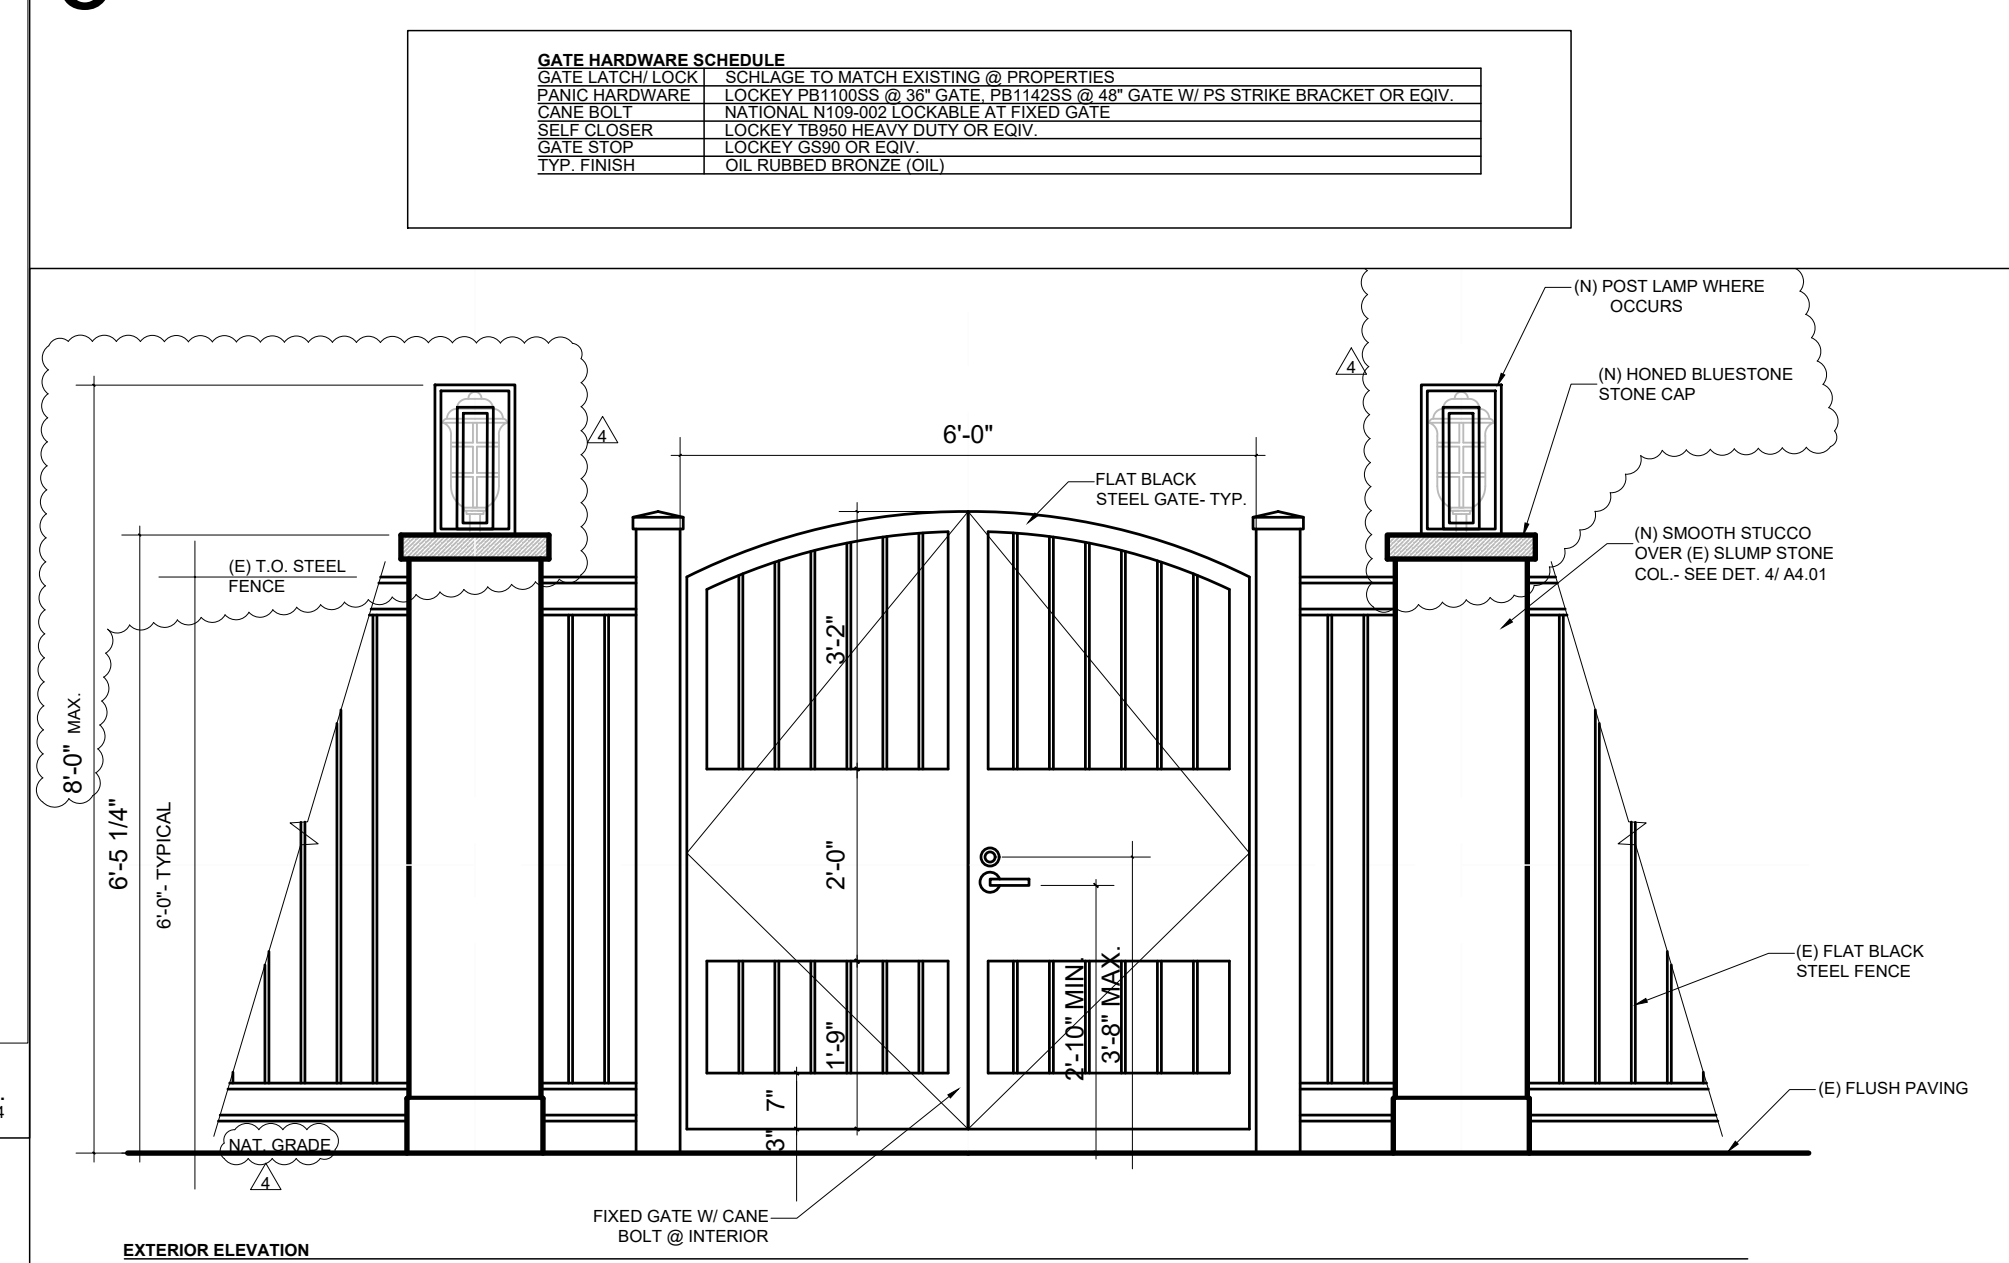


4 FENCE/ MAIN ENTRY GATES SCALE: 1/2\"/>

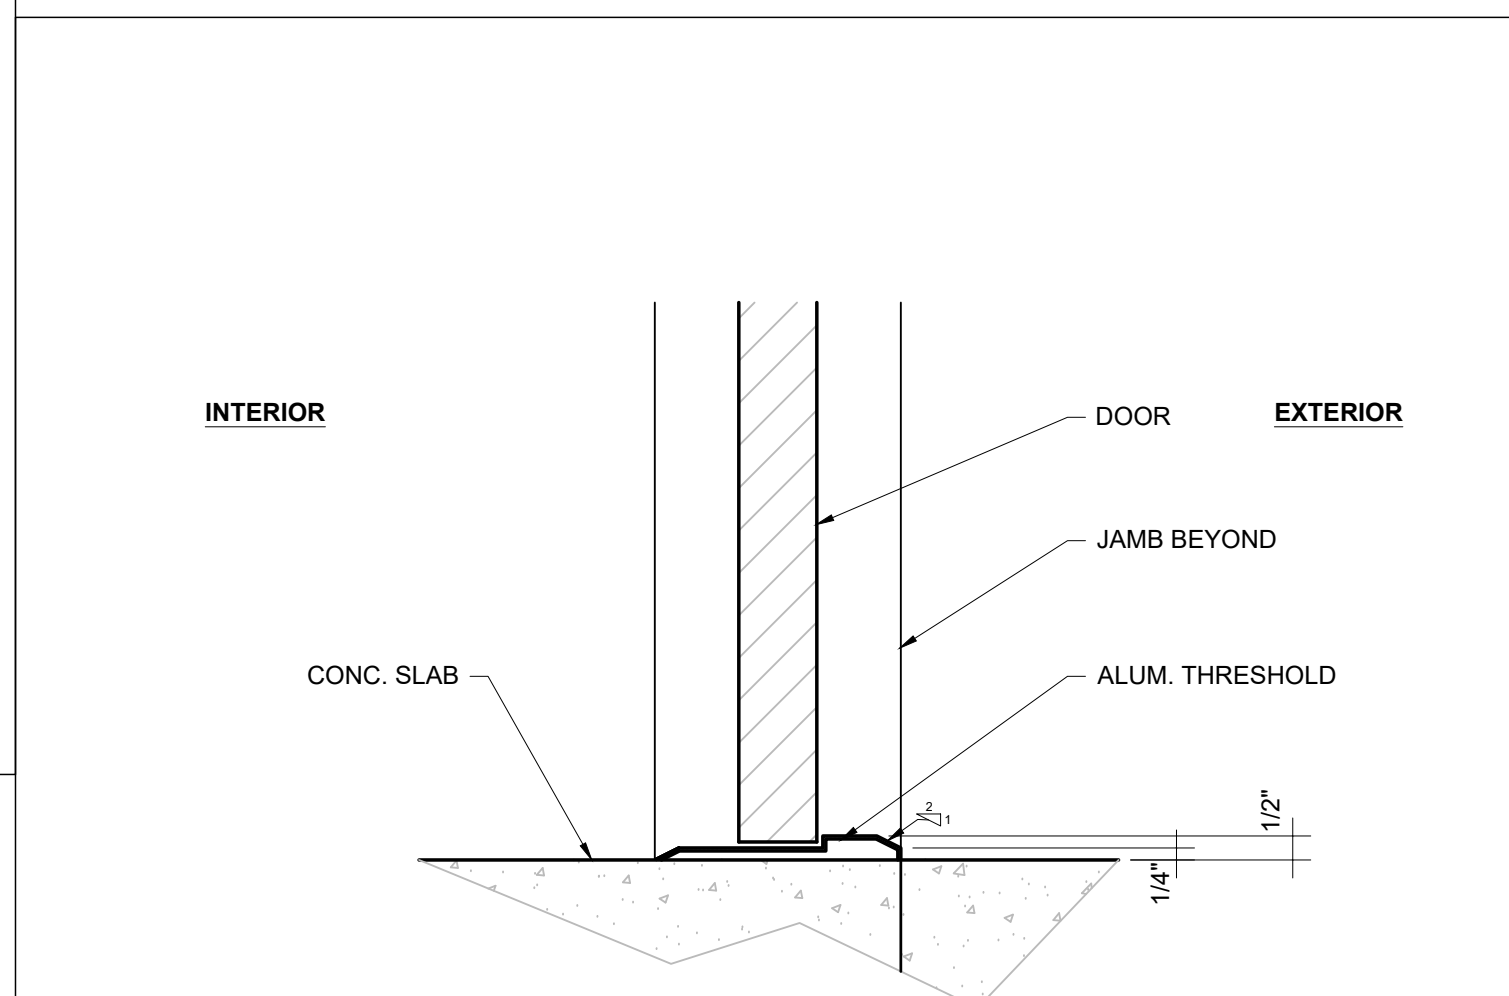

3 THRESHOLD DETAIL SCALE: 3\"/>

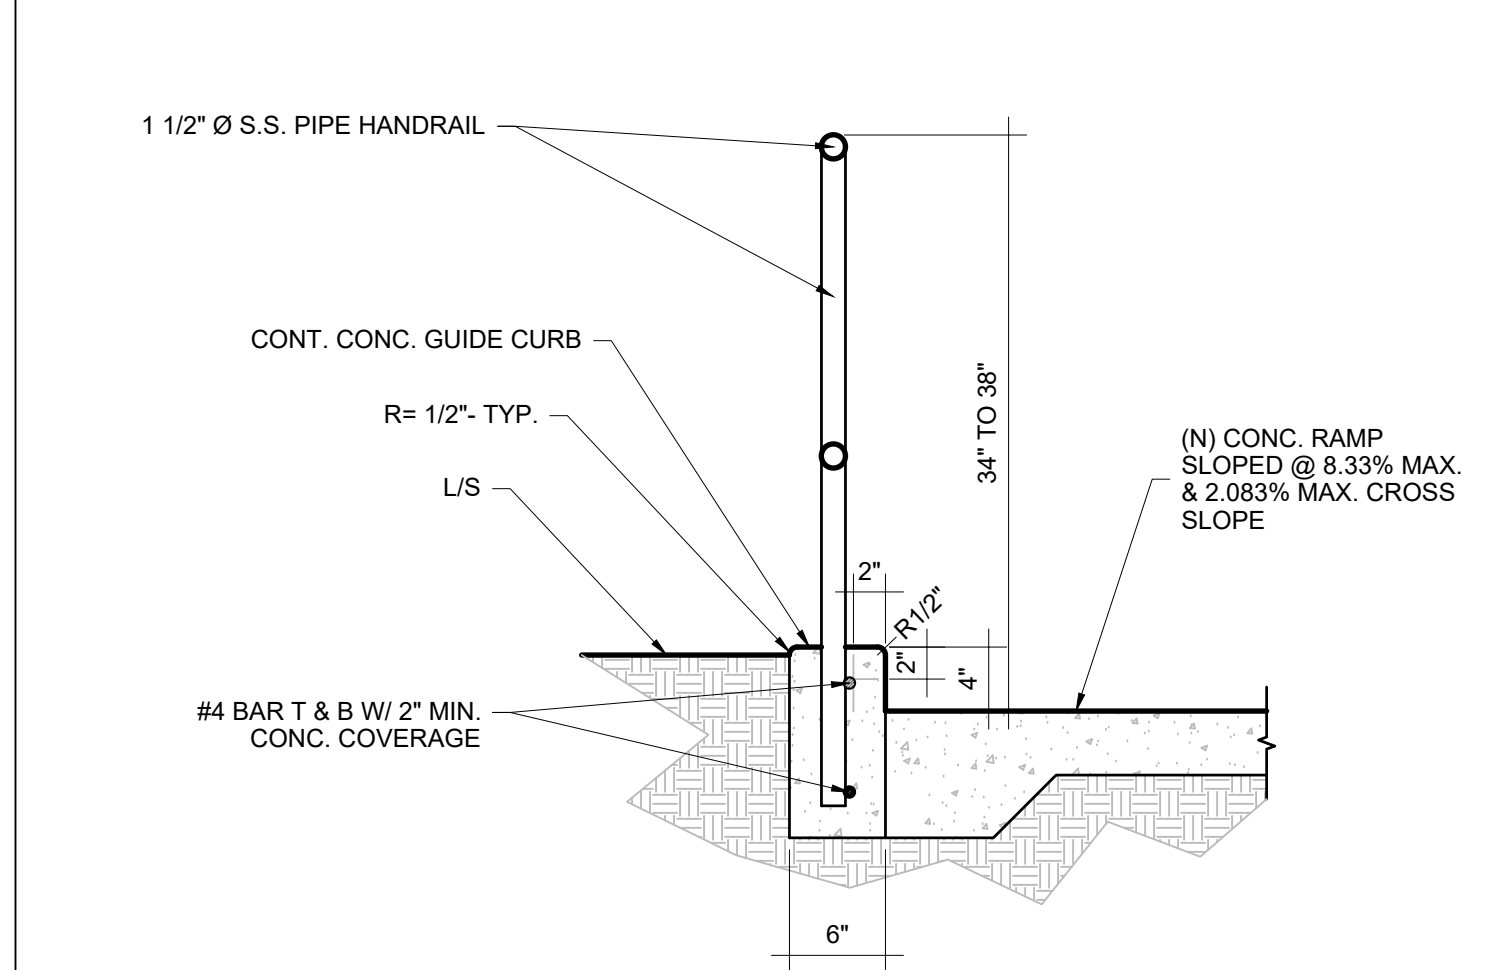


2 (N) RAMP GUIDE CURB & HANDRAIL SCALE: 1\"/>

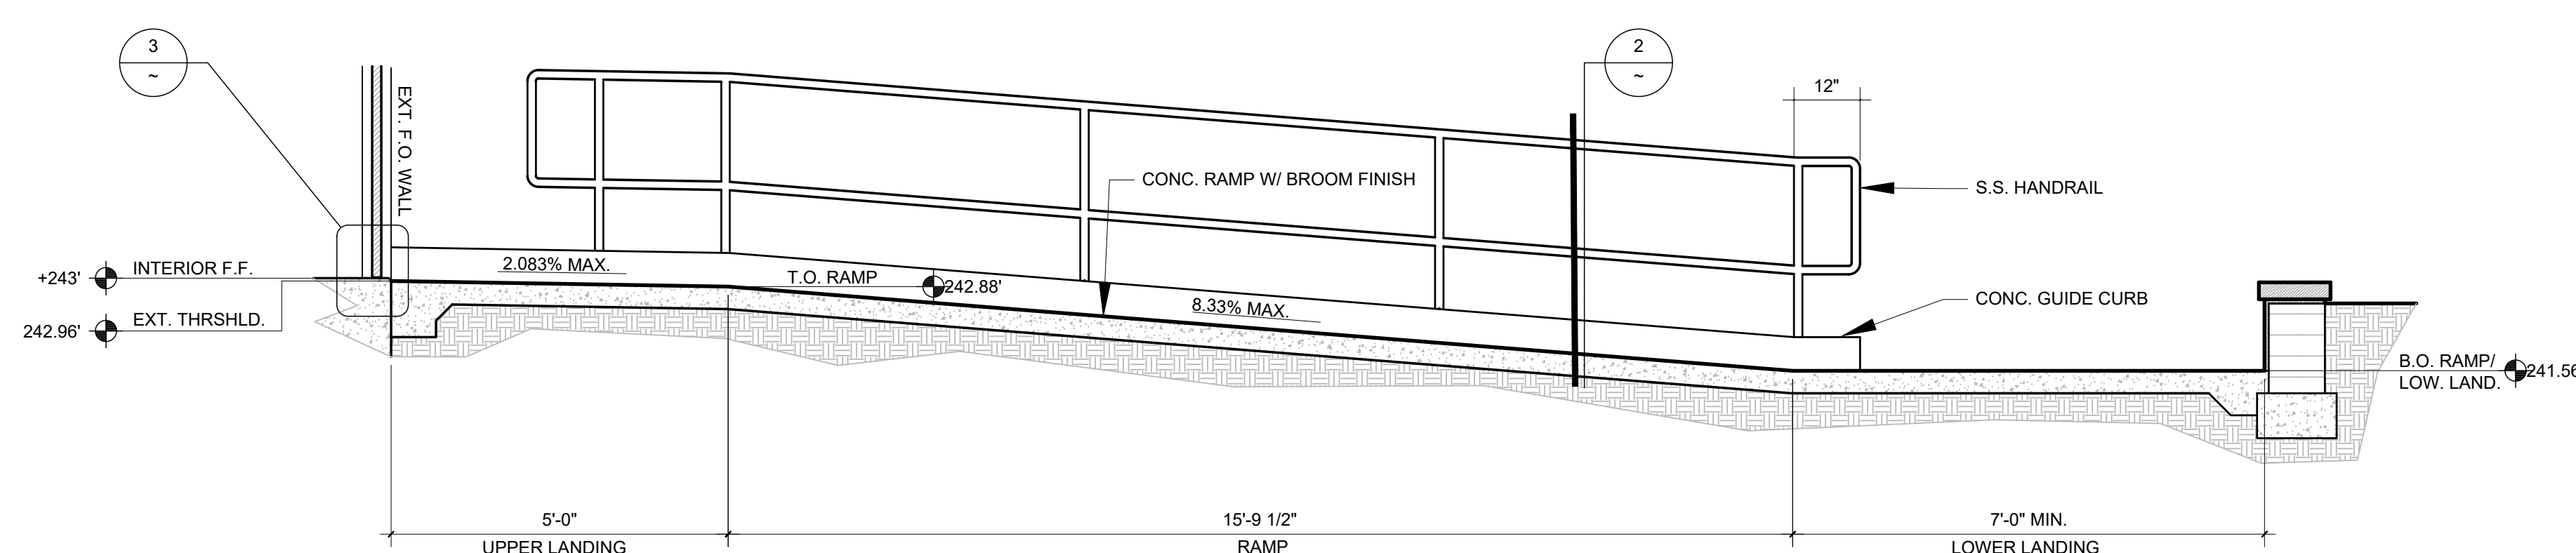


A-A ENTRY RAMP SECTION

SCALE: 1/4\"/>

1 ENTRY RAMP DETAIL PLAN SCALE: 1/4\"/>

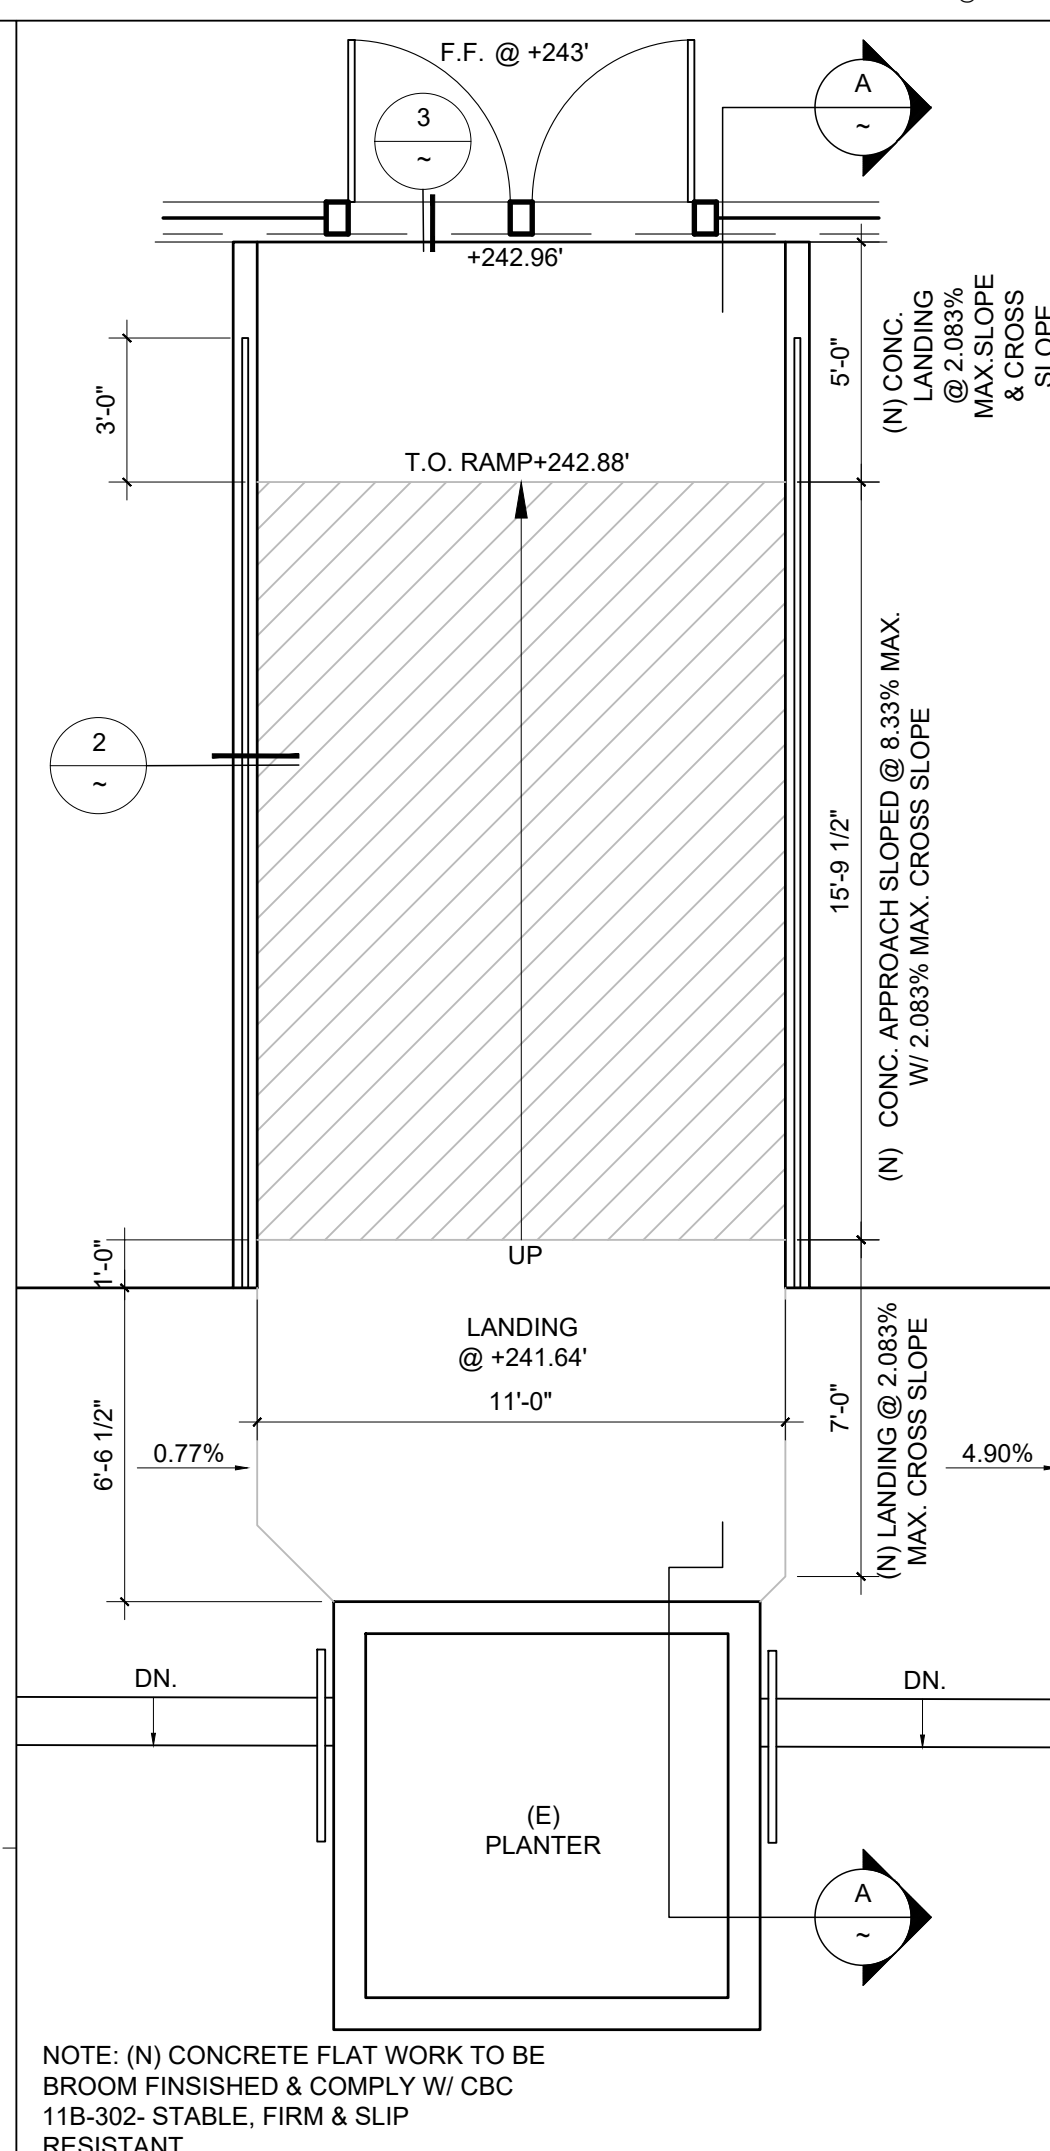NOTE: (N) CONCRETE FLAT WORK TO BE
BROOM FINISHED & COMPLY W/ CBC
11B-302- STABLE, FIRM & SLIP
RESISTANT

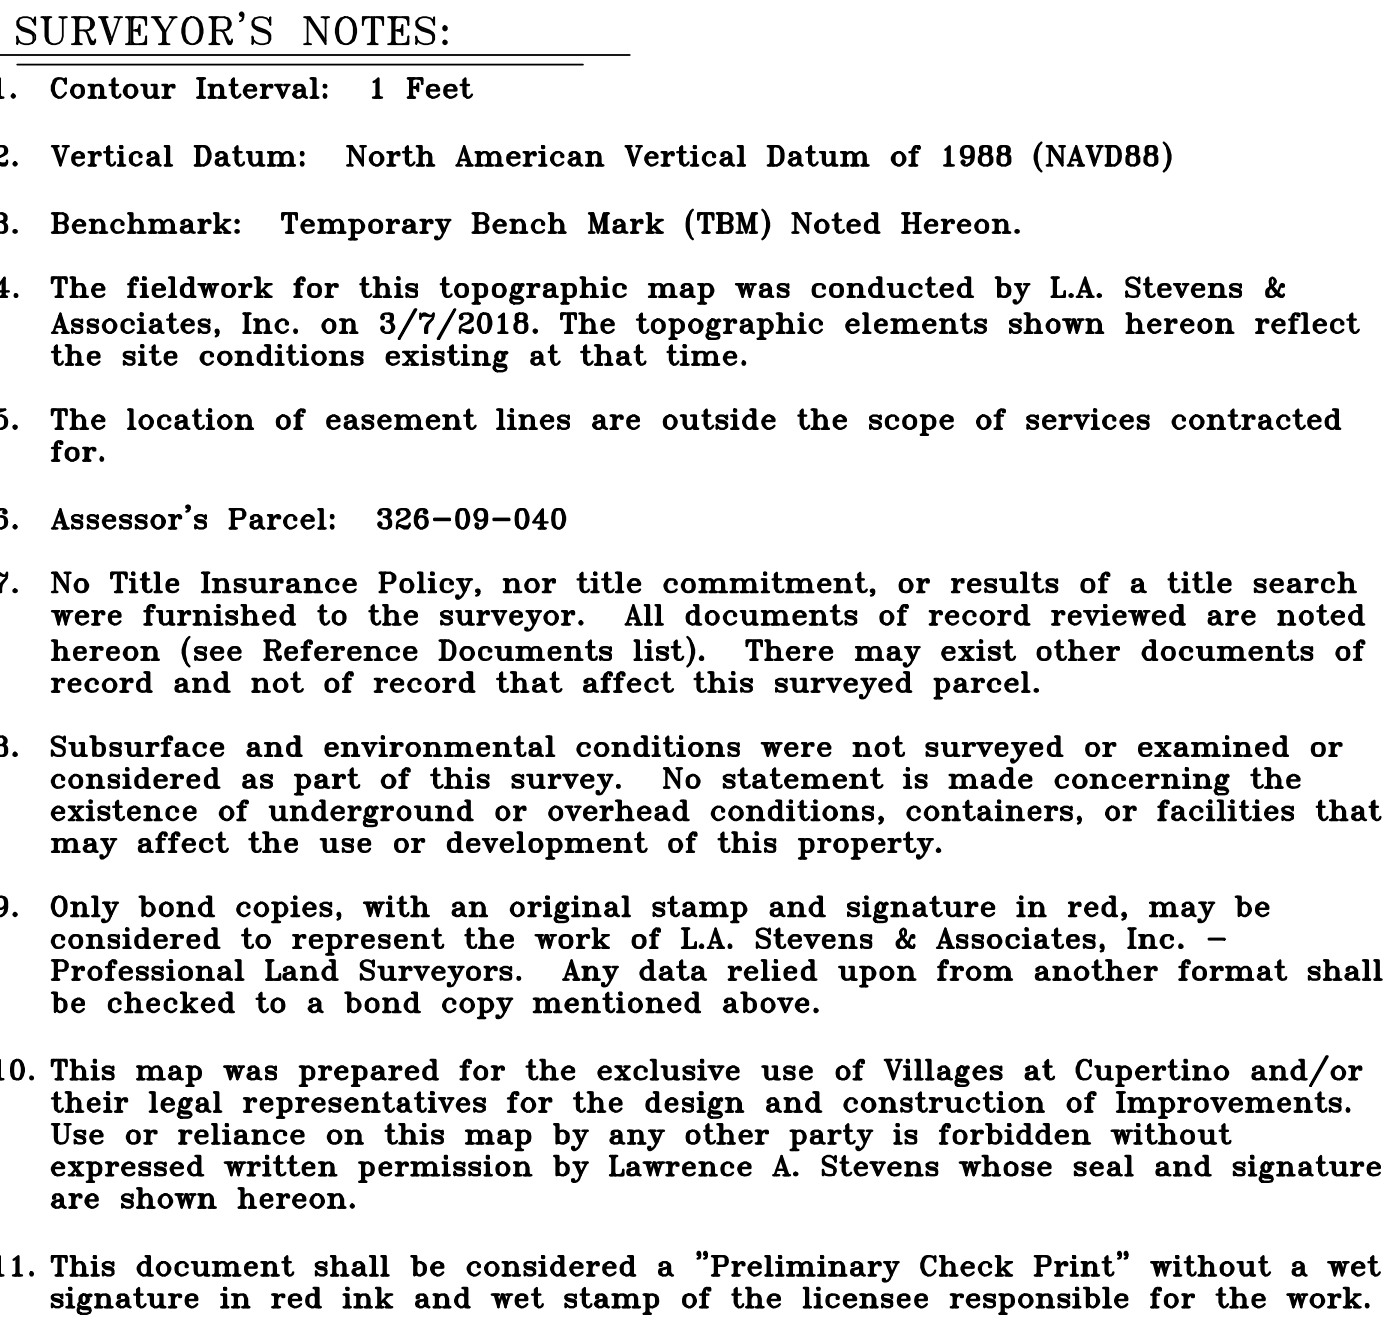

PRELIMINARY
LAST EDIT 3/13/18

LAWRENCE. A. STEVENS, PLS 6649




Revisions:
07/20/18
01/28/19
03/29/19 PERMIT SET
1/21/20 PERMIT SET REV.

AS- BUILT FITNESS
CENTER FLOOR
PLAN

DATE 7/9/18
SCALE 1/4" = 1'-0"
DRAWN: ek

ABI.01

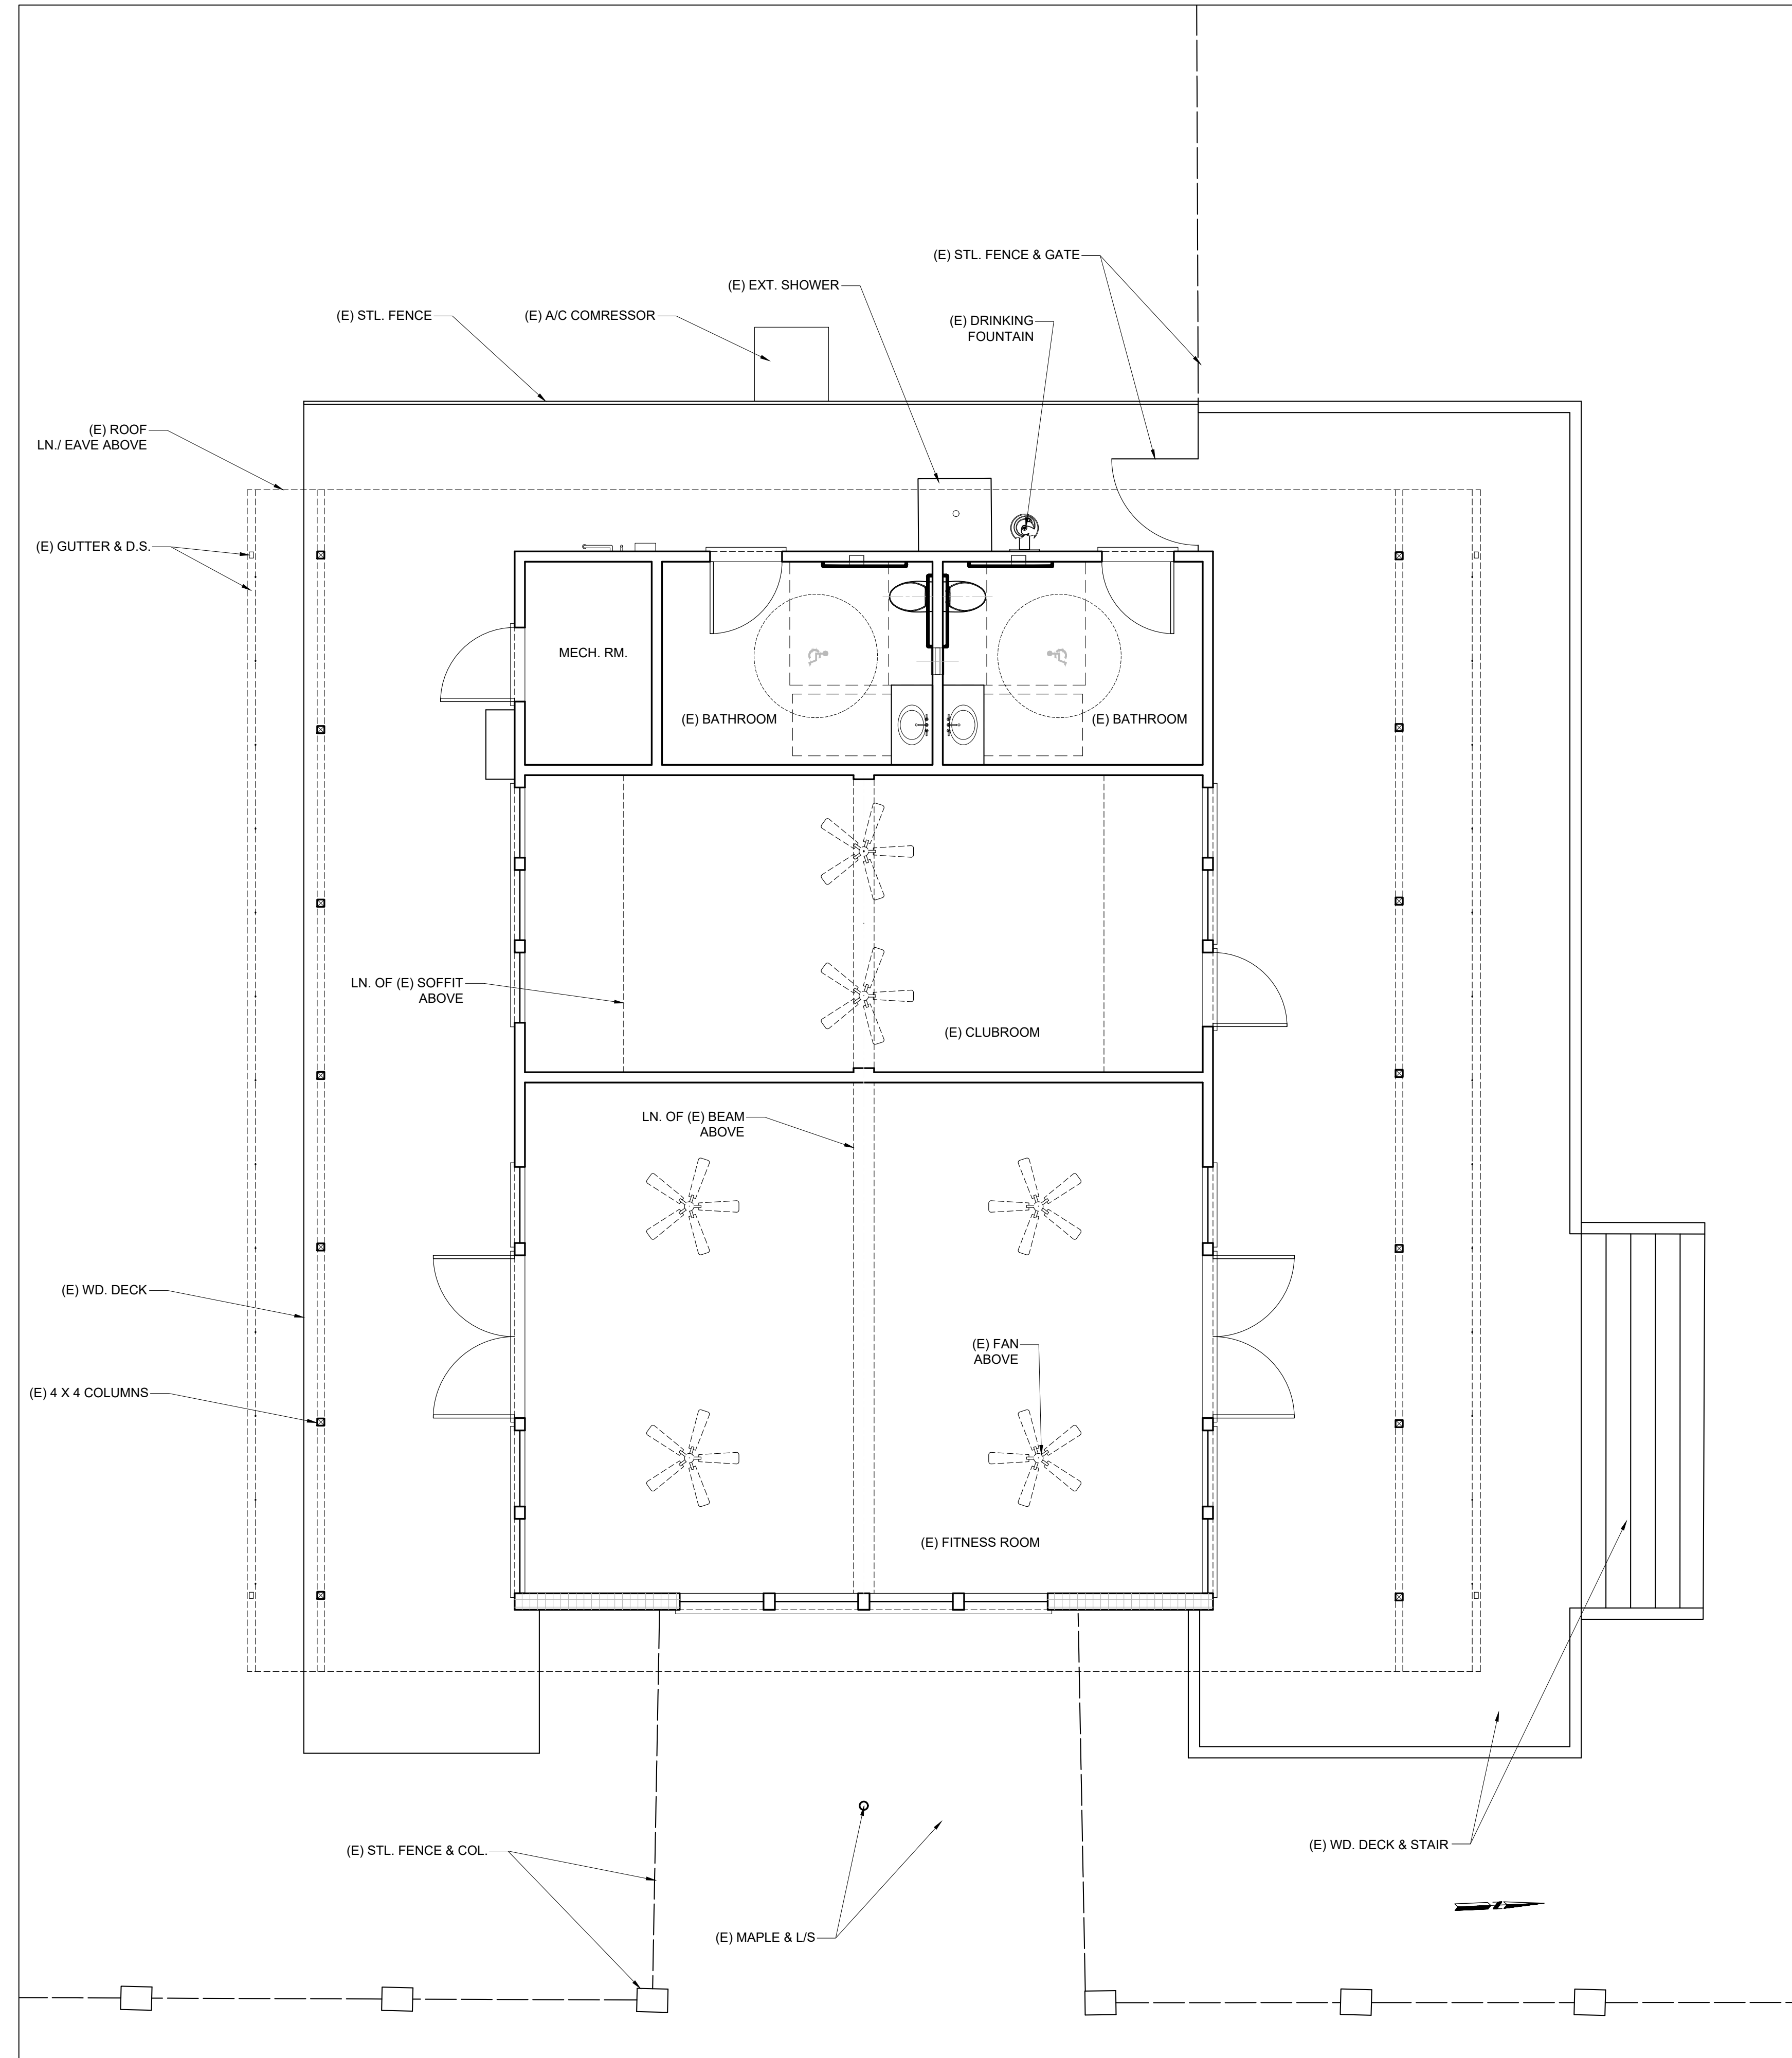

1 AS- BUILT FLOOR PLAN
1/4" = 1'-0"




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07/20/18	
01/28/19	
03/29/19	PERMIT SET
1/21/20	PERMIT SET REV.
6/18/20	PERMIT/ ASA SET REV.
8/12/20	PERMIT/ BUILD. REV.
9/25/20	ASA/ PLANNING REV.


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CENTER EXTERIOR
ELEVATIONS

DATE 7/9/18
SCALE 1/4" = 1'-0"
DRAWN: ek


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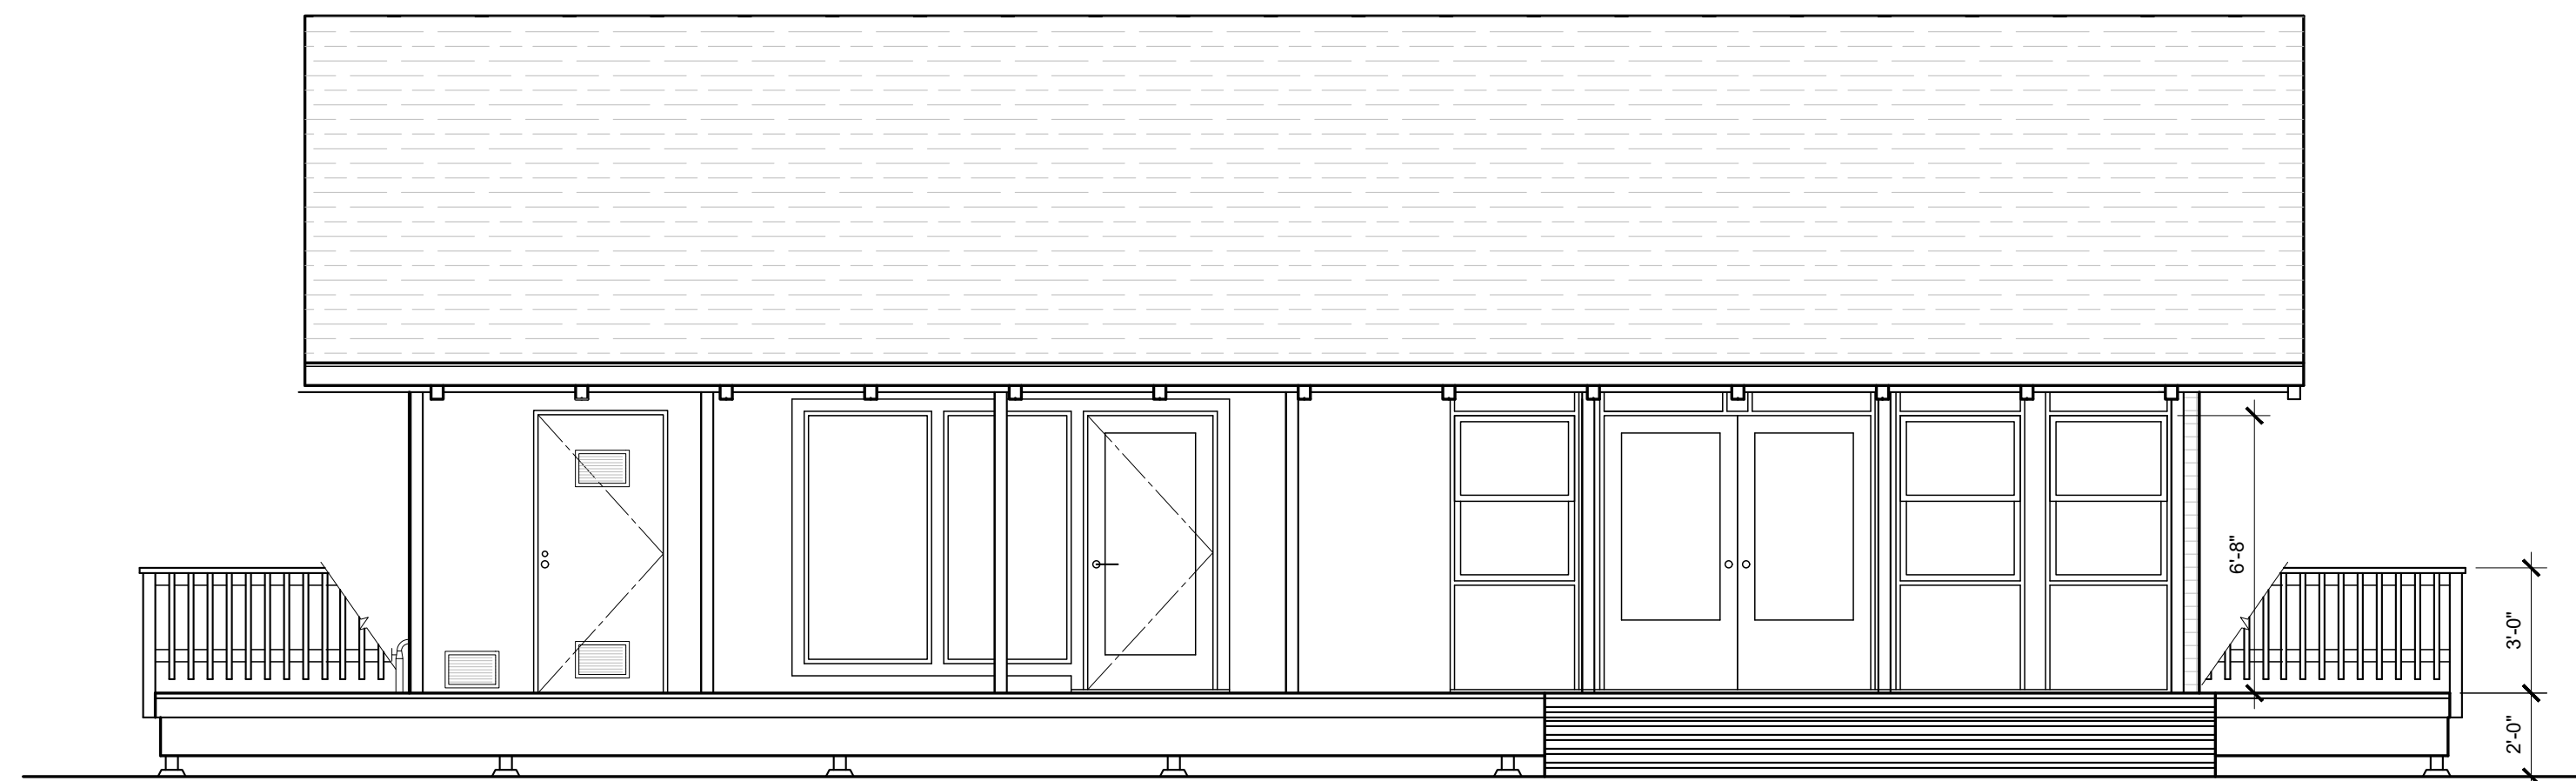
AS- BUILT EAST ELEVATION

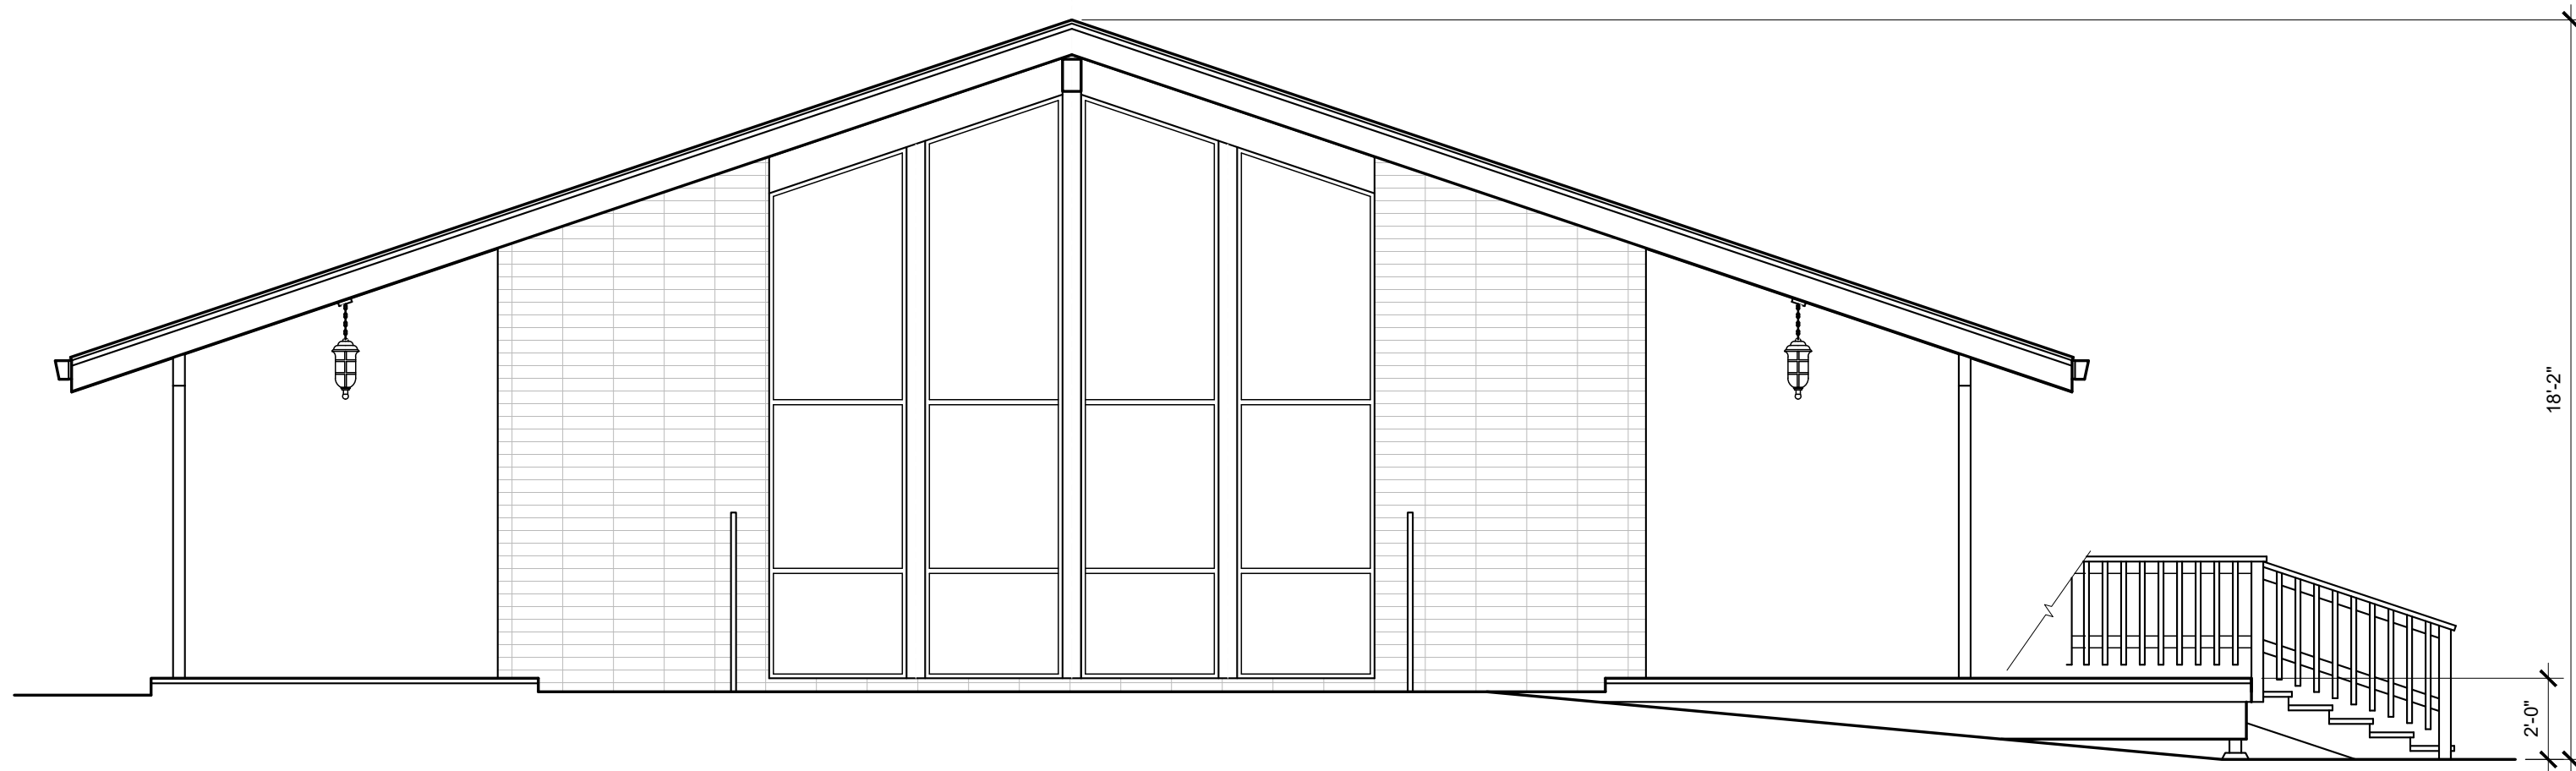

AS- BUILT NORTH ELEVATION

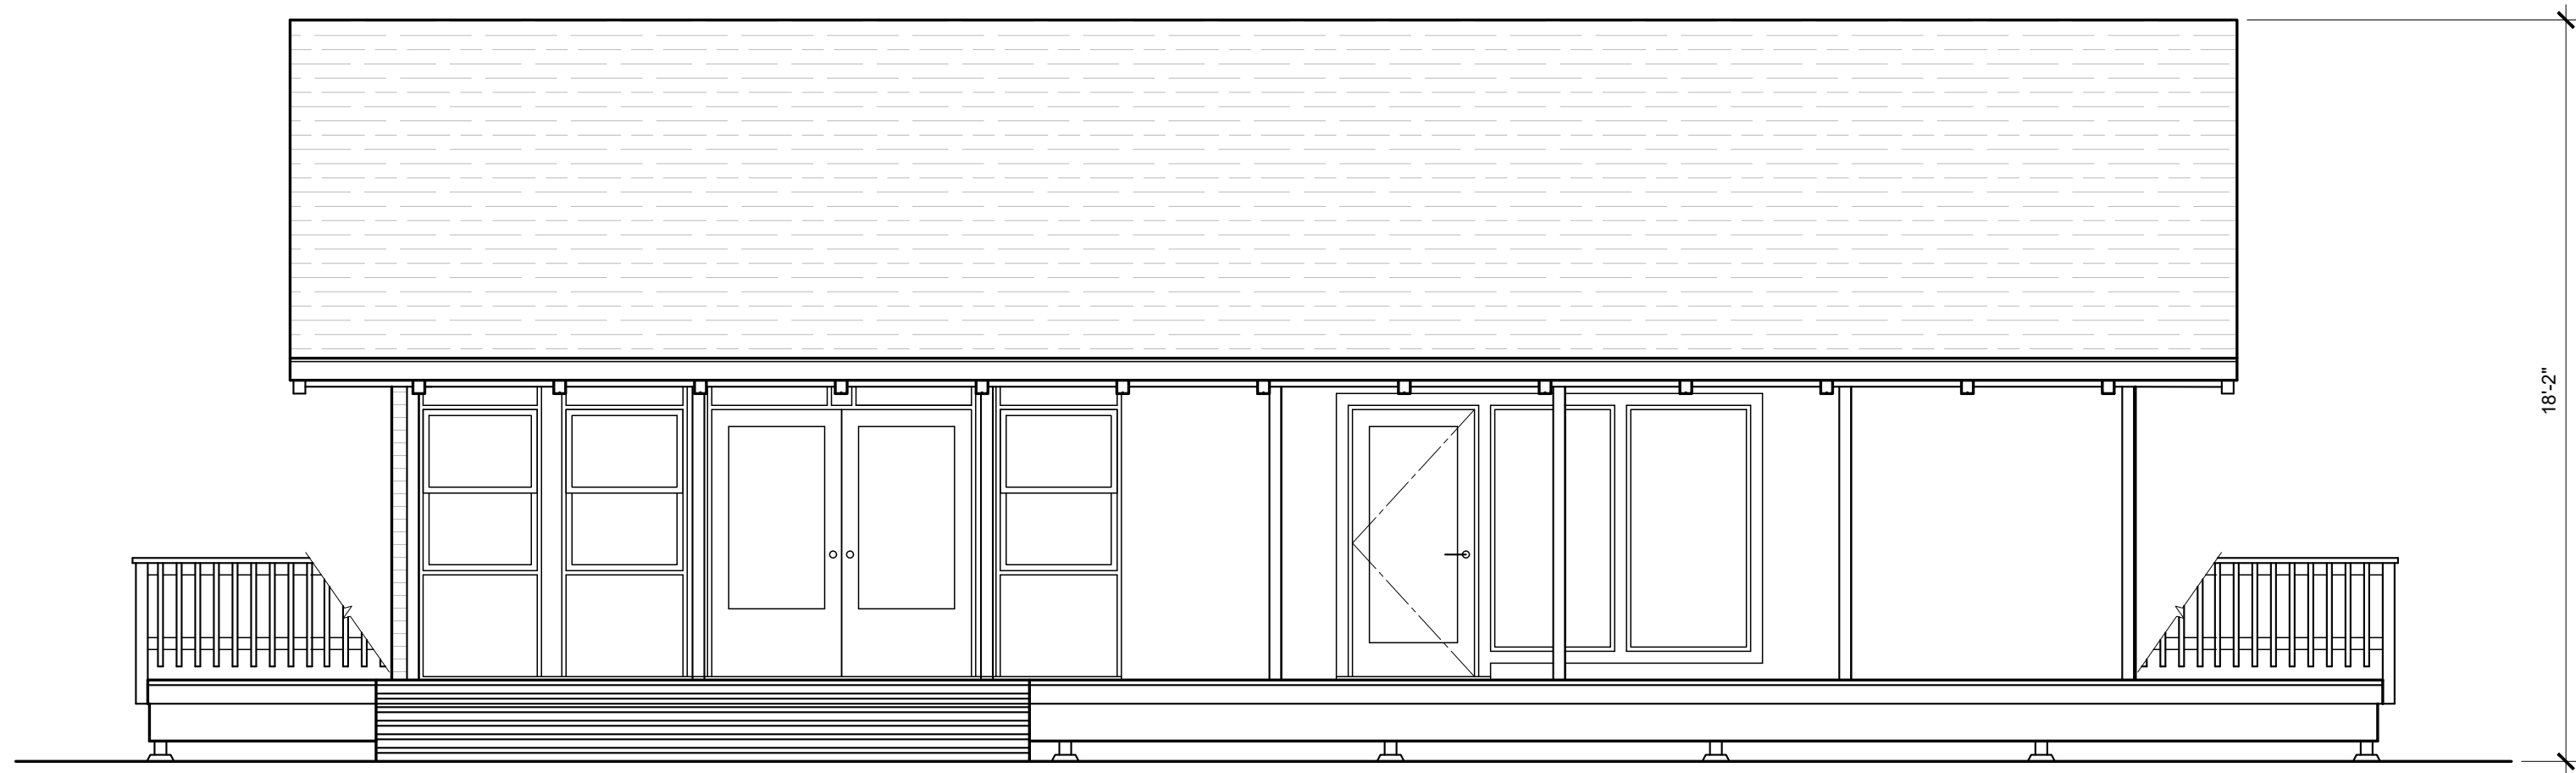

AS- BUILT WEST ELEVATION

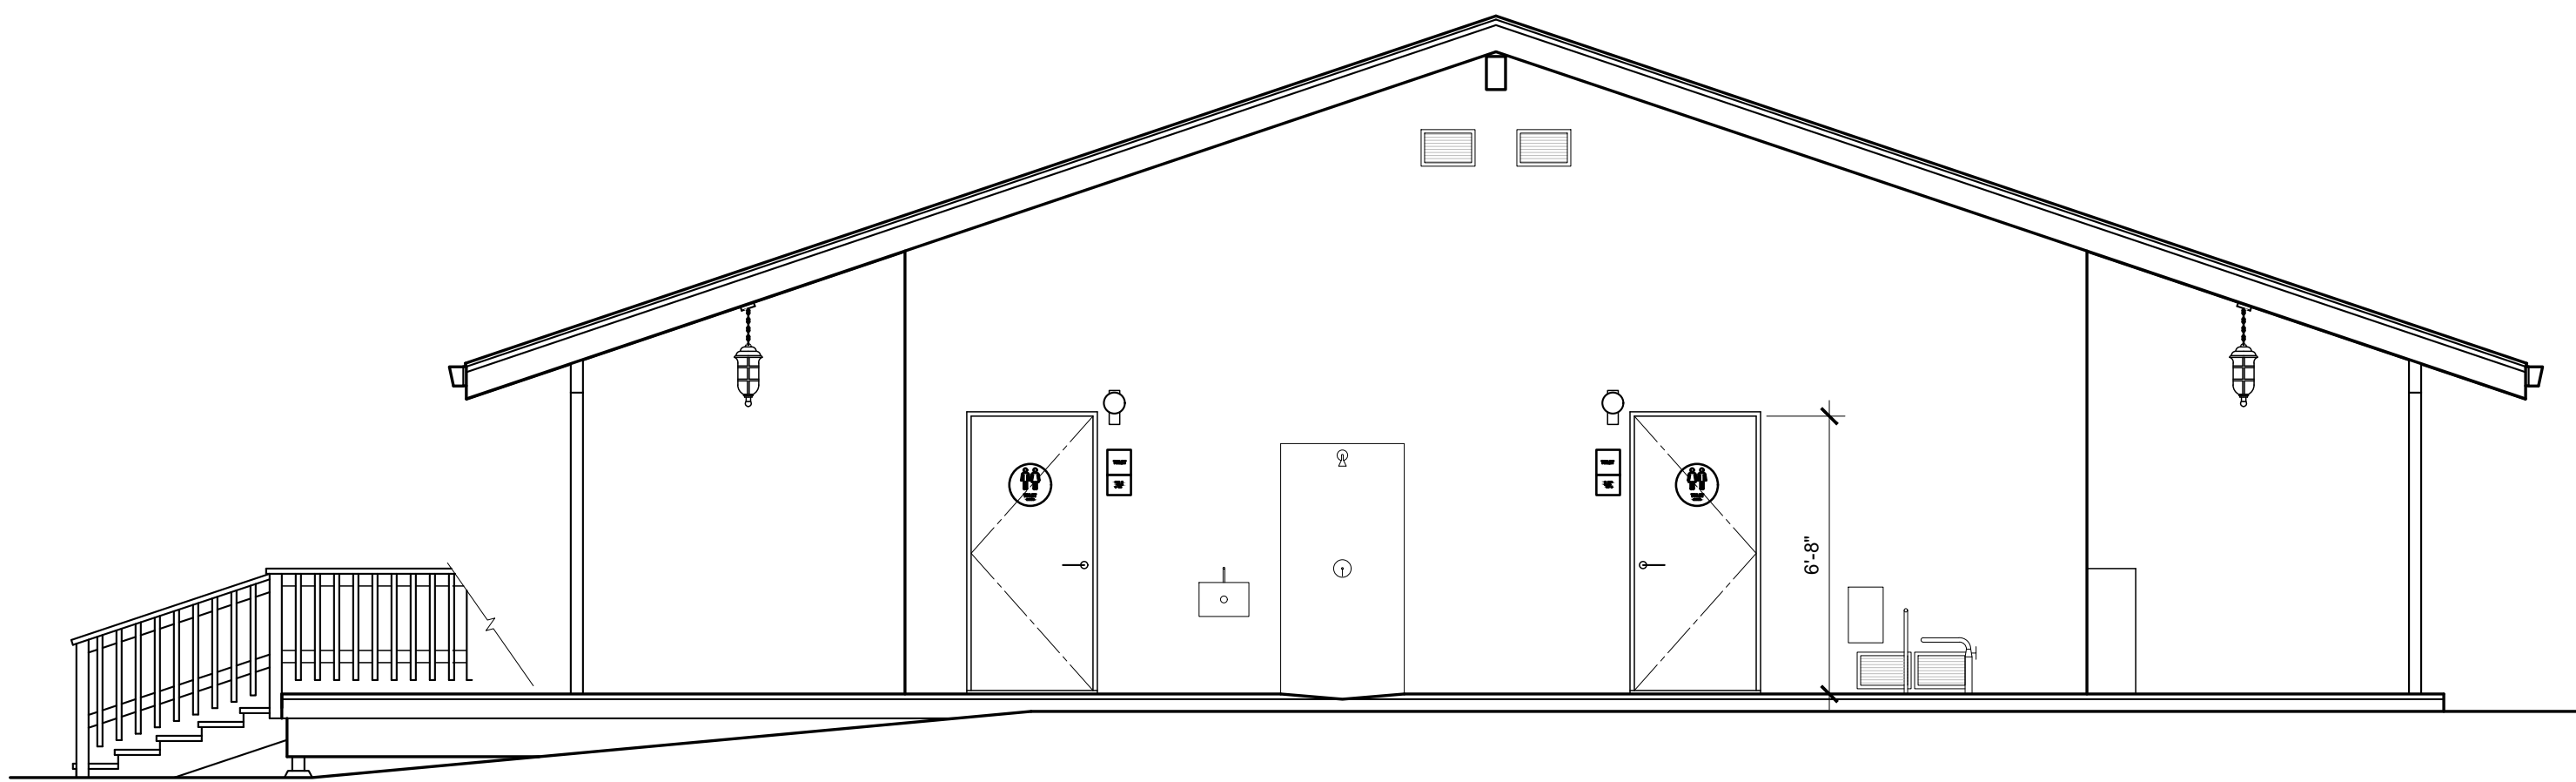


AS- BUILT SOUTH/ POOL SIDE ELEVATION

1 AS- BUILT EXTERIOR ELEVATIONS
1/4" = 1'-0"

2 AS- BUILT EXTERIOR ELEVATIONS
1/4" = 1'-0"


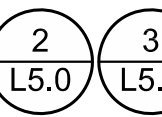
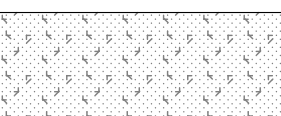

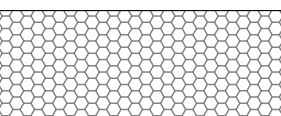
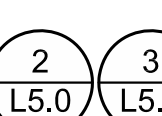

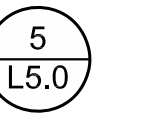
THE VILLAGES AT CUPERTINO





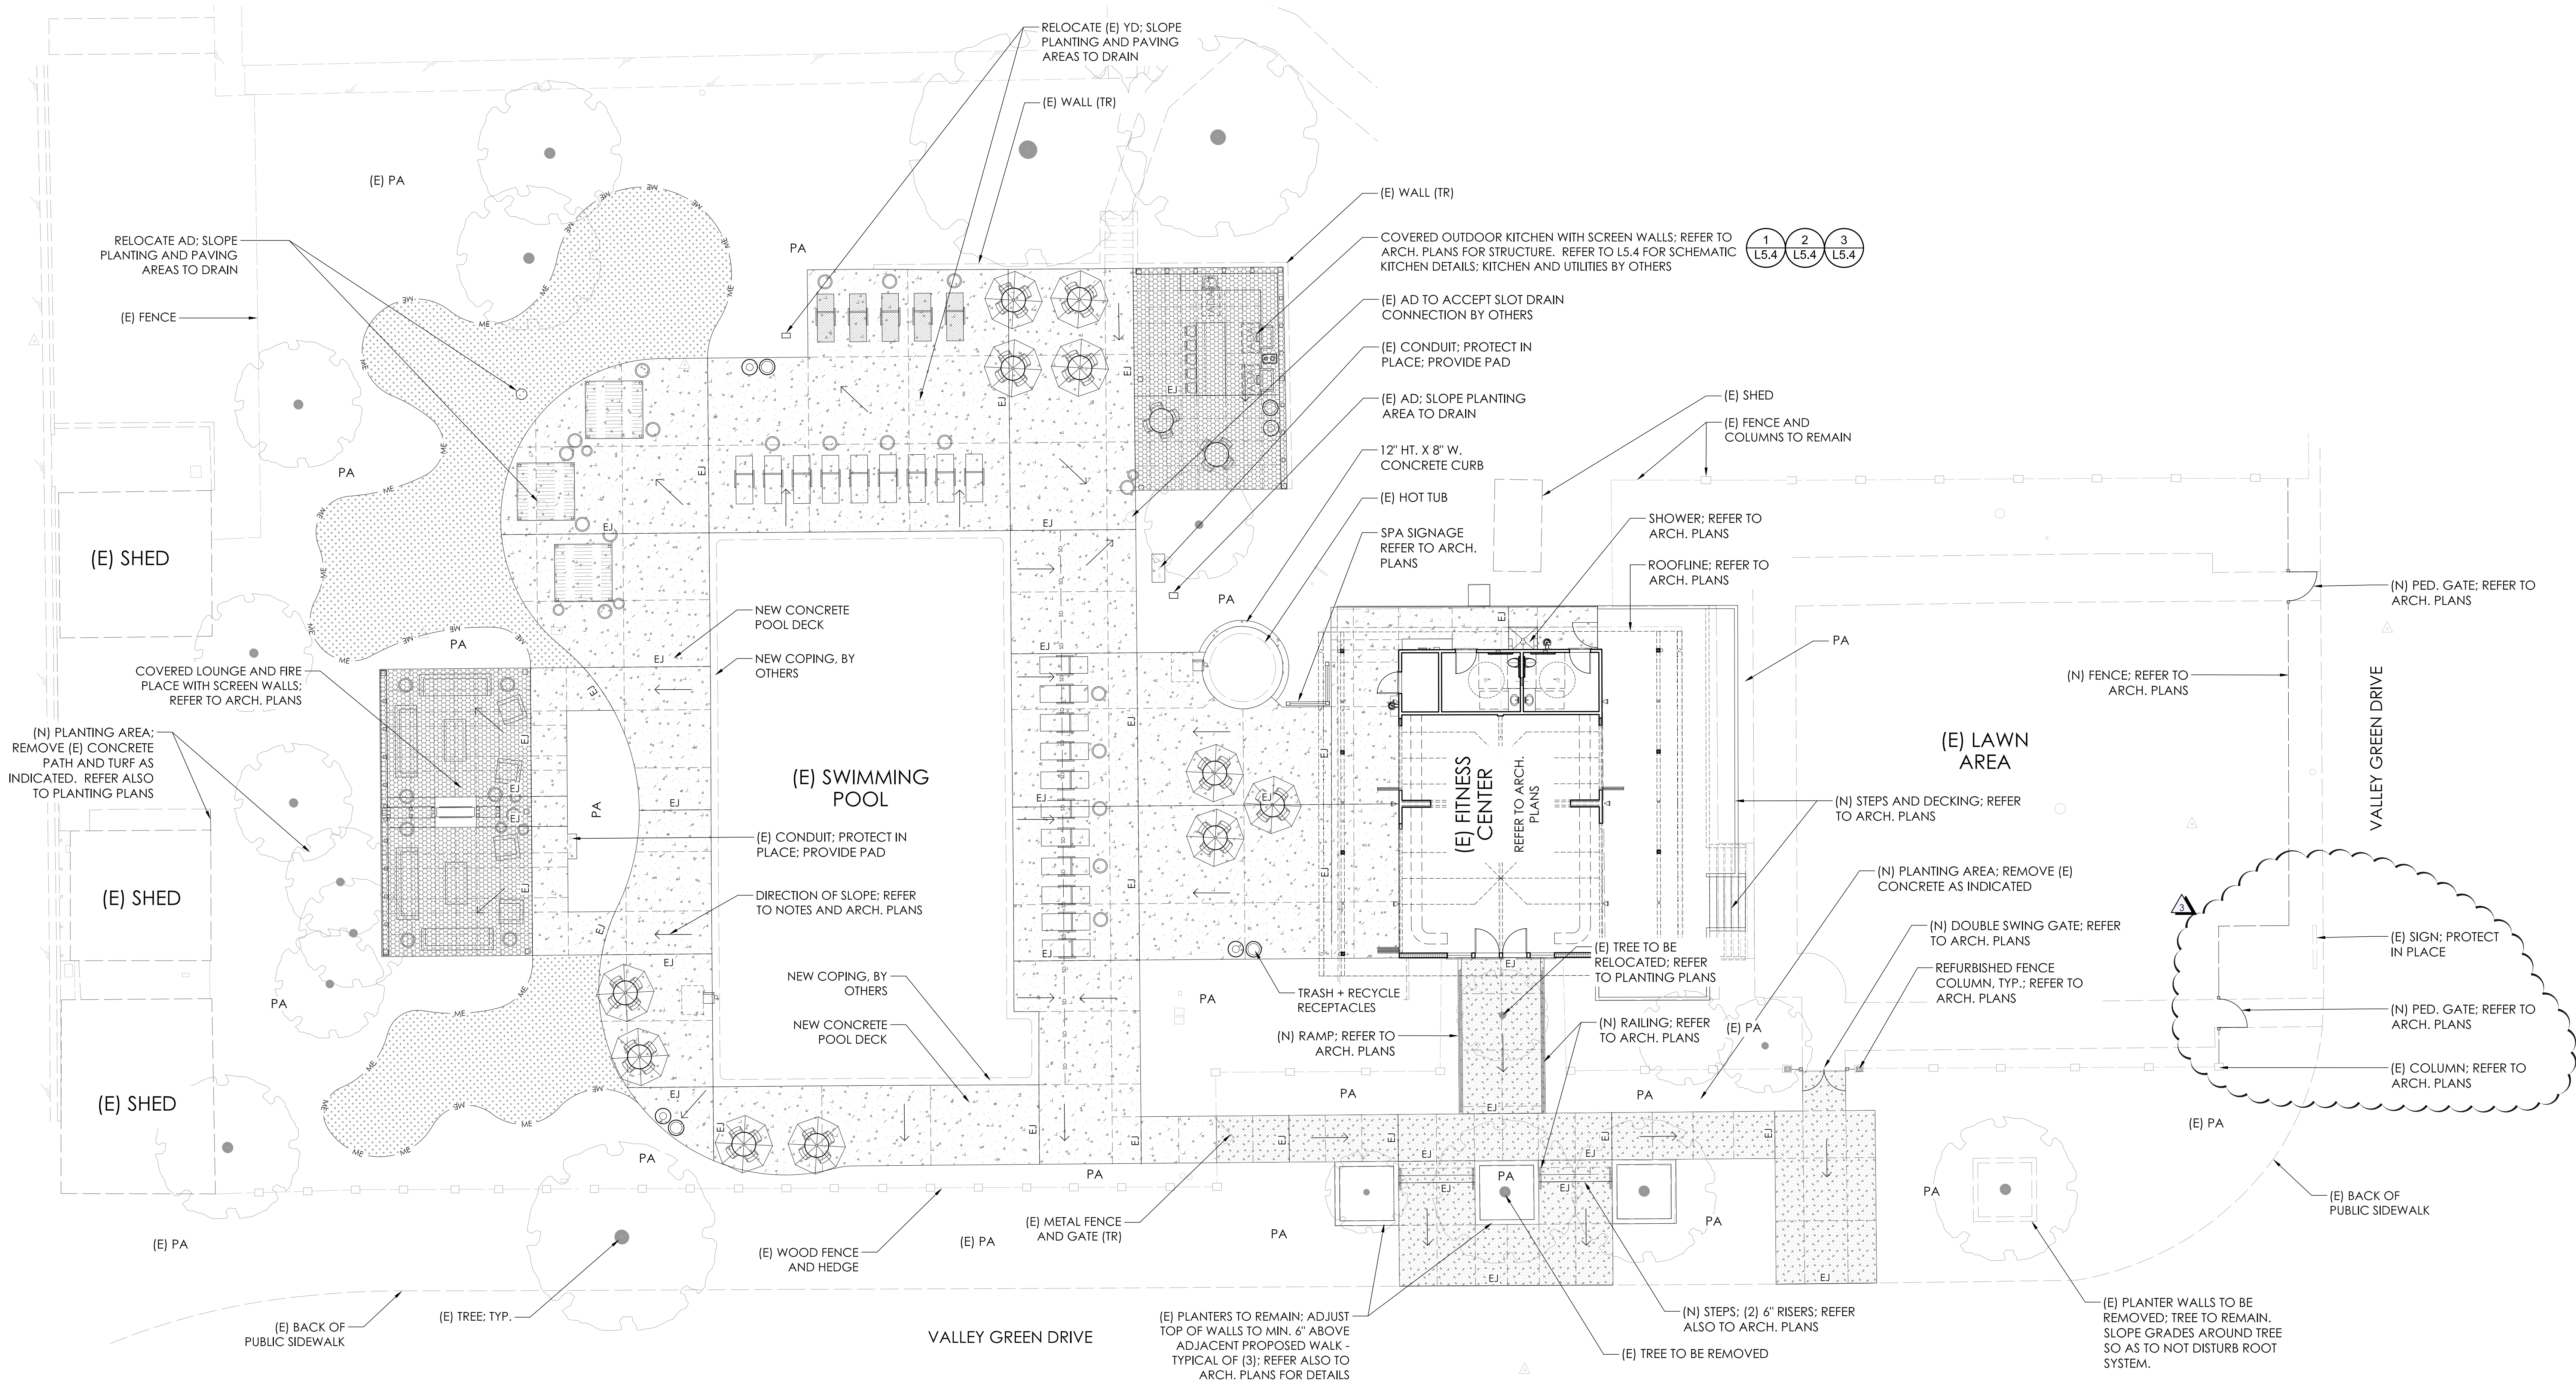



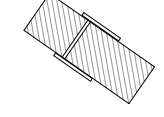

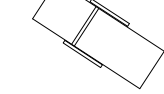

Pool Area Renovation
20875 Valley Green Drive
Cupertino, CA 95014


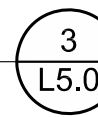
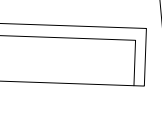

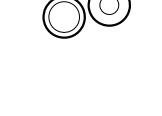

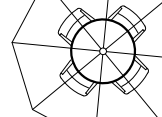

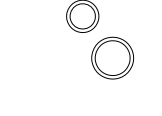



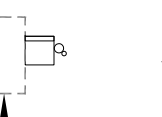
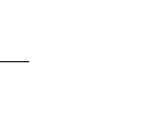
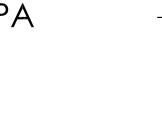
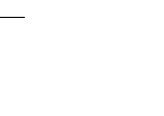

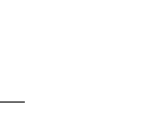
MATERIALS PLAN

MATERIALS LEGEND

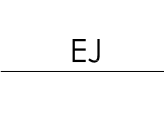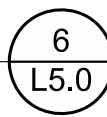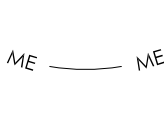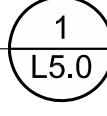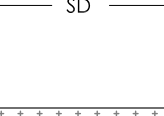Concrete Paving 01 Integral Color: Scofield 3987 Porcelain Gray Finish: Dayton Superior #05 Micro Etch Top-Cast® Slope to Planting Areas and adjacent drains between 0.75% and 2%. Refer also to Architectural Plans.		
Concrete Paving 02 Color: Match Existing Finish: Match Existing Slope to Planting Areas as best possible. Refer also to Architectural Plans.		
Concrete Paving 03 Color: Scofield C-14 French Gray Finish: Dayton Superior #50 Medium Exposure Top-Cast® Slope to Planting Areas and adjacent drains between 0.75% and 2%. Refer also to Arch. Plans.		
Sawcut Control Joint Refer to Sheet L2.0 for Layout, and Detail and Specifications for more information.		

Expansion Joint Refer to Sheet L2.0 for Layout. See detail and verify with Soils Engineer for placement.		
Metal Edging Location per Plan. Create smooth and continuous curves. Refer to Detail and Specifications.		
Slot Drain with Stainless Steel ADA Cover By Others. Connect to Adjacent Area Drain.		
Lawn Area - Rhizomatous Tall Fescue (RTF) Refer to Planting Plan and Specifications for details. Slope at min. 2% / max. 5% to drains.		
Padded Chaise Lounge By Others		
Chaise Lounge By Others		

8' X 8' Family Cabana Secure to pool deck; provide thickened slab at posts per detail. Refer to Specifications. Model: Eclipse 8'x8' square with trellis and Roman shade roof, and trellis back wall and right side Mfr: TUUCI Finish: Powder coat Satin Silver Mounting: In-ground security mount per Manufacturer Furnishings: Per Woodmont Real Estate Services Refer to Specifications.		
Lounge Furniture By Others		
Trash and Recycling Receptacles One of each Receptacle per Plan. Model: By Others		
Table and Chairs with Umbrella By Others		
Planter Pots Model: Miles; Large and Medium Size per Plan Color: Chalk Finish: Standard Mfr: Concreteworks Refer to Specifications		

Chairlift Model: #1000287 Stationary Equipment Mfr: Lifeguard Lift Installation Details and Specifications per Mfr. Refer to Specifications.		
Planting Area Refer to Planting Plan, Notes and Specifications. Slope as needed to drain at min. 2% / max. 10% to meet existing grades.		
Existing Tree Protect in place existing trees to remain. Relocate trees as indicated. Refer to City Ordinance and Standards for removal and protection details.		

REFER TO SHEET L2.0 FOR LAYOUT PLAN AND NOTES
REFER TO SHEET L5.0 FOR SITE DETAILS
REFER TO SHEET L6.0 FOR SPECIFICATIONS

Stamp



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Issuances & Revisions		
No.	Description	Date
1	Permit Set	3/29/2019
2	Permit Set Rev.	1/21/2020
3	Permit/ASA Set Rev.	6/18/2020
4	Building Dept Rev.	8/12/2020
5	ASA/Planning Rev.	9/25/2020

MATERIALS PLAN

Date: 09/25/2020
Project Number: 18-1643

THE VILLAGES AT CUPERTINO

Pool Area Renovation
20875 Valley Green Drive
Cupertino, CA 95014

LAYOUT PLAN

LAYOUT LEGEND

Sawcut Control Joint Refer to Detail and Specifications		5 L5.0
Expansion Joint See detail and verify with Soils Engineer for placement.		6 L5.0
Metal Edging Location per Plan. Create smooth and continuous curves. Refer to Detail and Specifications.		1 L5.0
Slot Drain with Stainless Steel ADA Cover By Others. Connect to Adjacent Area Drain.		
Planting Area Refer to Planting Plan, Notes and Specifications. Slope as needed to drain at min. 2% / max. 10% to meet existing grades.		
ADA Clear Space 30" x 48" clear space for universal access at kitchen elements; refer to Sheet L5.4 for details.		

LAYOUT NOTES

- Contractors shall not scale drawings. Verify all dimensions and conditions in the field. Notify the Owner's representative of any discrepancies on drawings requiring clarification or revision before commencing with the work.
- Contractor shall protect all existing conditions that are to remain, and secure the property during construction.
- Verify all existing conditions and utilities in the field. Notify Owner's representative of any discrepancies that may occur.
- Contractor shall verify and locate all existing underground or underfloor utilities and shall avoid damage to the same.
- All critical dimensions for existing conditions shall be verified in the field before fabrication or construction of new work.
- All work is new unless otherwise noted as "existing", "existing to remain", "(E)", or "to remain", "(TR)".
- All edging and concrete form work is to be laid out with continuous, smooth, and tangential curves per layout plan and points of reference. Adjust as necessary to meet points of tangency for smooth transitions.
- Extend paving joints from corners of existing and proposed features. Extend across pathways perpendicular to one another as indicated on the plans. Variations may be required to meet existing features and are indicated on the plans. For saw cut joints use hand tools to continue joints to vertical faces so as to not impact/cut/deface any existing vertical surfaces.
- Any discrepancy discovered by Contractor in these plans or any field conditions discovered by contractor that may delay or obstruct the proper completion of the work per these plans shall be brought to the attention of the Owner's representative immediately upon discovery. Said notification shall be in writing.
- Construction Contractor agrees that in accordance with generally accepted construction practices, General Contractor will be required to assume sole and complete responsibility for job site conditions during the course of construction of the project, including safety of all persons and property; that this requirement shall be made to apply continuously and not be limited to normal working hours.
- Contractor shall independently review ground, topography, and tree conditions throughout the site, and assume wholly and unconditionally the risk of completing the work set out on these plans, regardless of rock, water table, or other conditions which contractor may encounter in the course of the work.
- Refer to architectural drawings for rough grading and drainage construction.
- Any excess materials shall be considered the property of the Contractor and shall be disposed of away from the job site in accordance with applicable local, state and federal regulations, at all times during construction and until final completion.
- It is the Contractor's responsibility to maintain and use current contract documents for this project, copies of these contract documents shall be available for review by Landscape Architect during site observation.
- Contractor to locate and install pipe sleeves under paving as needed in order to install irrigation piping according to Irrigation plan. Coordinate with Paving Contractor prior to paving installation.
- Contractor to coordinate electrical and telephone needs for irrigation controller with Electrical Contractor.
- Contractor to review, adhere to, and comply with all Construction Documentation including written General Notes and Specifications.

REFER TO SHEET L1.0 FOR MATERIALS PLAN
REFER TO SHEET L5.0 FOR SITE DETAILS
REFER TO SHEET L6.0 FOR SPECIFICATIONS

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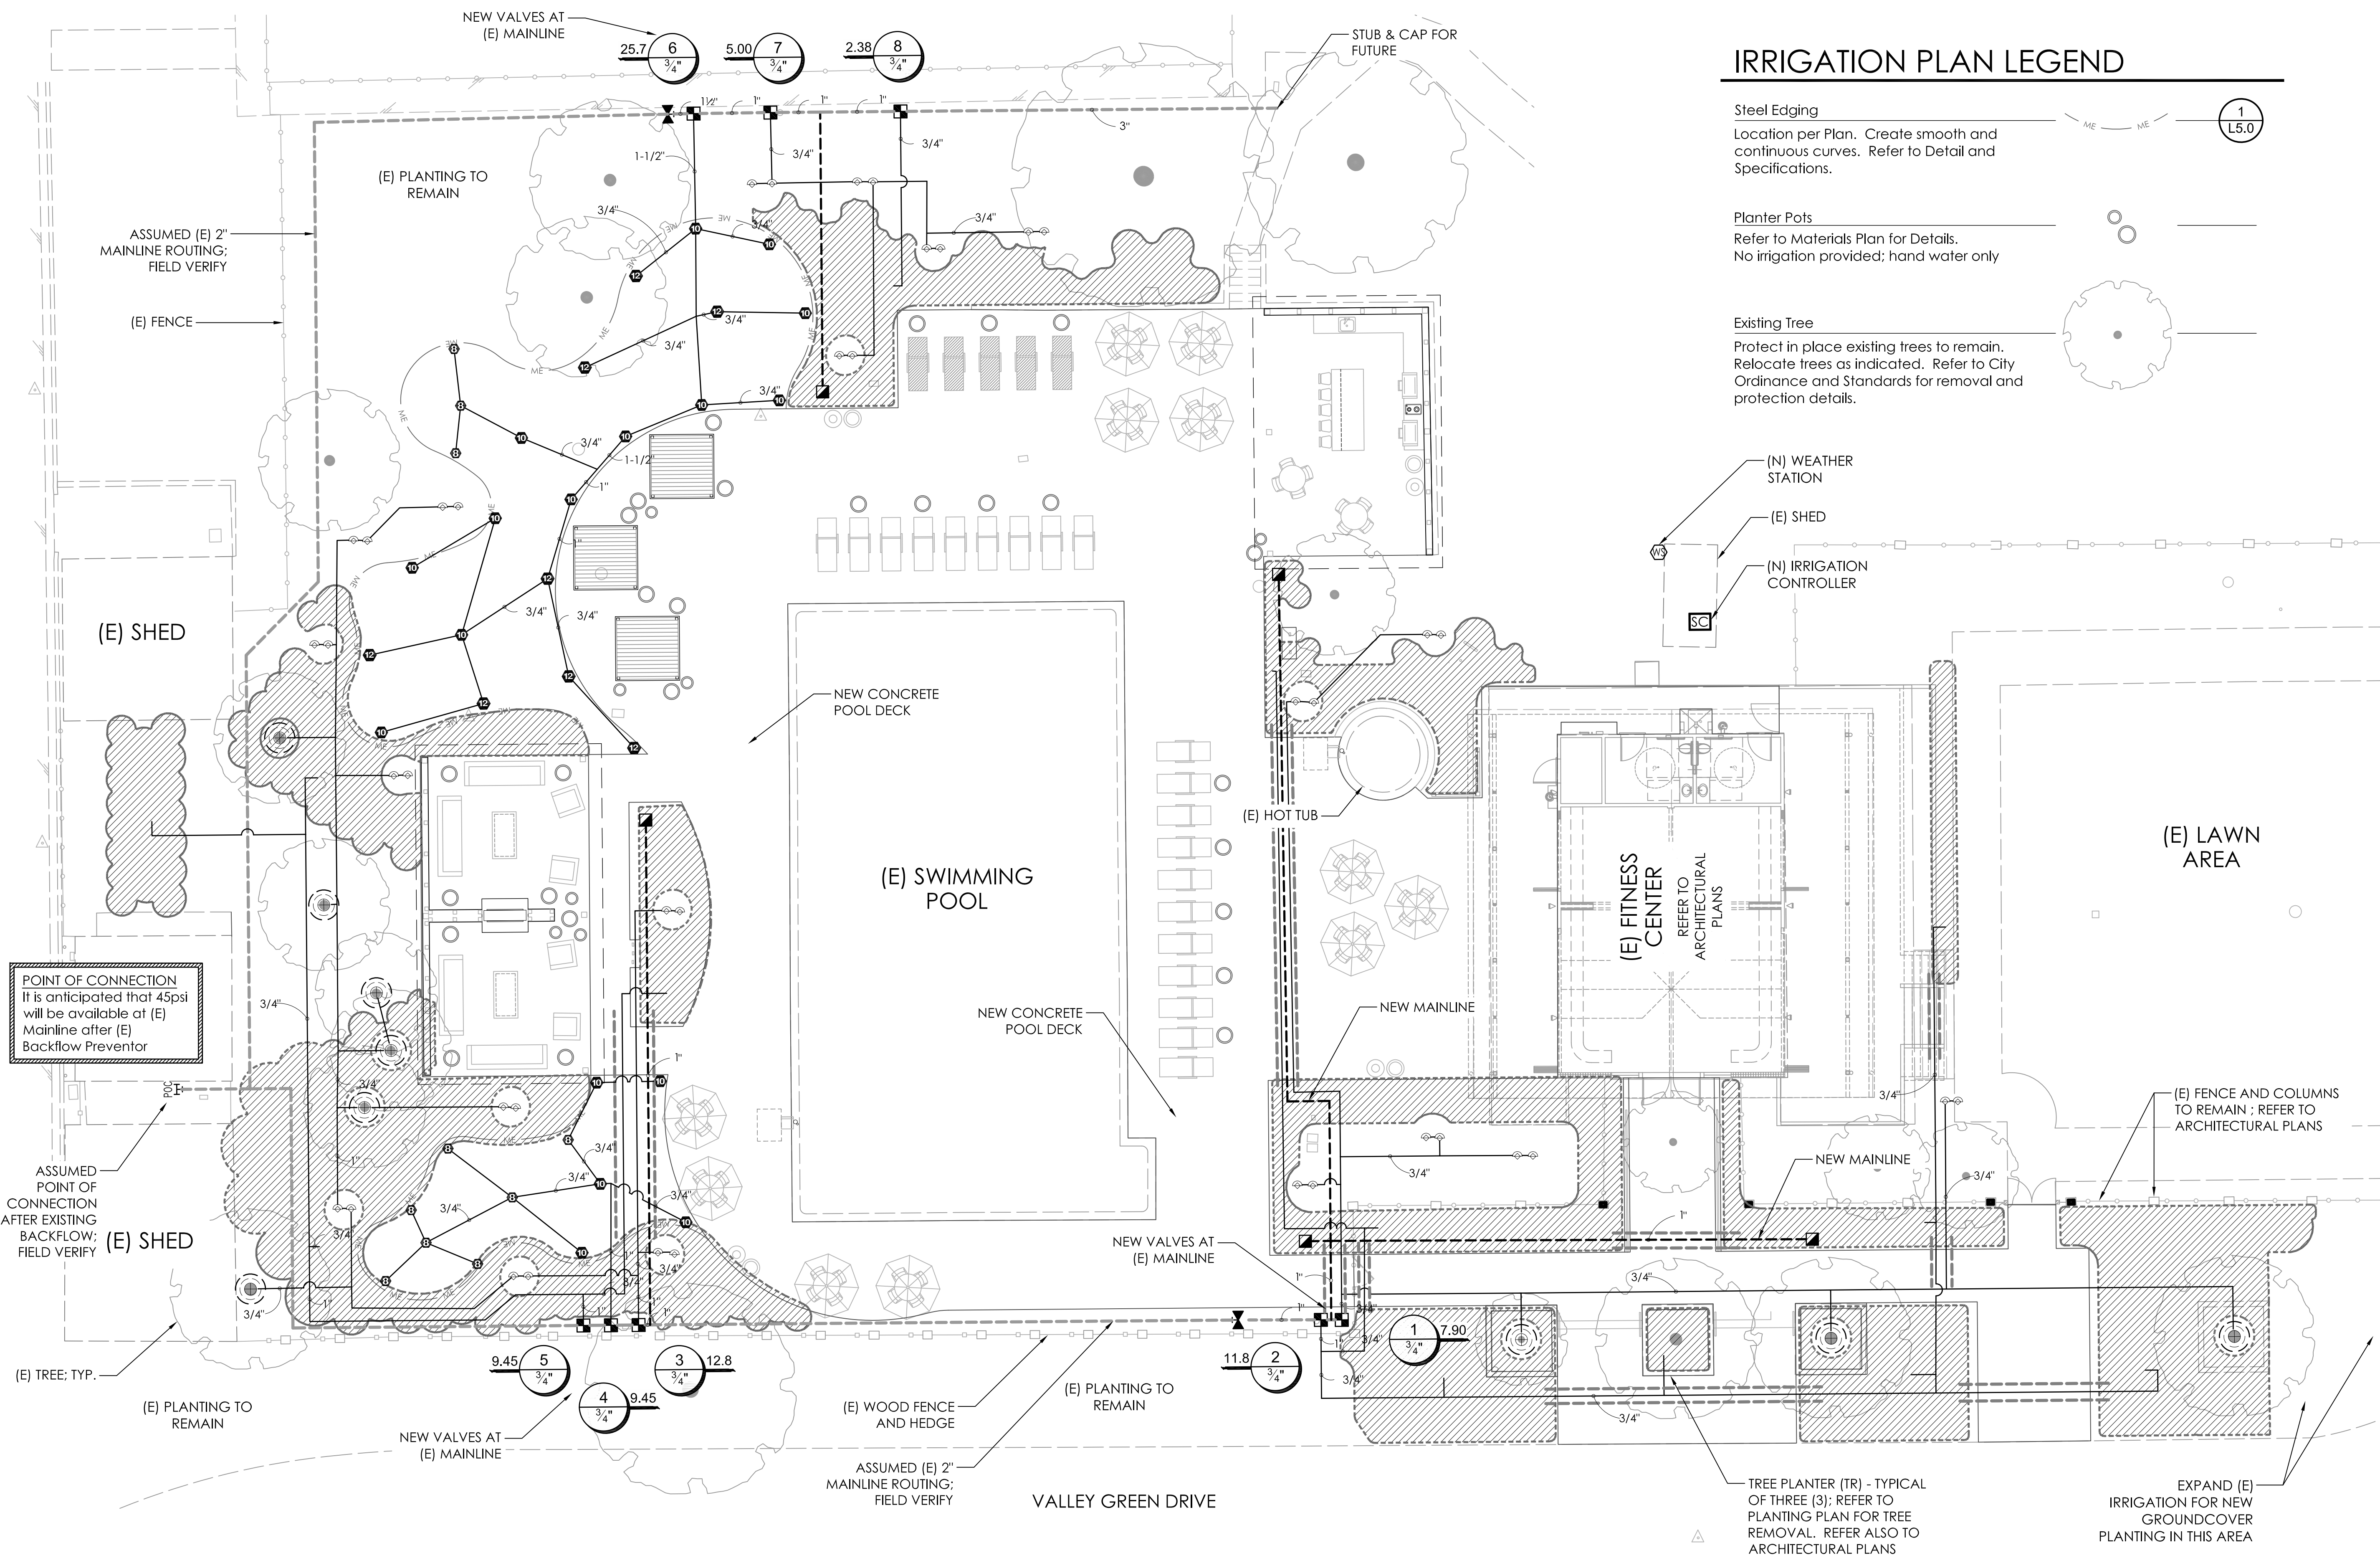
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Issues & Revisions		
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3	Permit/ASA Set Rev.	6/18/2020
4	Building Dept Rev.	8/12/2020
5	ASA/Planning Rev.	9/25/2020

LAYOUT PLAN

Date: 09/25/2020
Project Number: 18-1643

L2.0



IRRIGATION PLAN LEGEND

Steel Edging

Location per Plan. Create smooth and continuous curves. Refer to Detail and Specifications.

Planter Pots

Refer to Materials Plan for Details. No irrigation provided; hand water only

Existing Tree

Protect in place existing trees to remain. Relocate trees as indicated. Refer to City Ordinance and Standards for removal and protection details.

(N) WEATHER STATION

(E) SHED

(N) IRRIGATION CONTROLLER

(E) HOT TUB

NEW MAINLINE

(E) FITNESS CENTER

REFER TO ARCHITECTURAL PLANS

NEW MAINLINE

(E) FENCE AND COLUMNS

TO REMAIN ; REFER TO ARCHITECTURAL PLANS

NEW MAINLINE

NEW MAINLINE

NEW MAINLINE

NEW MAINLINE

NEW MAINLINE

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IRRIGATION NOTES

- The Landscape Contractor shall inspect the site and verify conditions and dimensions prior to construction.
- Install irrigation system in accordance with all local codes and ordinances.
- See details and specifications for procedures, material and installation requirements.
- Prior to cutting into soil, locate all cables, conduits, sewers, and other utilities or architectural features that are commonly encountered underground and take proper precautions not to damage or disturb such improvements. Any damage made during the installation of the irrigation system of the aforementioned items shall be repaired and/or replaced to the satisfaction of the Owner at the Contractor's own expense.
- Contractor to minimize disturbance to existing tree roots on site. Cut minor roots (less than 2" in diameter) of trees indicated to remain in a clean and careful manner where such roots obstruct installation of new construction. If any roots greater than 2" are encountered stop work and contact the Owner's representative immediately.
- The irrigation design is diagrammatic. All piping, valves, etc., shown within paved areas are for design clarification only and shall be installed in planting areas. Main and valves shall be installed in shrub/ground cover areas only. Avoid conflicts with utilities, new planting, new site or architectural elements.
- All valves shall be placed in existing valve boxes. Add boxes as needed for new/replaced valves. All valve boxes shall be located in groundcover areas whenever possible, and shall be bolted down.
- Station operation times shall not exceed the soil's infiltration rate as determined by the soils report.
- All lateral end runs shall be 3/4" size unless otherwise noted.
- Where pipe sizes have been omitted or there is a conflict, refer to the lateral pipe sizing chart for sizes.
- Install two spare common and four spare control wires from each controller in a continuous loop through each valve box connected to that controller for future use.
- Contractor shall coordinate sleeving for irrigation piping with Paving Contractor prior to paving installation. It is the contractor's responsibility for providing appropriate sleeving under hardscape. At each mainline sleeve, provide a separate, appropriate-size sleeve for control/common wiring.
- The landscape Contractor shall coordinate his work with other trades involved (I.E. Grading, Plumbing and Electrical Contractors).
- Contractor shall verify all locations and function of existing irrigation equipment and points of connection that are to remain or to connect to new irrigation systems, upon notification of award of contract. Contractor to immediately notify Landscape Architect if any discrepancies are found between plans and existing irrigation conditions.
- The overall site plan is designed to channel all potential overspray of the irrigation system to planting areas adjacent to the pool deck. Drains are placed within landscape planting areas so water from any potential overspray infiltrates before reaching drains. Drains are located to provide relief from storms and excessive water at the site in those particular events.

IRRIGATION DESIGN

Required Pressure at P.O.C.: 45psi
Required GPM: 26gpm

- Pressure available downstream of BF should be greater than or equal to 45psi
- Contractor to contact landscape architect if found to be different and to determine needed pressure regulation devices (i.e., boost pump or regulating valve).

LATERAL SIZING GUIDE

CIRCUIT GPM	PIPE SIZE	PIPE CLASS
0-8 GPM	3/4"	SCH. 40 PVC
9-12 GPM	1"	SCH. 40 PVC
13-22 GPM	1-1/4"	SCH. 40 PVC
23-30 GPM	1-1/2"	SCH. 40 PVC
31-50 GPM	2"	SCH. 40 PVC
51-70 GPM	2-1/2"	SCH. 40 PVC
71-110 GPM	3"	SCH. 40 PVC

CONTROL WIRE SIZING GUIDE

Control/ Common Wire	No. 14	No. 12	No. 10	No. 8
No. 14	1700'	2000'	2400'	2700'
No. 12		2700'	3300'	3800'
No. 10			4800'	5200'
No. 8				6700'

System Operating Flow & Pressure

Maximum flow: 27 GPM
Static Design Pressure: 30 psi
Normal Operating Pressure: 45 psi
Contractor to confirm pressure at point of connection, per plan, prior to the installation of any irrigation equipment.

REFER TO SHEET L4.0 FOR PLANTING PLAN AND NOTES
REFER TO SHEET L5.1 AND L5.2 FOR CALC'S AND DETAILS
REFER TO SHEET L6.1 FOR IRRIGATION SPECIFICATIONS

IRRIGATION PLAN

IRRIGATION SCHEDULE

SYMBOL	MANUFACTURER/MODEL	QTY	ARC	PSI	GPM	RADIUS	SYMBOL	MANUFACTURER/MODEL/DESCRIPTION	QTY
⊗	Rain Bird RD-06-S-P30-U HE-VAN Series	10	Adj	30		8'	■	Hunter HQ-33DLRC Quick coupler valve, red brass and stainless steel, with 3/4" NPT inlet, 2-piece body.	5
⊗	Rain Bird RD-06-S-P30-U HE-VAN Series	17	Adj	30		10'			
⊗	Rain Bird RD-06-S-P30-U HE-VAN Series	8	Adj	30		12'	⌵	Nibco T-113-K Class 125 bronze gate shut off valve with cross handle, same size as mainline pipe diameter at valve location. Size Range - 1/4" - 3"	2
⊗	Rain Bird 1804-SAM-PRS-1400 Flood	19	360	30	0.50	3'			
⊗	Rain Bird RWS-M-B-C-SOCK-1402	19	360	30	0.50	3'			
SYMBOL	MANUFACTURER/MODEL/DESCRIPTION	QTY					SC	Rain Bird ESP4-SMTE with (3) ESP-SM6 22 Station Outdoor Smart Modular Control System for Residential and Light Commercial Use. Wall Mount, Tipping Bucket Rain Sensor that Measures Rainfall.	1
⊗	Irritrol 2507DK-MF Electric Drip Zone Valve Kit: 3/4" 2507 Valve, Filter, Medium Flow Regulator and Fittings.	8					WS	On-site Weather Station Weather Station package with Controller	1
⊗	On-surface Dripline Rings at Existing Tree Rain Bird XFD-09-12 On-surface Dripline Tree rings 0.9gph on-surface dripline with 12" O.C. emitter spacing at 24" O.C. offset ring-to-ring. Refer to Tree Drip Ring Irrigation Details on Sheets L5.1 and L5.2.	9					POC	Point of Connection 2"	1
⊗	Area to Receive Dripline Rain Bird XFCV-06-18" XFCV On-Surface Landscape Dripline with a Heavy-Duty 3.5 psi Check Valve, 0.6 GPH emitters at 18" O.C. Dripline laterals spaced at 18" apart, with emitters offset for triangular pattern. Great for elevation change. Specify XF insert fittings.	3,547 Lf.						Irrigation Lateral Line: PVC Schedule 40	1,520 Lf.
								Existing Irrigation Mainline. Assume Size 2". Verify Location and size. Notify Landscape Architect if different. Reuse in existing location. Add new valves as shown. Replace as needed to accommodate new routing.	
								New Irrigation Mainline: PVC Schedule 40 Size per Plans	244.3 Lf.
								Pipe Sleeve: PVC Schedule 40 Min. 4" for Laterals; Min. 6" for Mainline	166.9 Lf.

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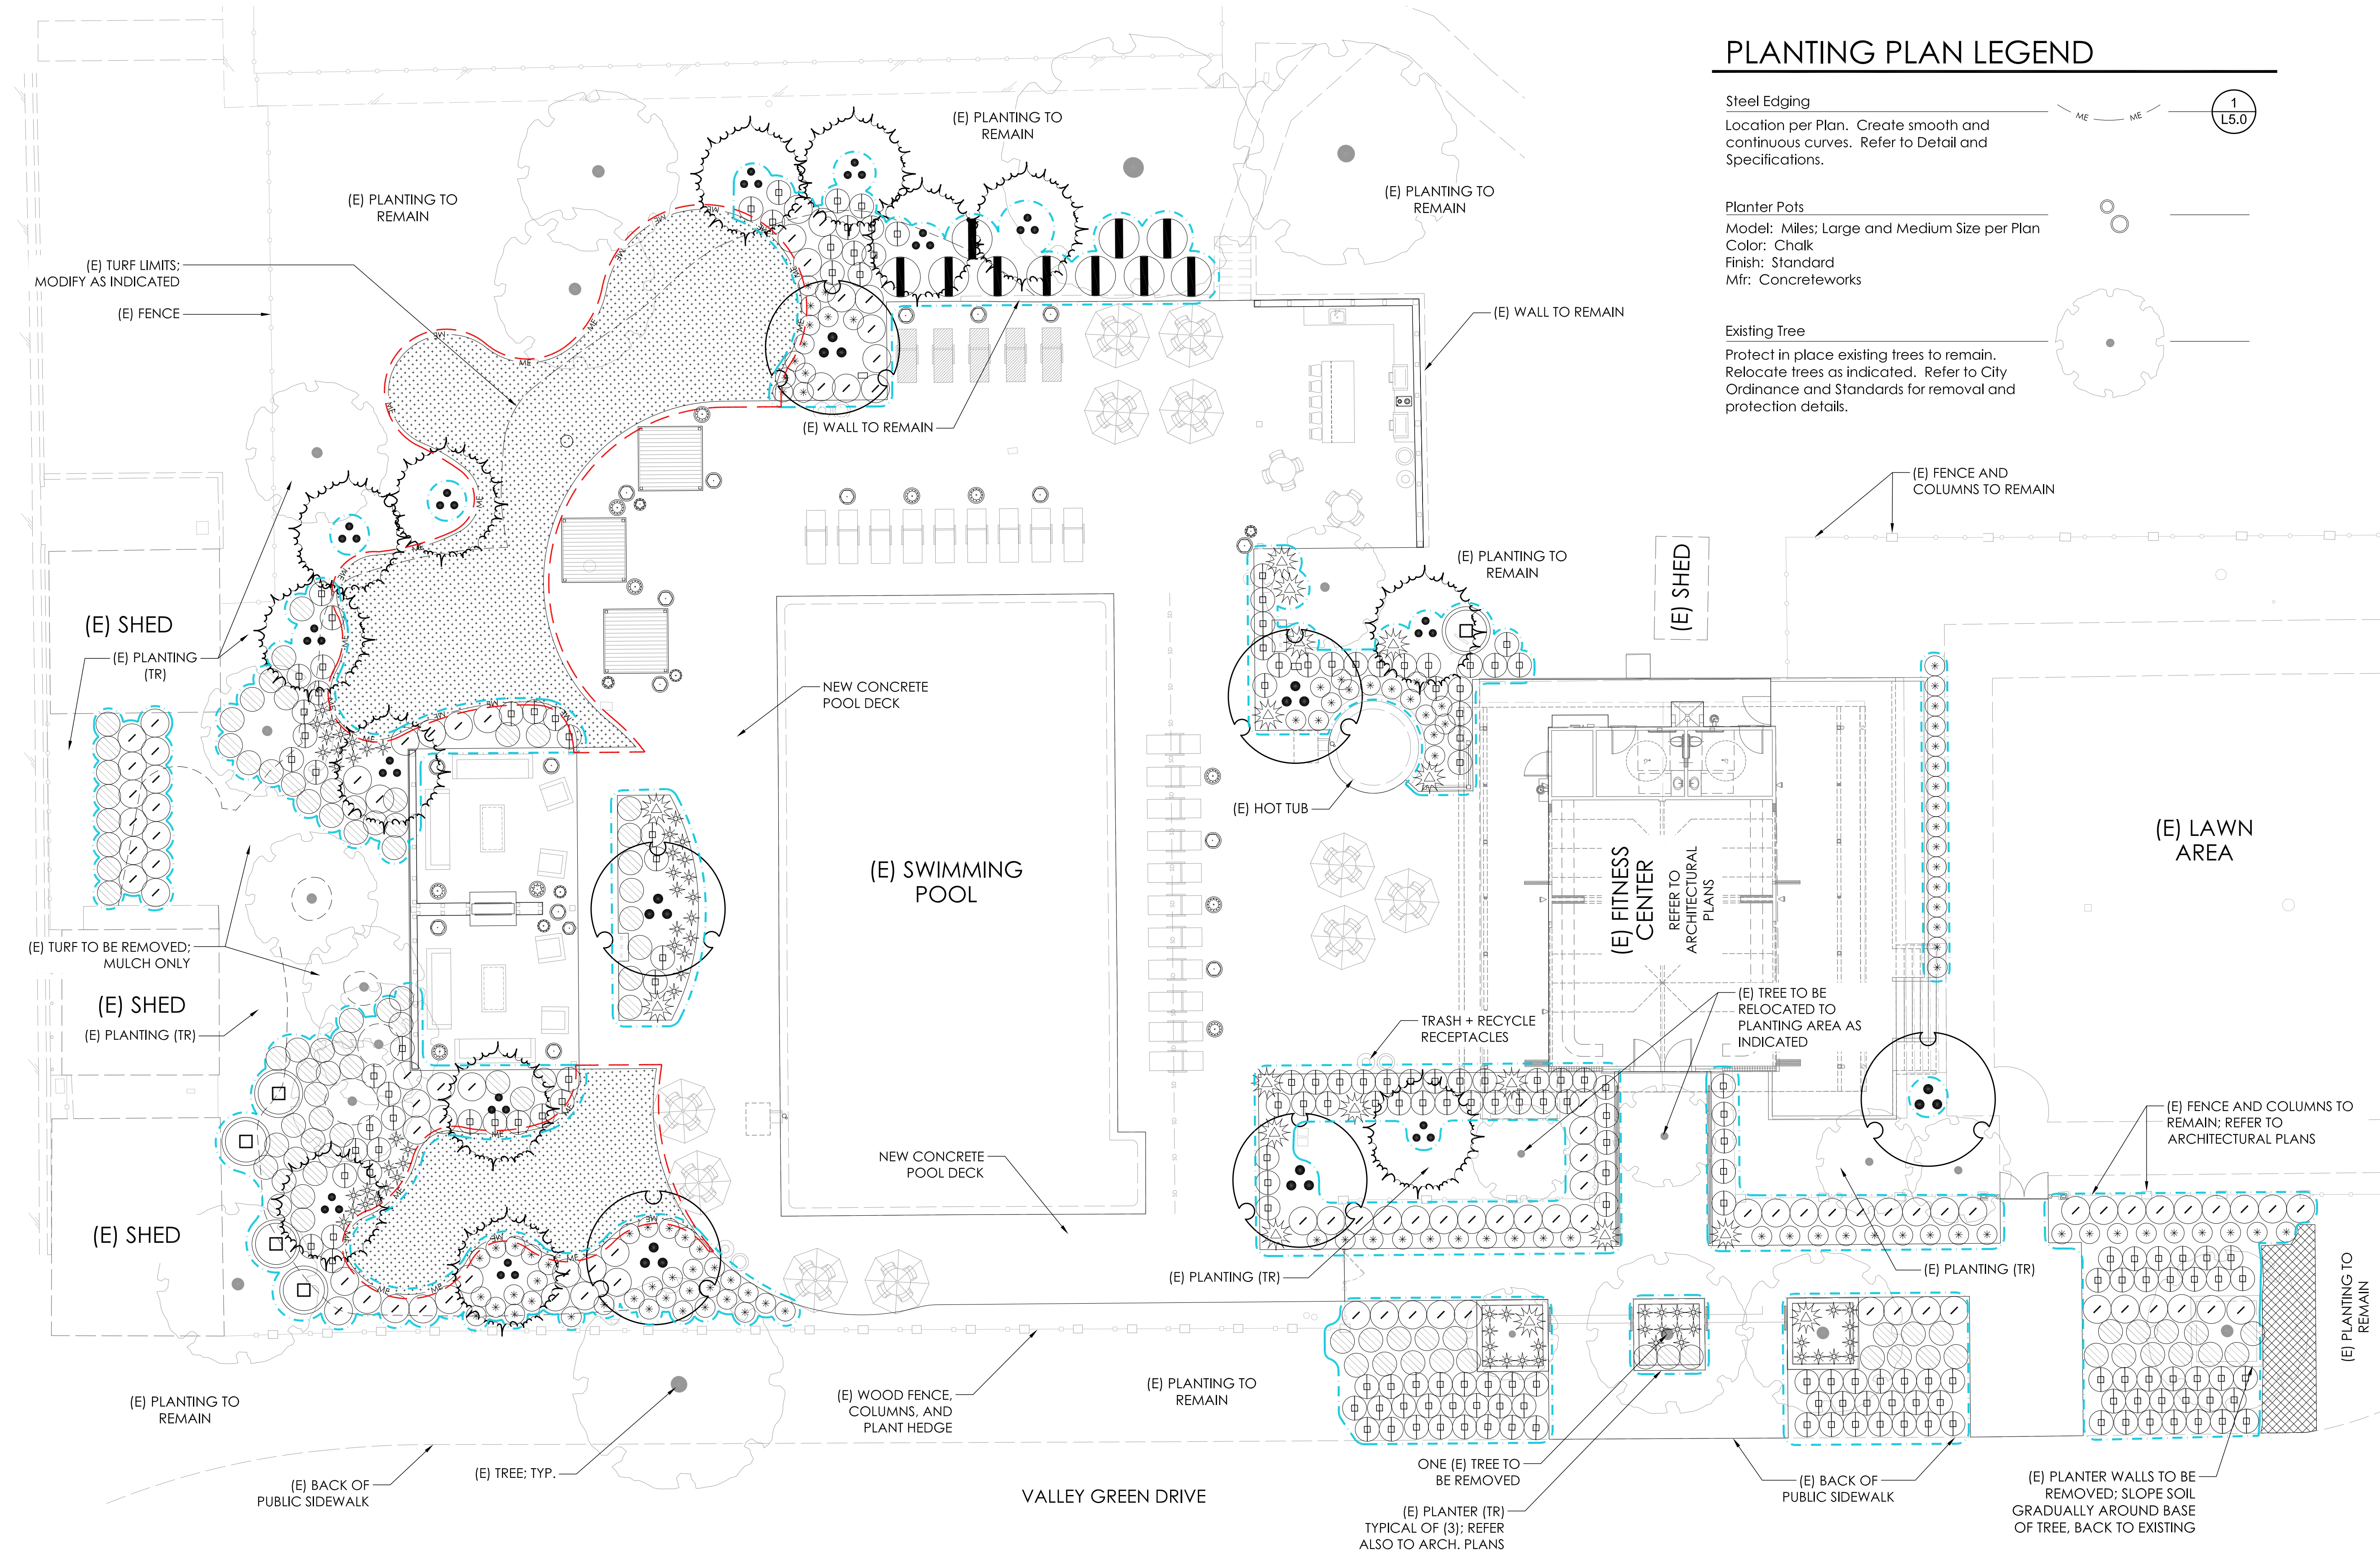
No.	Description	Date
1	Permit Set	3/29/2019
2	Permit Set Rev	1/21/2020

Key Plan/Consultant Stamp

IRRIGATION PLAN

Date: 01/21/2020
Project Number: 18-1643

L3.0



PLANTING PLAN LEGEND

Steel Edging

Location per Plan. Create smooth and continuous curves. Refer to Detail and Specifications.

Planter Pots

Model: Miles; Large and Medium Size per Plan
Color: Chalk
Finish: Standard
Mfr: Concreteworks

Existing Tree

Protect in place existing trees to remain. Relocate trees as indicated. Refer to City Ordinance and Standards for removal and protection details.

PROJECT INFORMATION

OWNER/APPLICANT

Valley Green Recreation Association, Inc.
Villages at Cupertino 3
c/o Woodmont Real Estate Services
1050 Ralston Avenue
Belmont, CA 94002

APN

326-09-040

PROJECT SCOPE OF WORK

Demolition and removal of 11,656sf of existing concrete paving including pool deck and Village Green Drive frontage/entry. Installation of 10,847sf of concrete paving including concrete pool decking, deck drains, two accessible chair lifts, steps, handrails, and an entry ramp. Installation of low-water use landscape plantings with a rehabilitated high-efficiency drip and spray irrigation system. There is a net reduction in hardscape by 809sf.

Conversion or removal of 4,689sf of existing lawn to new low-water use tree, shrub, groundcover planting, and hardscape, with new WUCOLS compliant irrigation spray heads, smart controller and sensors, and high-efficiency on-grade inline drip irrigation circuits. There is a net reduction in lawn area by 2,458sf.

IRRIGATION SOURCE

Municipal Water System

APPLICABLE CODES

CBC 2016, CPC, CEC, CMC, Californian Energy Code, Cupertino Municipal Code

GRADING NOTE

With the exception of the of the new entryway ramp, walkways, and steps, all pedestrian pavement and pool decking shall be installed with a finish slope of between 0.75% and 2%. See also Note 6, below. For Fitness Center entry access and notes refer to also to Architectural Plans.

PLANTING NOTES

- The plant list is provided for the convenience of the Contractor. The Contractor shall verify all plant counts and if a discrepancy exists, the plan shall govern.
- Substitution of specified plant material shall not be made unless otherwise approved by the Landscape Architect. Same genus different species substitutions are acceptable provided the variety is similar in growth habit to the specified plant and water use is the same. Example: Escallonia 'Terry' could sub for 'Red Elf'. Rhipirolepis can not substitute for Escallonia as they have different water use requirements. Certificates of compliance will not be completed for projects which exceed the water use of specified plant materials until conformance with the water efficient landscape requirements is achieved.
- Contractor to protect in place all existing trees to remain. Refer to specifications for tree protection notes.
- Contractor to verify trees and all existing (E) plantings to be removed with Landscape Architect.
- Contractor to protect all existing improvements to remain including the irrigation system and associated laterals, wiring, mainline, heads.
- Finish grade in planting areas shall be 4" below the top of adjacent curbs, walks or paved areas. Finish grade shall be smooth and even prior to installation of 3" bark mulch. All landscape areas not covered with live material shall be covered with 3" of bark mulch.
- Planting areas shall be kept clean and free from all waste materials such as concrete, asphaltic waste, lumber or other such materials. Waste materials shall be removed by excavation of the soil. Replace with clean native top soil.
- See details and specifications for procedures, material, and installation requirements.
- Imported top soil (if required) shall be fertile, friable sandy loam of uniform composition. Clay particles shall not exceed 9% by volume. The soil shall be free from subsoil, refuse, roots, rocks over 1" in diameter or other deleterious material. The imported soil shall be capable of sustaining healthy plant life, native top soil shall be used where available prior to importing soil. A soils report shall be provided for all imported top soils, per specifications.
- Adjacent streets, sidewalks and other areas shall be kept free of mud, dirt or similar nuisances resulting from earthwork operations.
- Any damaged or destroyed landscaping shall be replaced to the satisfaction of the Owner's Representative.
- For best results, native plant materials should not have their roots disturbed. For plastic cans, remove bottom of can, place in plant pit and cut sides to remove. Cut metal cans in three places minimum and carefully slide root ball into plant pit, for large plant material, use bottom support as necessary.
- Contractor to install root barrier at all trees within 5'-0" of pavement, per specifications.
- Soil sample reports and irrigation water suitability report shall be reviewed by Landscape Architect prior to amending soils, per specifications.

HYDROZONE LEGEND

Low Water Use Hydrozone

Refer also Irrigation Plan L3.0

High Water Use Hydrozone

Refer also Irrigation Plan L3.0

PLANTING PLAN

PLANT SCHEDULE

TREES	BOTANICAL NAME / COMMON NAME	SIZE	WATER USE	SPACING	QTY	GRASSES	BOTANICAL NAME / COMMON NAME	SIZE	WATER USE	SPACING	QTY
	Lagerstroemia x 'Natchez' / Crape Myrtle	24"box	Low	Per Plan	13		Carex buchananii / Leather Leaf Sedge	1 gal	Medium	Planter Pot	18
	Pistacia chinensis / Chinese Pistache Multi-Trunk	24"box	Low	Per Plan	6		Lomandra longifolia 'Breeze' / Dwarf Mat Rush	1 gal	Low	Per Plan	107
	Nandina domestica 'Harbour Dwarf' / Dwarf Heavenly Bamboo	1 gal	Low	Per Plan	97		Muhlenbergia capillaris 'Regal Mist' TM / Muhly	1 gal	Low	Per Plan	96
	Phormium tenax 'Apricot Queen' / New Zealand Flax	5 gal	Low	Per Plan	17		Senecio mandraliscae 'Blue Chalk Sticks' / Senecio	1 gal	Low	Planter Pot	13
	Phormium tenax 'Tom Thumb' / Dwarf Green Flax	1 gal	Low	Per Plan	68		Trachelospermum jasminoides / Chinese Star Jasmine	1 gal	Medium	36" O.C.	161sf
	Pittosporum tobira 'Compactum' / Compact Pittosporum	5 gal	Low	Per Plan	5		New Drought Resistant Lawn	Sod	High		2,231sf
	Pittosporum tobira 'Cream De Mint' TM / Cream De Mint Dwarf Mock Orange	1 gal	Low	Per Plan	183		Rhizomatous Tall Fescue (RTF). Refer to manufacturer specifications for placement, soil preparation and maintenance. Mfr.: Sierra Sod or equal				
	Xylosma congestum 'Compacta' / Compact Xylosma	5 gal	Low	Per Plan	10						
ANNUALS/PERENNIALS	BOTANICAL NAME / COMMON NAME	SIZE	WATER USE	SPACING	QTY	GROUND COVERS	BOTANICAL NAME / COMMON NAME	SIZE	WATER USE	SPACING	QTY
	Hesperaloe parviflora 'Brakelights' TM / Brakelights Red Yucca	1 gal	Low	Planter Pot	4						

STATEMENT OF COMPLIANCE

I have complied with the criteria of the Water Conservation in Landscaping Ordinance and applied them for the efficient use of water in the landscape design plan.

PREPARER NAME: Christine Talbot

PREPARER SIGNATURE:

PROFESSIONAL LICENSE: PL CA #5226

Stamp



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Issuances & Revisions

No.	Description	Date
1	Permit Set	3/29/2019
2	Permit Set Rev.	1/21/2020
3	Permit/ASA Set Rev.	6/18/2020

PLANTING PLAN


Date: 06/24/2020

Project Number: 18-1643

REFER TO SHEET L5.3 FOR PLANTING DETAILS
REFER TO SHEET L6.2 FOR SOIL AND PLANTING
SPECIFICATIONS

THE VILLAGES AT CUPERTINO


Pool Area Renovation
20800 Valley Green Drive
Cupertino, CA 95014

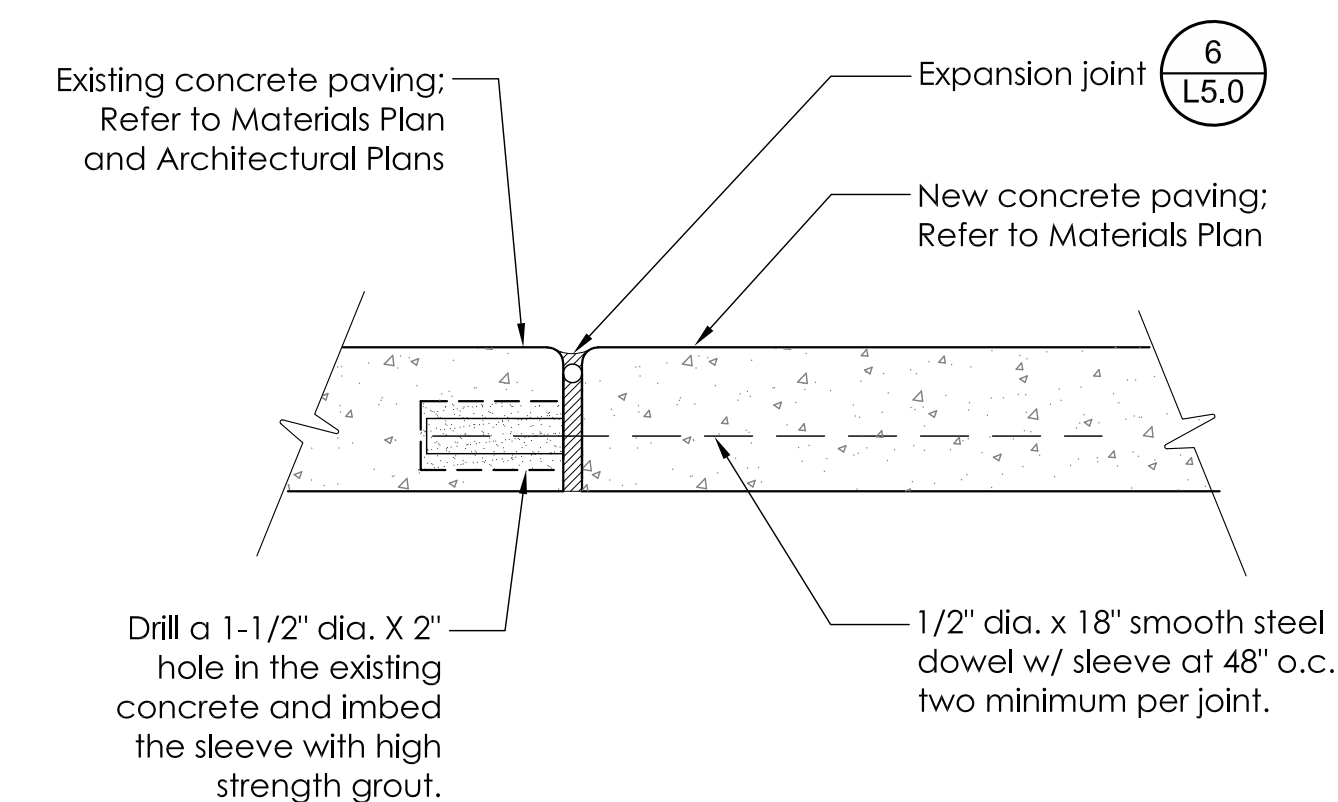

4 CONCRETE JOINT AT EXISTING PAVING

NOT TO SCALE

P-RE-VIL-12

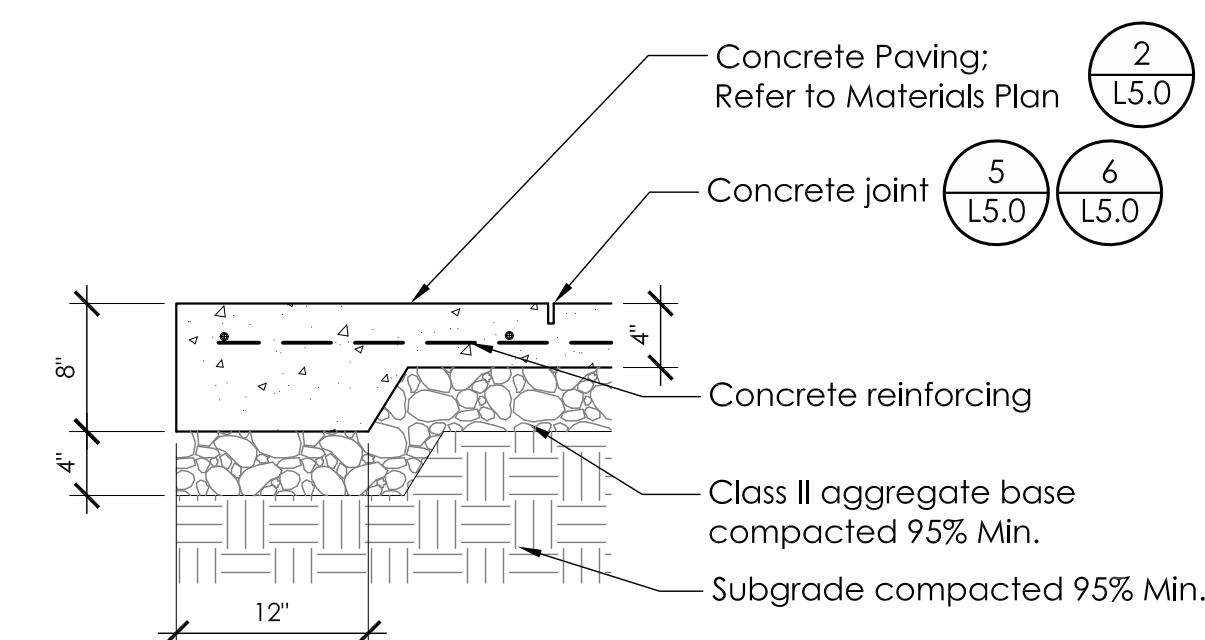


NOTES:
Thickened cross-sections are to be used along outside edges of concrete paving and where anchoring is required for site features and furnishings, i.e., Family Cabana.

3 PEDESTRIAN CONC. PAVING - THICKENED EDGE

NOT TO SCALE


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EXPANSION JOINT

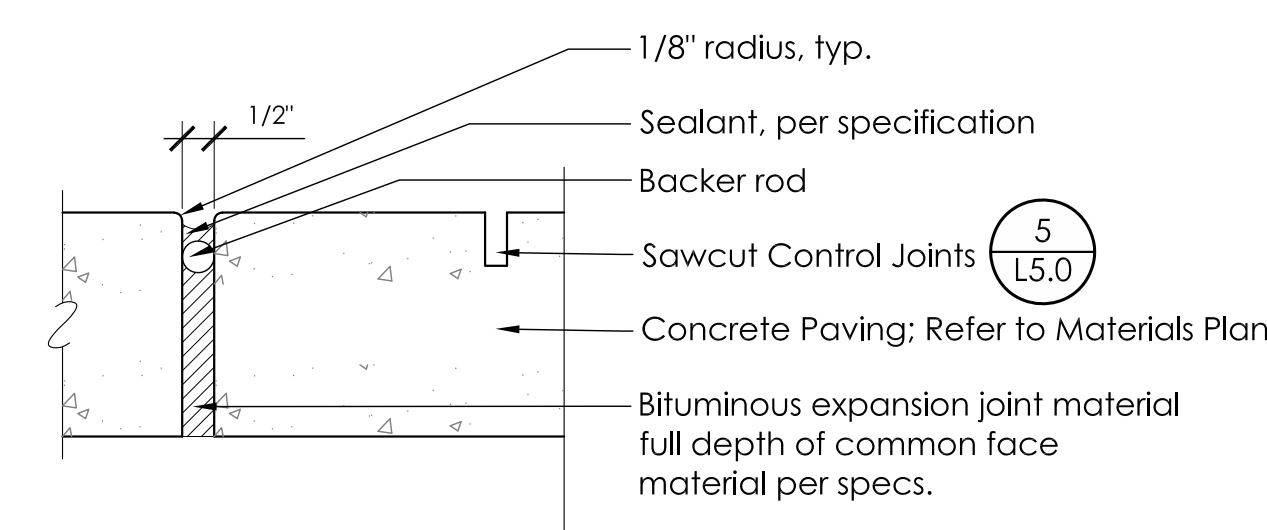NOT TO SCALE


P-RE-VIL-16



5 SAWCUT CONTROL JOINT

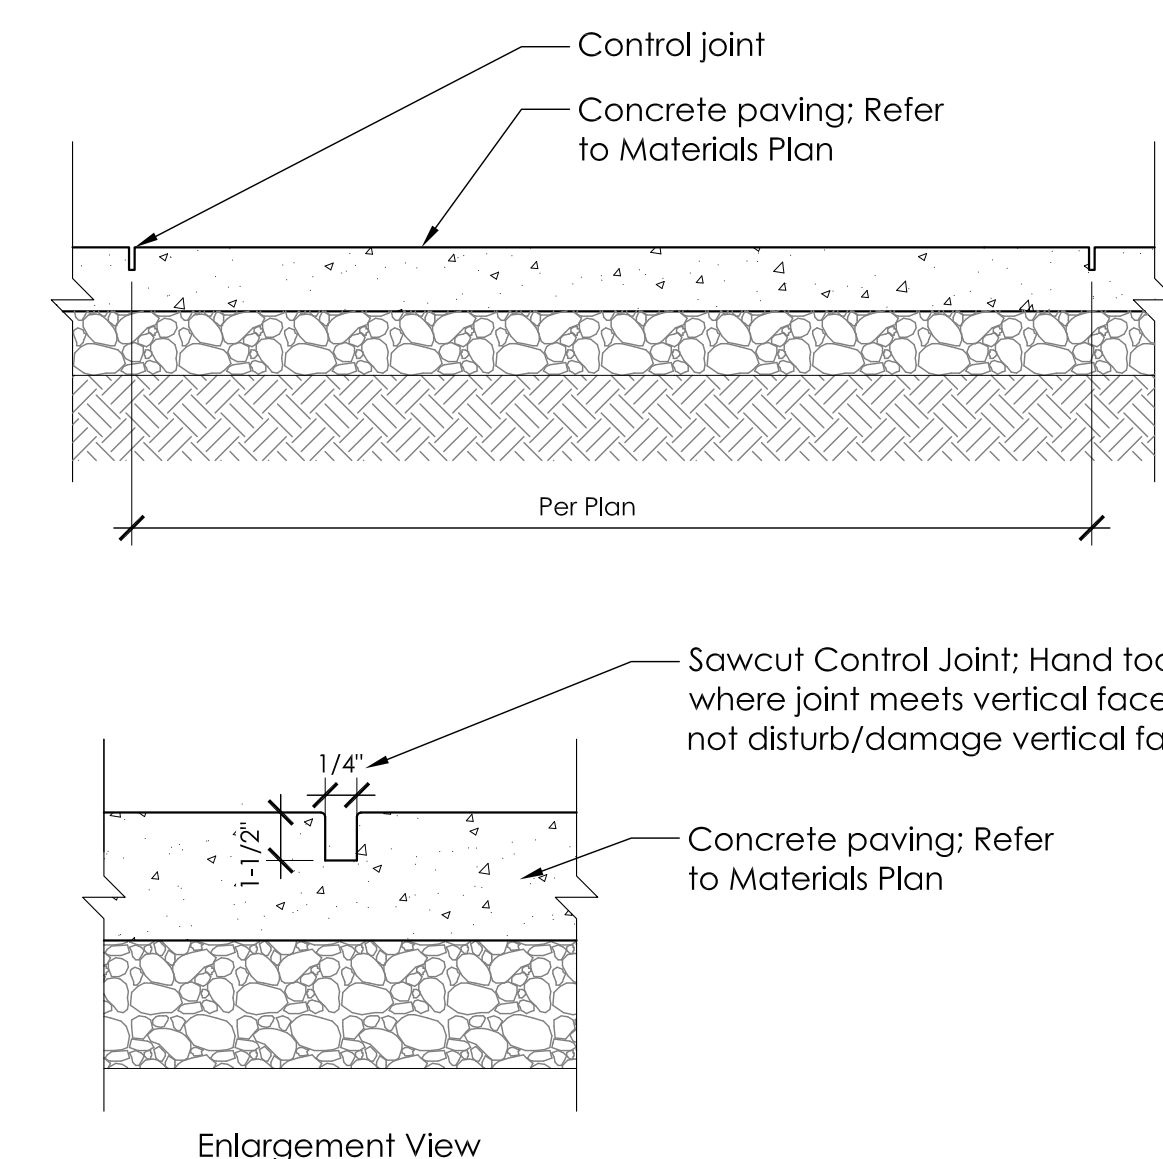NOT TO SCALE

P-RE-VII-06

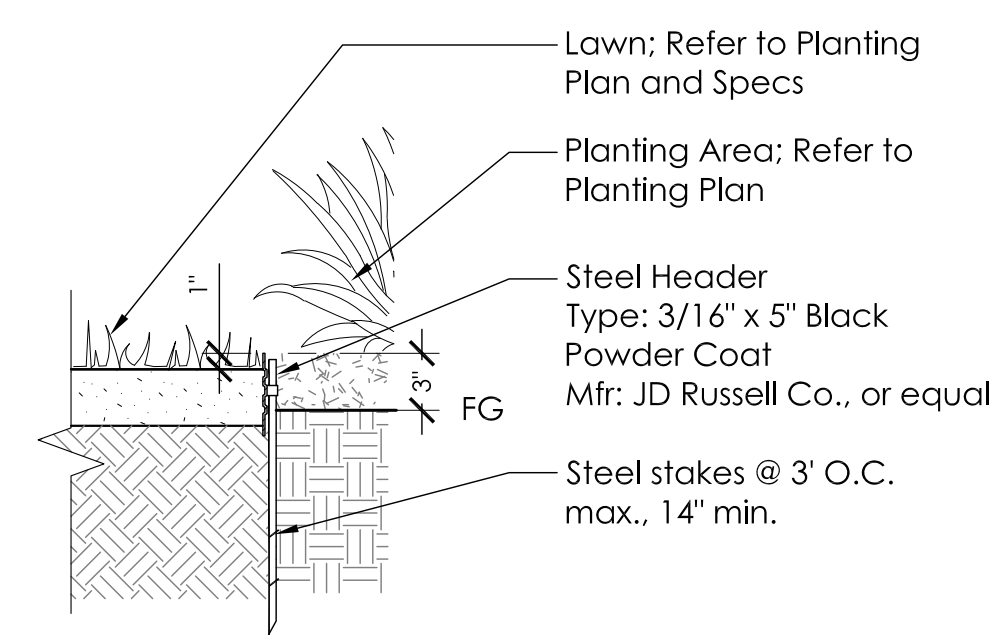

NOTES:


1. Compact grades adjacent to edging to avoid settling.
2. Corners - Cut base of edging up half way and form a continuous corner.
3. Stake on inside of planting area when adjacent to lawn area.

1 METAL HEADER

NOT TO SCALE

P-RE-VII-0.5

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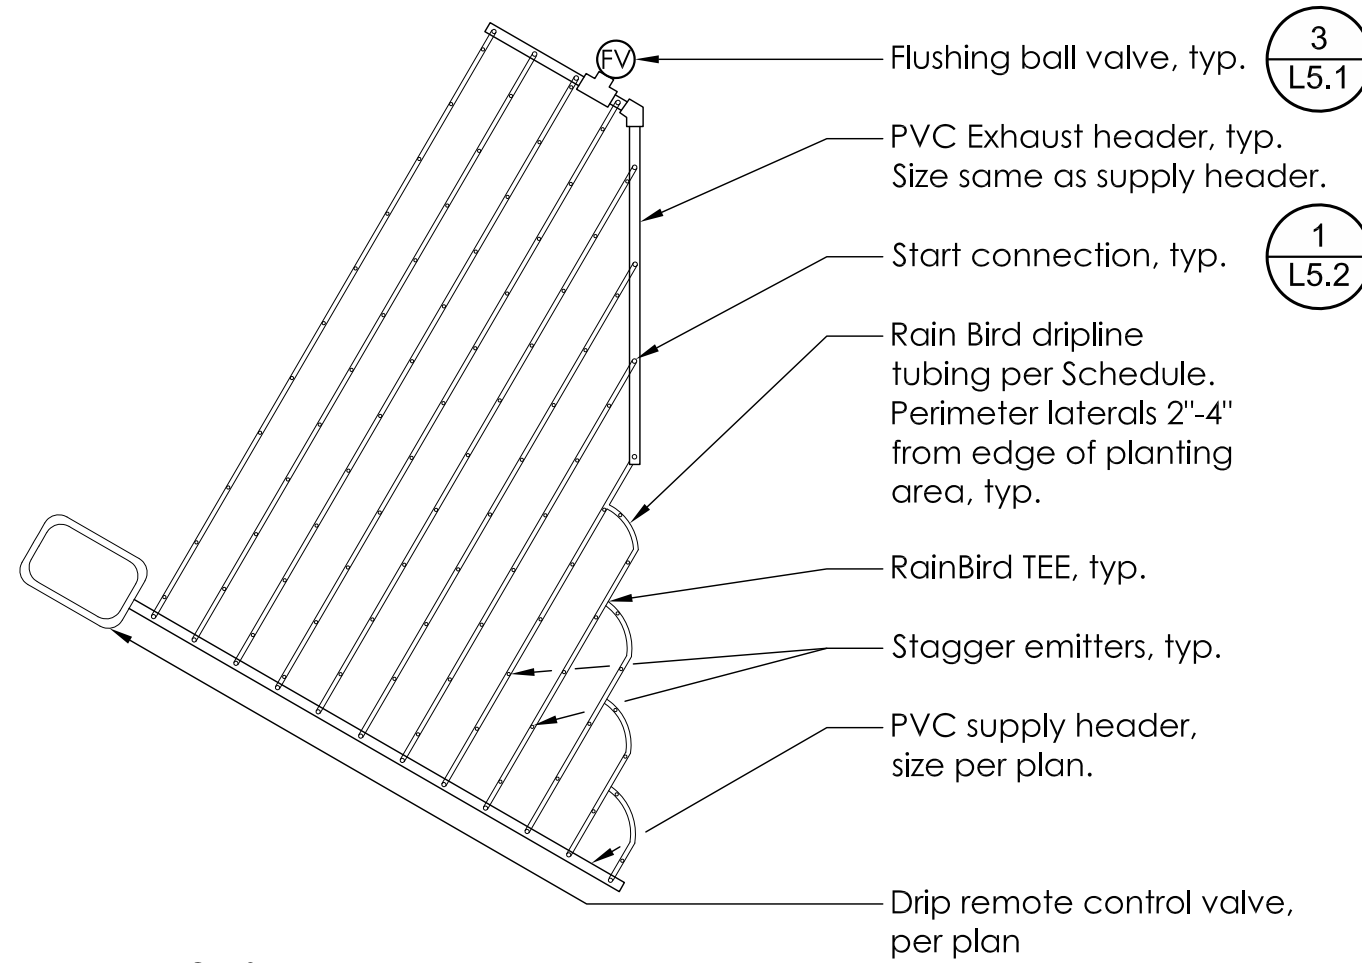
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	Permit Set	3/29/2019
	Permit Set Rev	1/21/2020
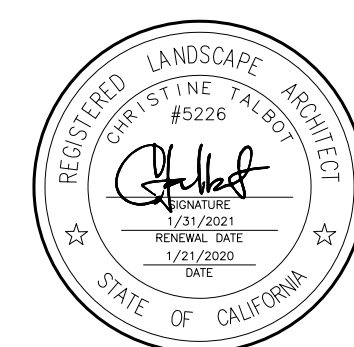
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SITE DETAILS

Date: 01/21/2020
Project Number: 18-1643


L5.0



- NOTES:
1. Affix all lines to ground using soil staples every 3' from drip valve.
 2. Rain Bird XFS emitters are pressure compensating and have check valves.
 3. See Irrigation Schedule for emitter and row spacing.
 4. Install check valves on supply and exhaust headers where elevation meets/exceeds 4-1/2' & as needed to prevent low-head drainage.

4 LAYOUT FOR IRREGULAR AREAS - TRIANGULAR


NOT TO SCALE P-RE-VIL-41

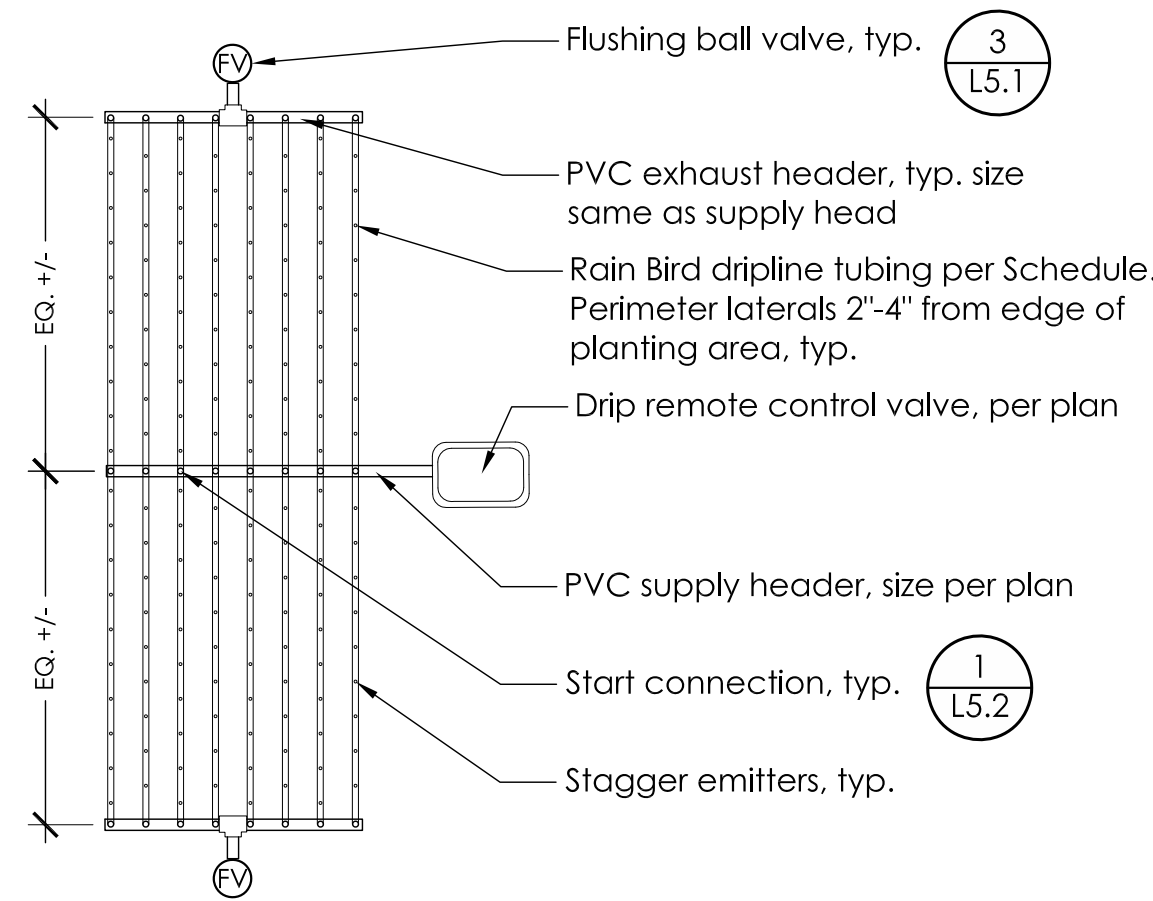


- NOTES:
1. Affix all lines to ground using soil staples every 3' from drip valve.
 2. Rain Bird XFS emitters are pressure compensating and have check valves.
 3. See Irrigation Schedule for emitter and row spacing.
 4. Install check valves on supply and exhaust headers where elevation meets/exceeds 4-1/2' & as needed to prevent low-head drainage.

3 DRIPLINE LINEAR LAYOUT

NOT TO SCALE P-RE-VIL-43

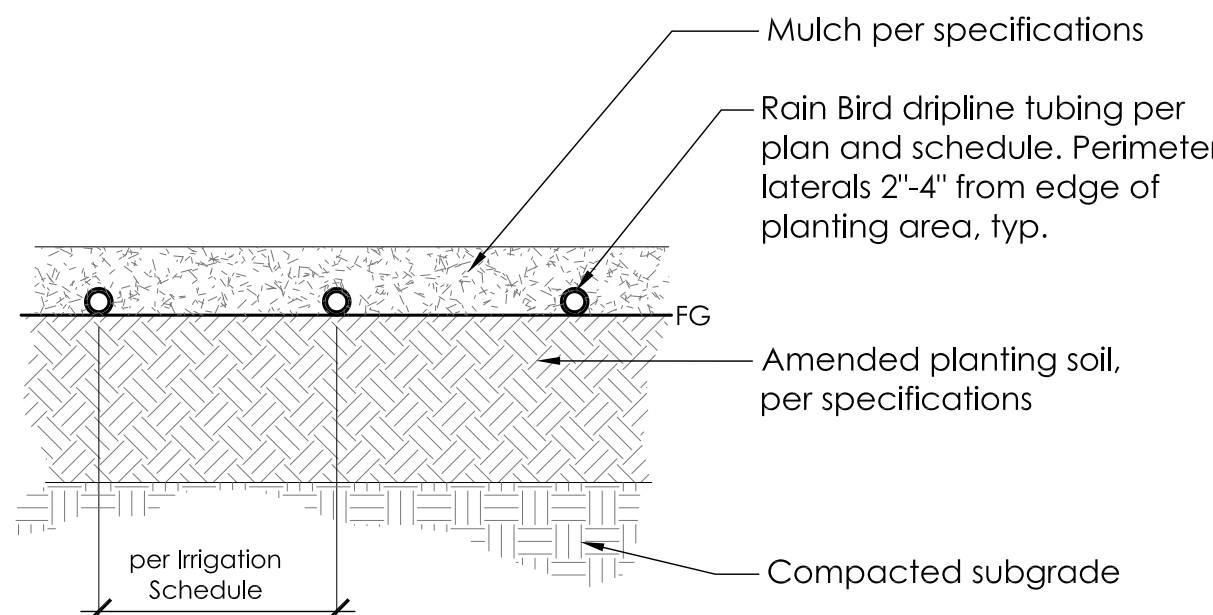


- NOTE:
- Install dripline tubing at finish grade, staple in place, per layout detail, then cover with mulch layer per planting details and specifications.

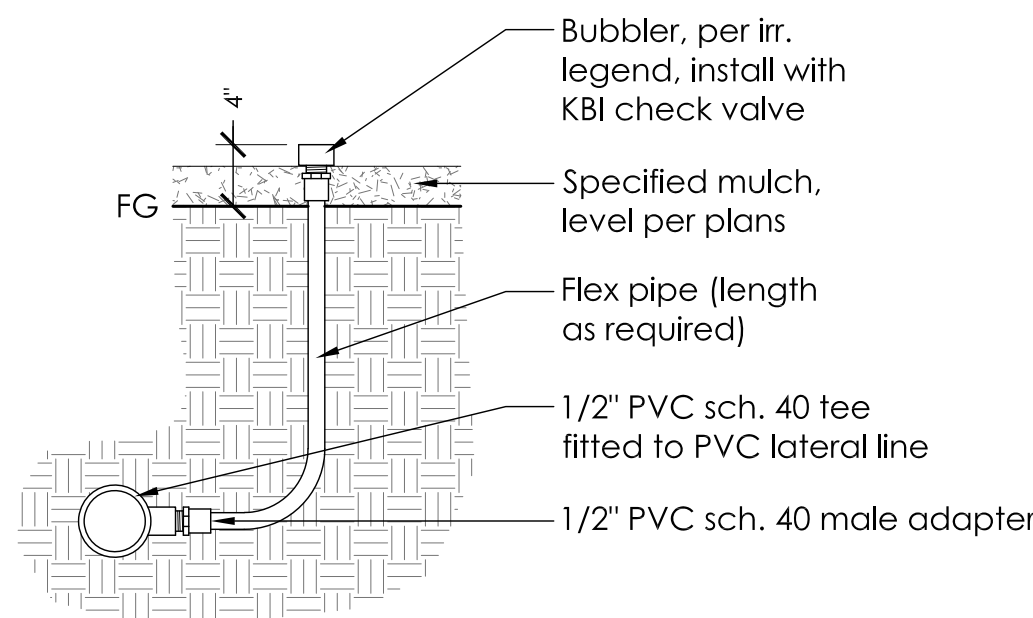

7 FLOOD BUBBLER


NOT TO SCALE P-RE-VIL-38

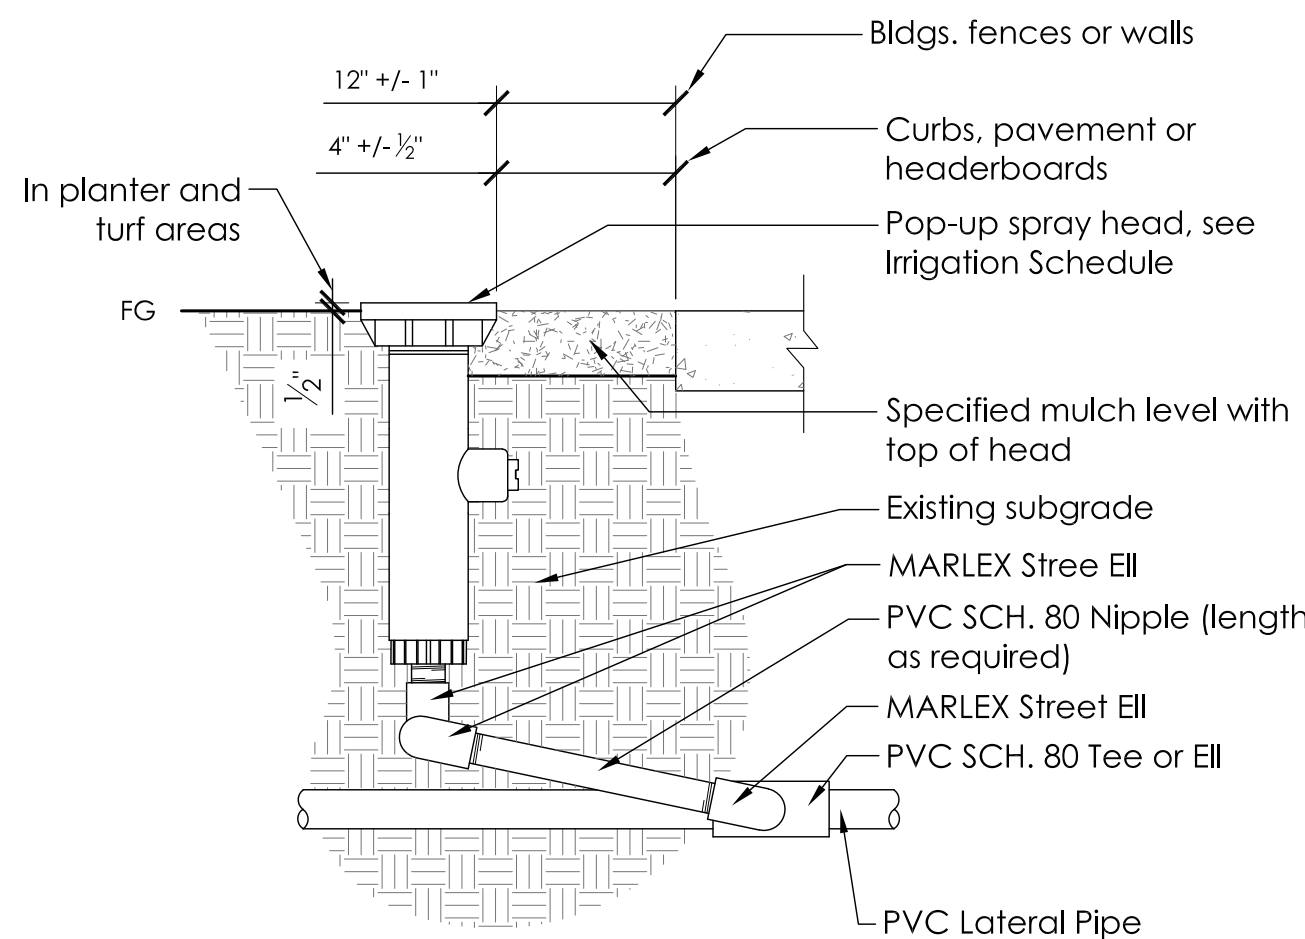

- NOTES:
1. All pvc threads shall have teflon tape, except at ell to ell or ell to tee connections.
 2. Install sprinkler heads 3" minimum from all walks, curbs and headers, or 24" minimum from non-permeable surfaces indicated on irrigation plans.

6 POP-UP SPRAY HEAD


NOT TO SCALE P-RE-VIL-36

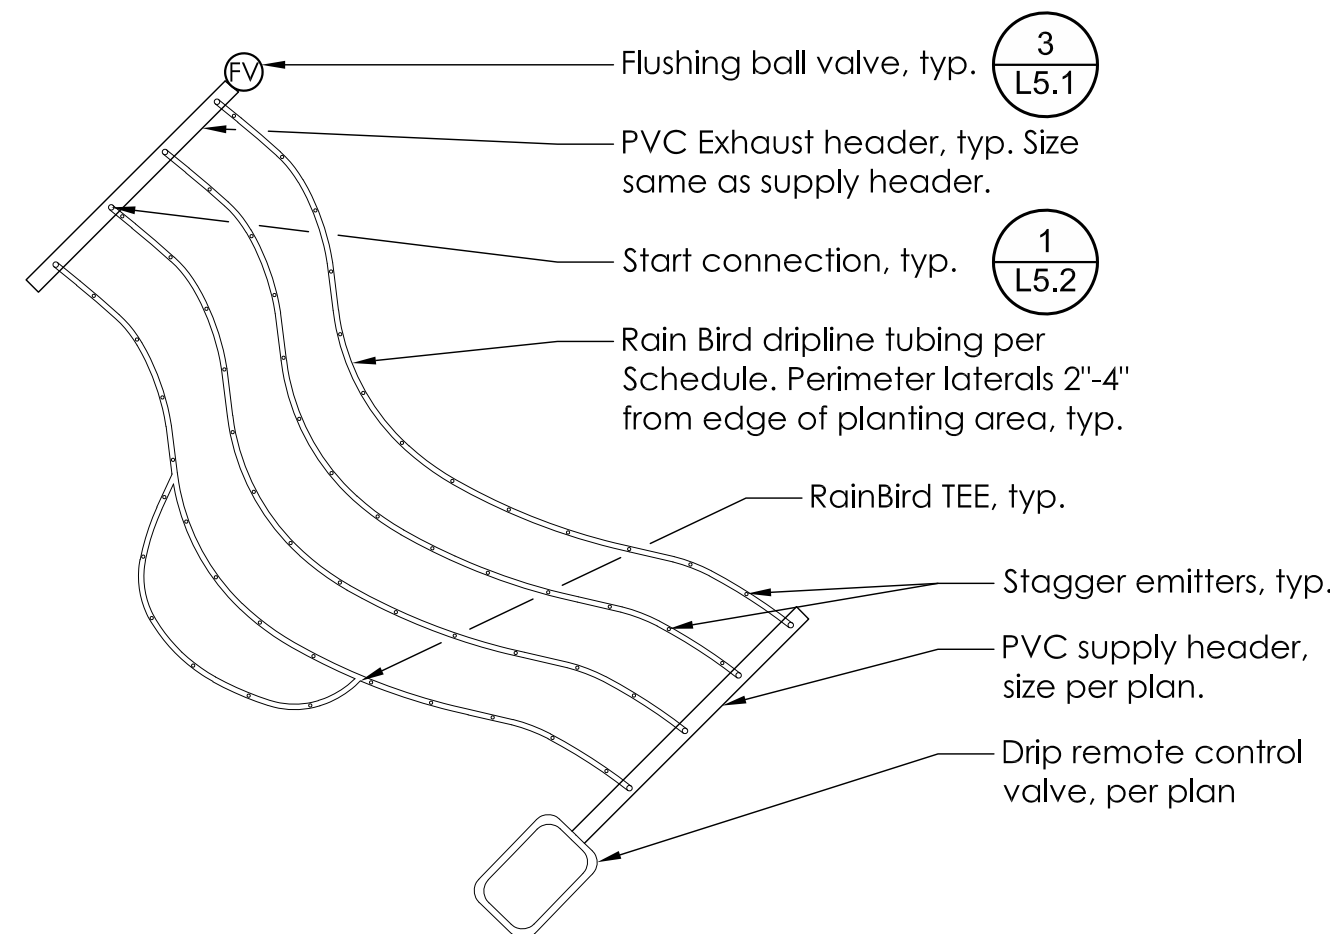

- NOTES:
1. Affix all lines to ground using soil staples every 3' from drip valve.
 2. Rain Bird XFS emitters are pressure compensating and have check valves.
 3. See Irrigation Schedule for emitter and row spacing.
 4. Install check valves on supply and exhaust headers where elevation meets/exceeds 4-1/2' & as needed to prevent low-head drainage.

5 DRIPLINE LAYOUT FOR IRREGULAR AREAS - CURVES


NOT TO SCALE P-RE-VIL-39

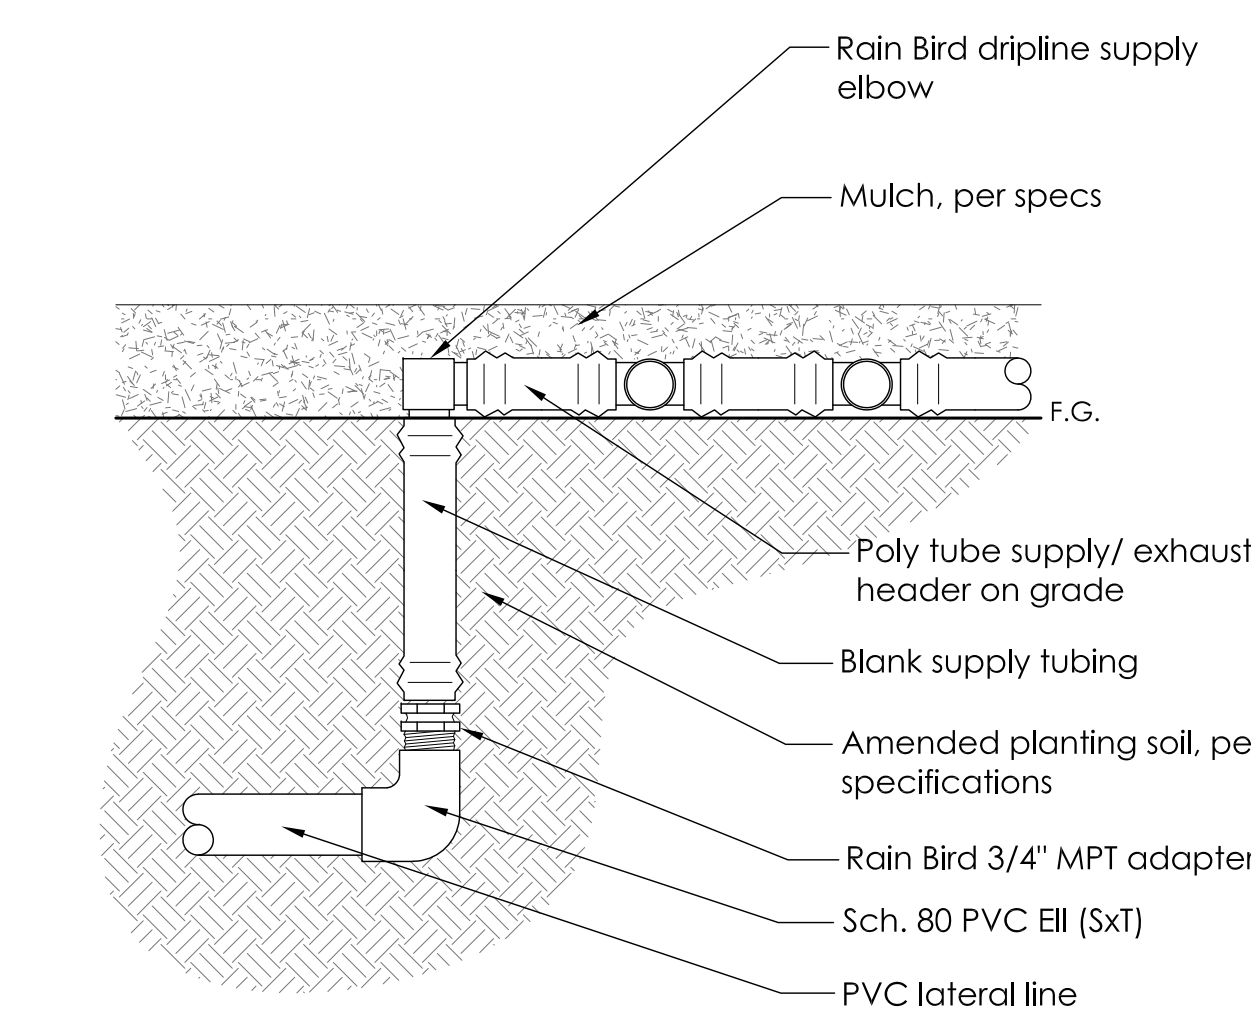

1 DRIPLINE START CONNECTION ON GRADE

NOT TO SCALE P-RE-VIL-44

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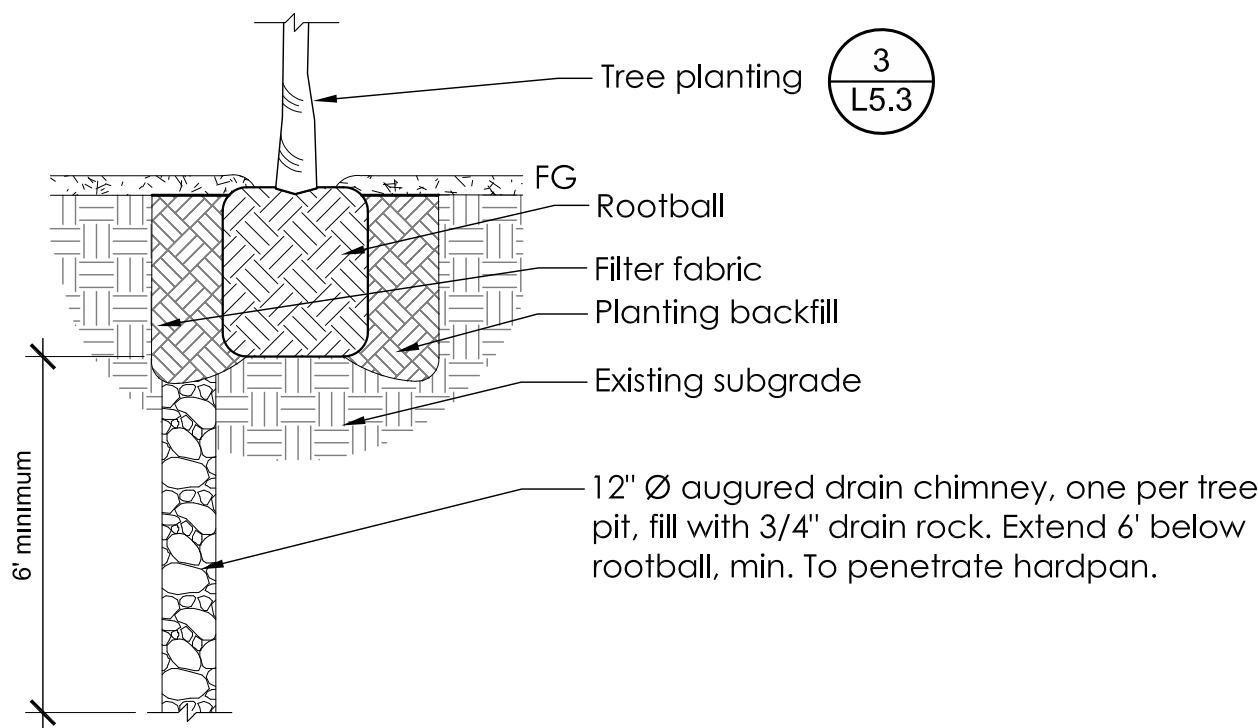
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No.	Description	Date
Permit Set		3/29/2019
Permit Set Rev		1/21/2020

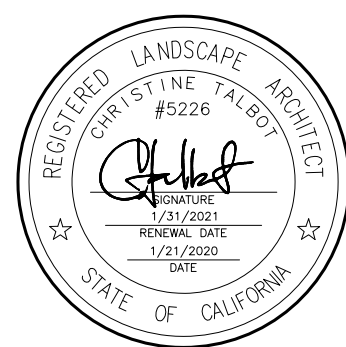Key Plan/Consultant Stamp

IRRIGATION DETAILS

Date: 01/21/2020
Project Number: 18-1643




- Notes:
1. Drainage required only for tree pits failing tree pit drainage test as described in the specifications.
 2. Contractor to repeat tree pit drainage test after installation of drain chimney to ensure proper drainage.

4 TREE PIT DRAINAGE CHIMNEY

NOT TO SCALE


P-RE-VIL-17

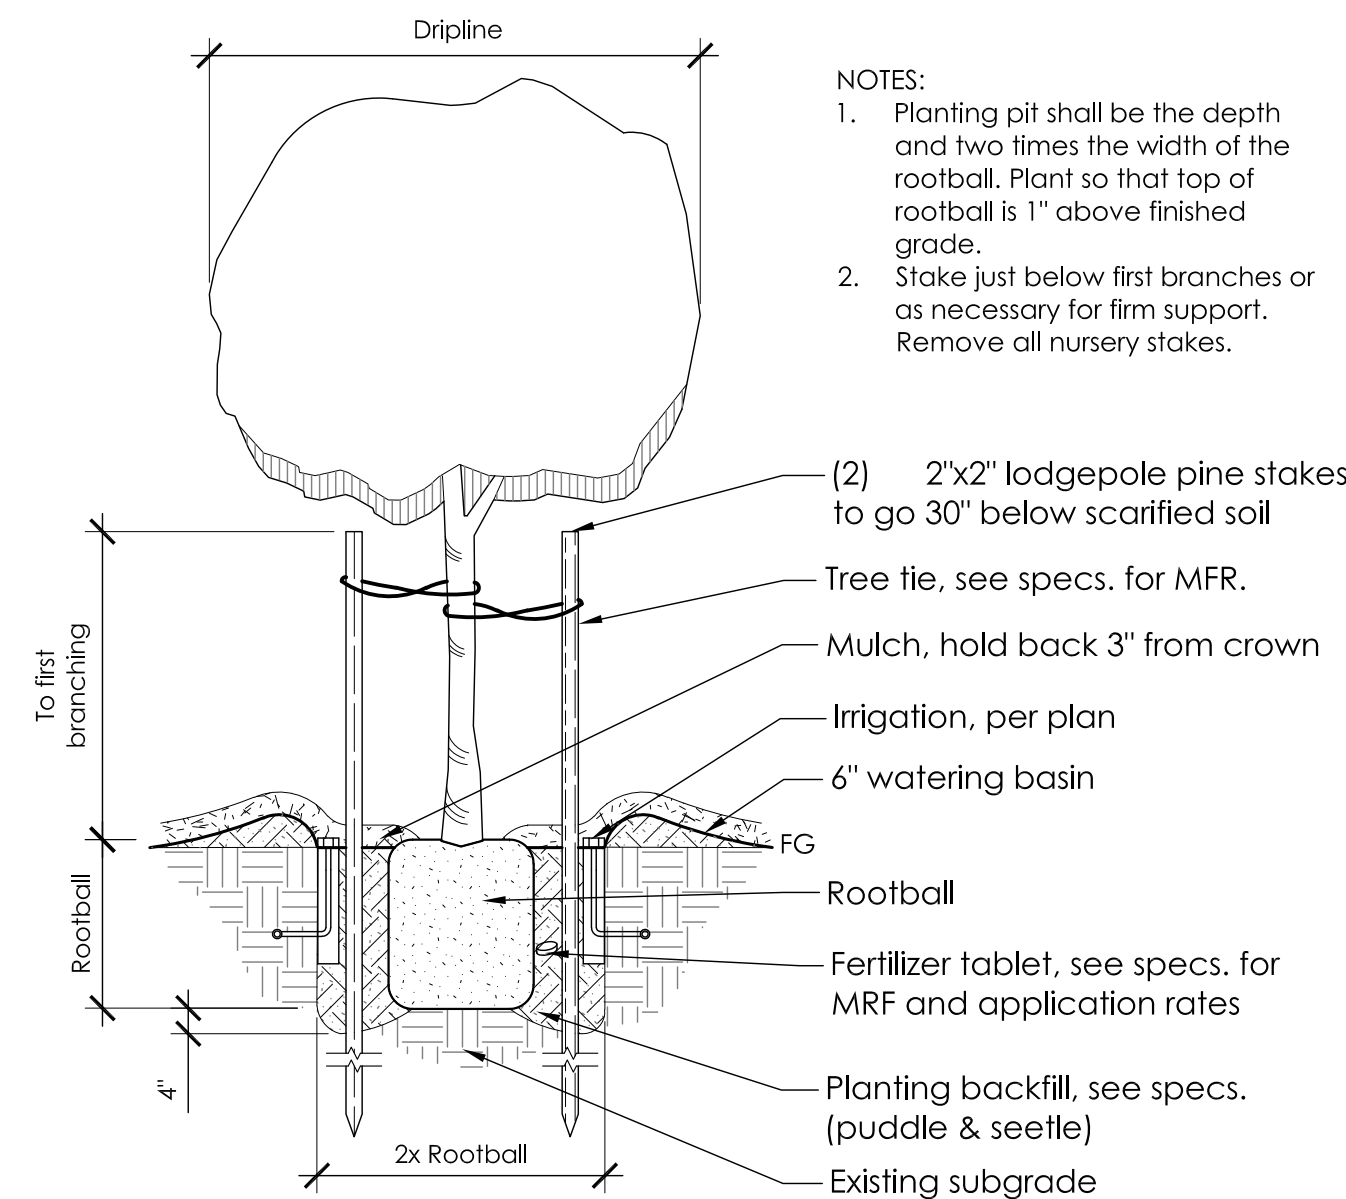

3 TREE PLANTING WITH IRRIGATION

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P-RE-VIL-15

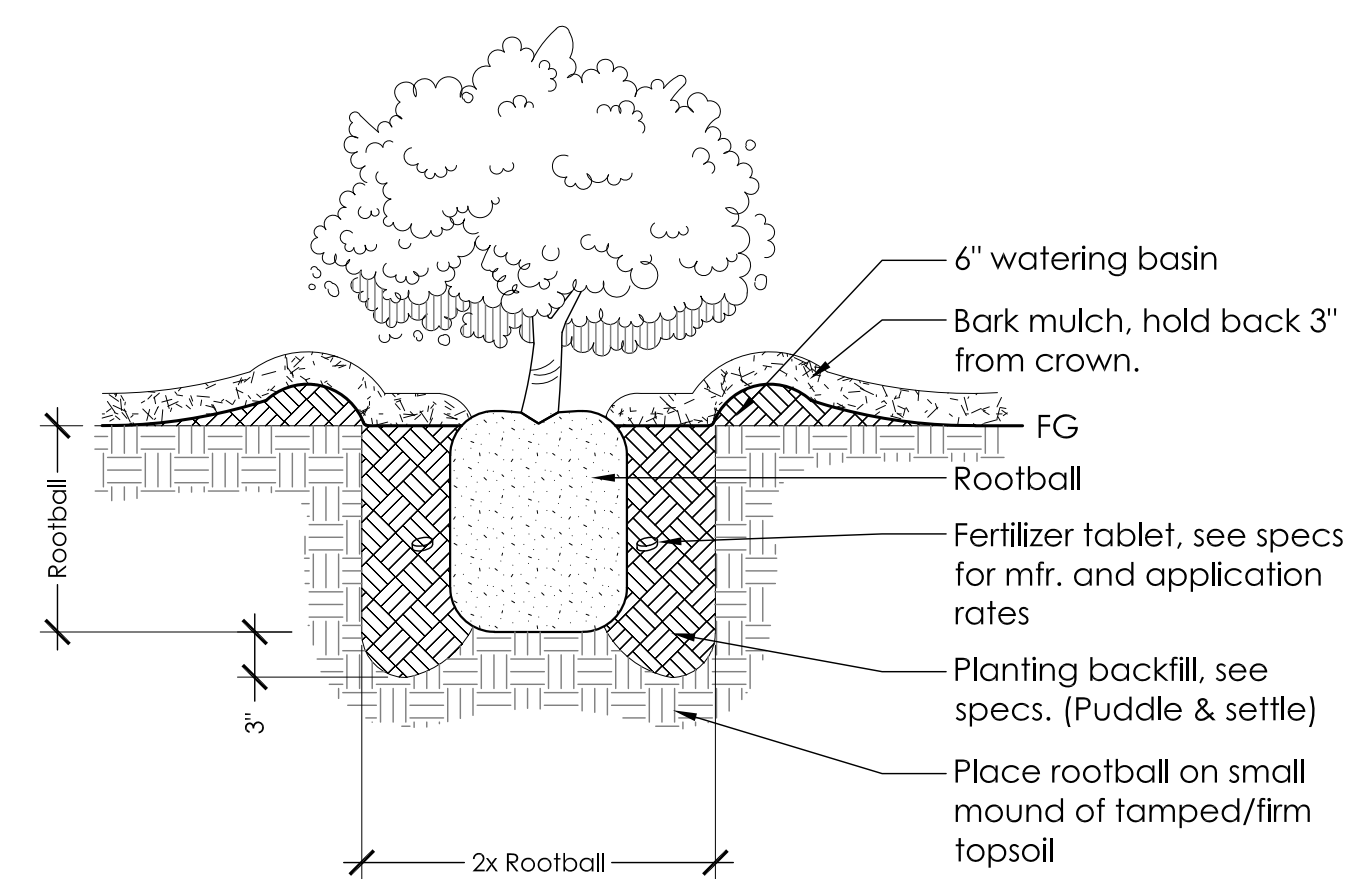


Note:
Planting pit shall be the depth and two times the width of the root ball. Plant so that top of rootball is 1" above finished grade. Remove all nursery stakes.

2 SHRUB PLANTING

NOT TO SCALE

P-RE-VIL-14

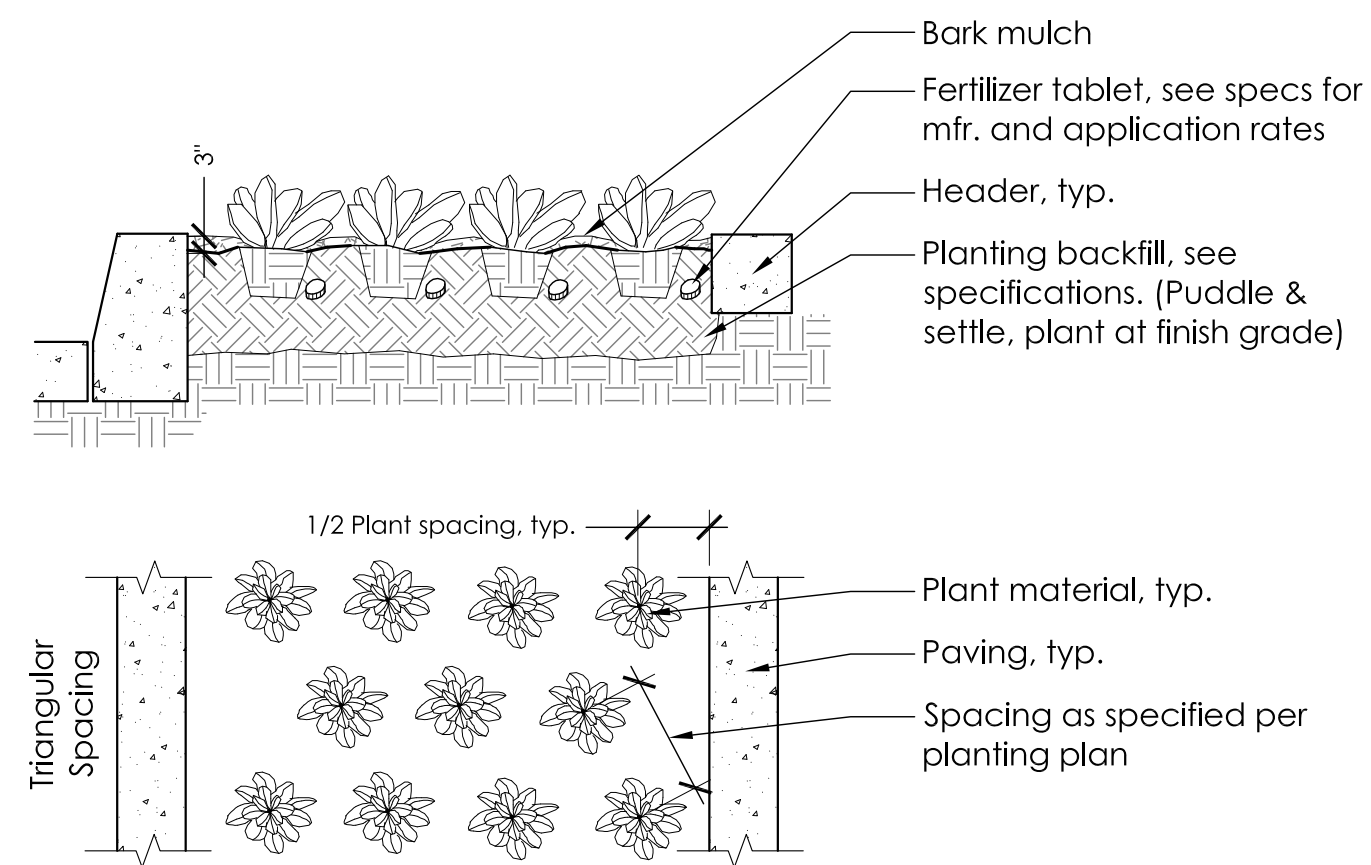


- Notes:
1. Rip or scarify top 12" of subgrade prior to planting.
 2. Add amendments and fertilizer per soils report and specifications.
 3. Rototill amendments and fertilizer into top 12" of topsoil or per soils report.
 4. Plant groundcover: triangular spacing (see plan).
 5. Add 3" of bark mulch.
 6. Landscape fabric per specifications.

1 GROUND COVER PLANTING AND PLANT SPACING

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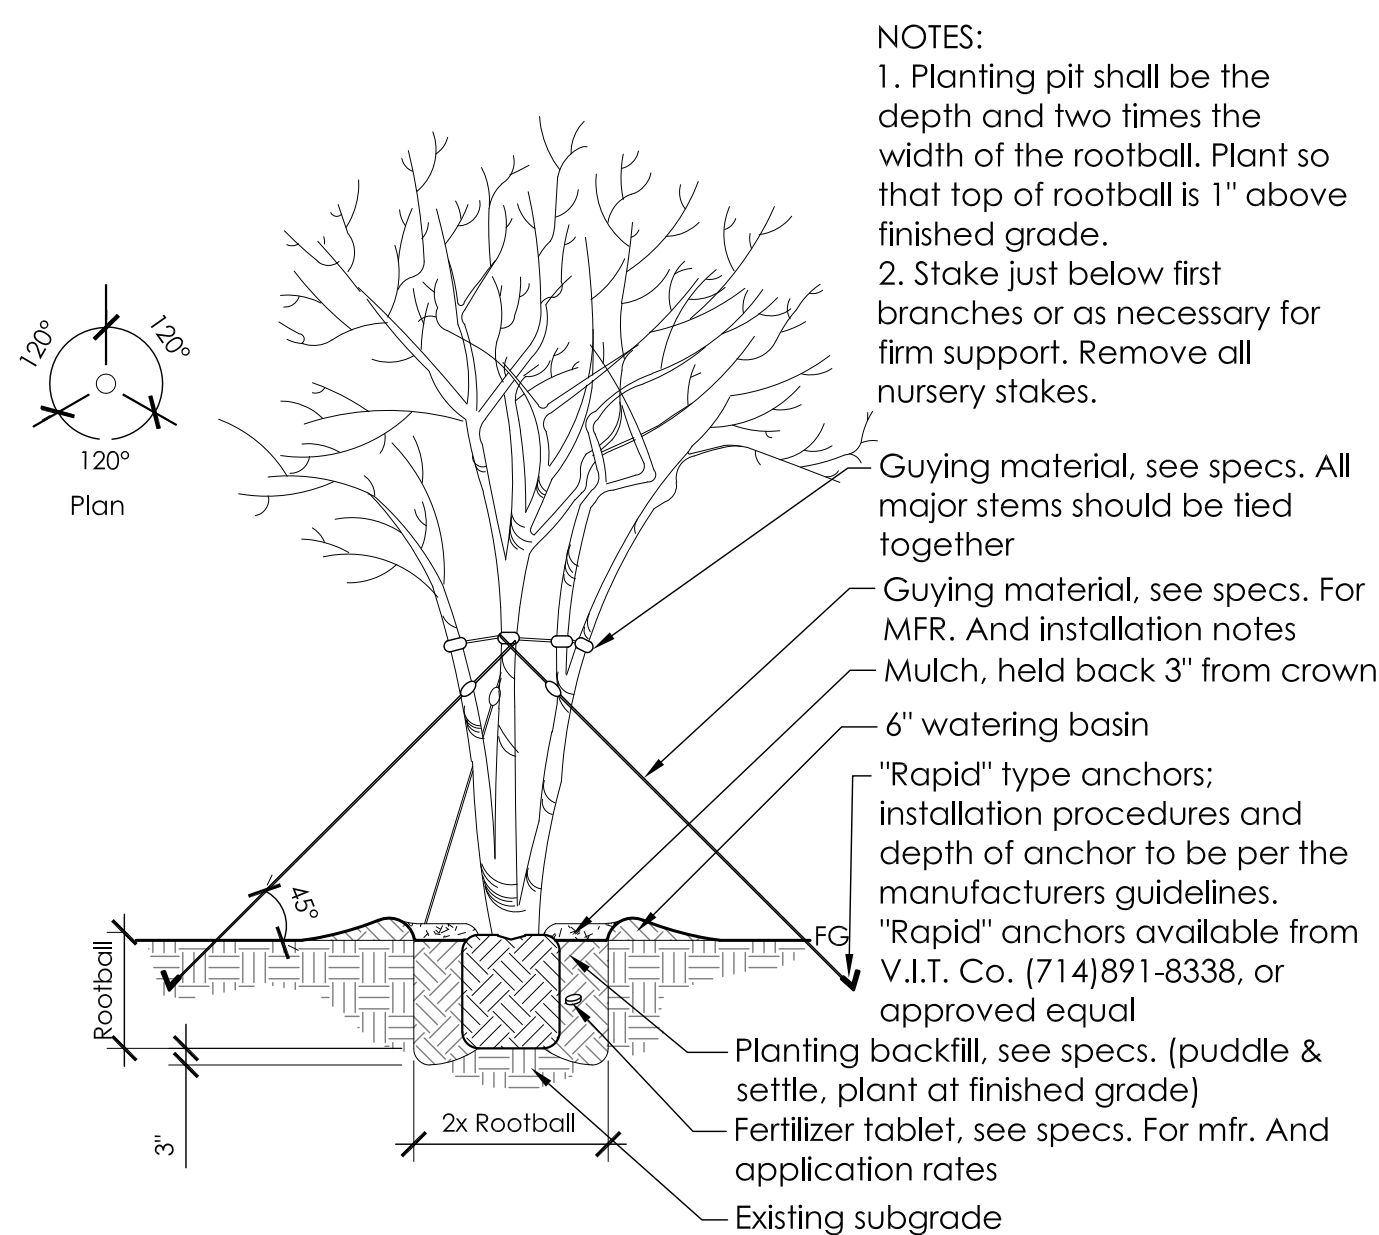
P-RE-VIL-13

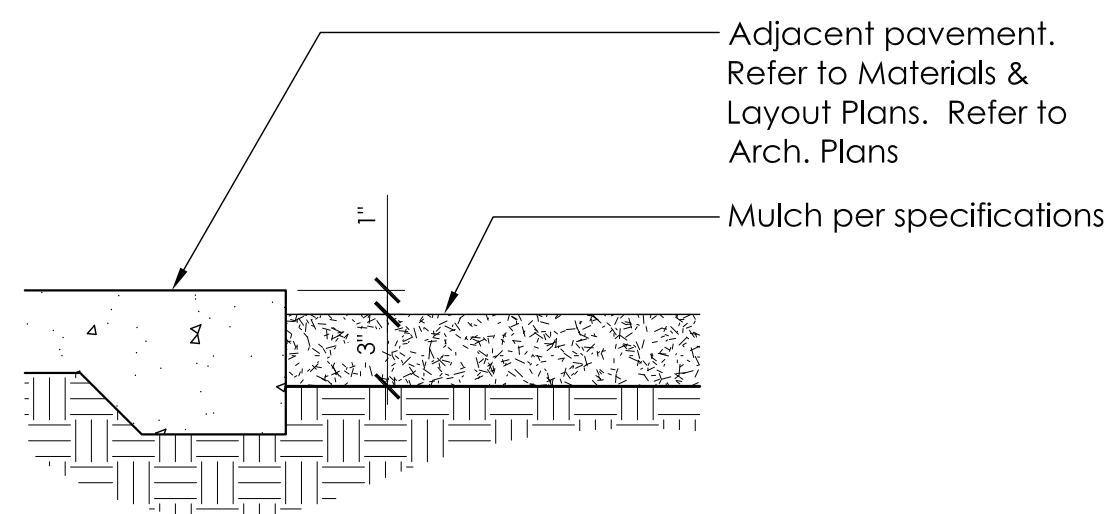

6 MULCH

N.T.S.

P-RE-VIL-45




5 MULTI-TRUNK TREE GUYING

NOT TO SCALE

P-RE-VIL-18

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PLANTING DETAILS

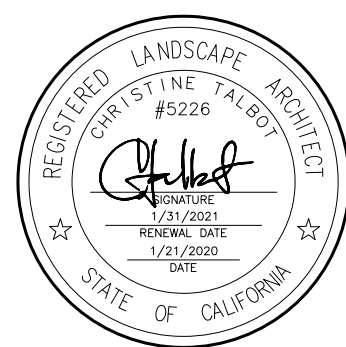Date: 01/21/2020
Project Number: 18-1643