

19820 Homestead Road, Cupertino, CA

A VIEW OF THE EXISTING BUILDING FROM HOMESTEAD ROAD

APPLICANT:	HOMESTEAD HOMES 19620 STEVENSCREEK BLVD STE 280, CA 95070
	CONTACT: ELLA SUN AND WILLIAM PAN WPAN@WPANRE.COM ELLASUN.HOUSE@GMAIL.COM
ARCHITECT:	JOSEPH BELLOMO ARCHITECTS 102 UNIVERSITY AVENUE PALO ALTO, CA 94301 (650) 326 0374
	PROJECT ARCHITECT: PRATIMA SHAH PRATIMA@BELLOMOARCHITECTS.COM
SURVEYOR:	SANDIS 1700 S. WINCHESTER BLVD, CAMPBELL, CA 95008
	CONTACT: STEVE YAZALINA SYAZ@SANDIS.NET

ARBORIST: DAVE DOCKTER

CONTACT: DAVEDOCKTER@COMCAST.NET

1700 S. WINCHESTER BLVD, CAMPBELL, CA 95008

CONTACT: STEVE YAZALINA SYAZ@SANDIS.NET

GEOTECHNICAL ROMIG ENGINEERS
ENGINEER: 1390 EL CAMINO REAL,
SAN CARLOS, CA 94070

CONTACT: PAYUM VOSSOUGHI PAYUM@ROMIGENGINEERS.COM

MECHANICAL, ELECTRICAL AND PLUMBING ENGINEERS:

INTEFACE ENGINEERING, INC 135 MAIN STREET, SUITE 400 SAN FRANCISCO, CA 94105

CONTACT: JOEL CRUZ JOELC@INTERFACEENG.COM

LANDSCAPE ARCHITECT:

CONTACT: ANYI HUANG ANYIHUANG@GMAIL.COM

ANYI LANDSCAPE STUDIO

PROPOSED LAND USE: LOW MEDIUM DENSITY (5-10 DU/Ac.) EXISTING LOT ZONING: PROPOSED ZONING PLANNED UNIT DEVELOPMENT AMENDMENT: RESIDENTIAL OCCUPANCY: LOT SIZE: 21,780 SQ FT

PROJECT DESCRIPTION: GENERAL PLAN AMENDMENT INITIATION

316-04-064

HOMESTEAD HOMES

LOW DENSITY (1-5DU/Ac.)

19820 HOMESTEAD ROAD, CUPERTINO, CA

FULLY SPRINKLERED FIRE SPRINKLER: ON SITE TRASH / RECYCLING:

PROPERTY ADDRESS:

EXISTING LAND USE:

OWNER:

A1	COVER SHEET
A2	VICINITY MAP
A3	PARCEL MAP
A4	LAND USE PLAN
A5	CITY OF SUNNYVALE GENENRAL PLAN
A6	ZONING MAP
A7	ZONING CODE COMPLIANCE
A8	SITE PLAN
A9	SECOND FLOOR PLAN
A10	ROOF PLAN
A11	AREA CALCULATIONS
A12	PROPOSED SUBDIVISION
A13	GRAPHIC REPRESENTATION OF
	CHANGE IN DENSITY


OOVED OUEET


A14	EAST AND WEST ELEVATIONS
A15	NORTH AND SOUTH ELEVATIONS
A16	ELEVATION FROM DRIVEWAY
A17	AERIAL VIEW
A18	STREET VIEW FROM HOMESTEAD ROAD
A19	CONTEXT PICTURES
C0	SITE SURVEY
C1	GRADING PLAN
L1	PRELIMINARY LANDSCAPE PLAN
L2	EXISTING TREE SURVEY
L3	PRELIMINARY PLANTING PLAN
L4	LANDSCAPE CONSTRUCTION DETAILS
L5	PLANT PICTURES



-	
Project Name: 19820 Homestead Road, Cupertino	COVER SHEET
	11/09/20 SCA
PRINTABLE TO S	

19820 Homestead Road

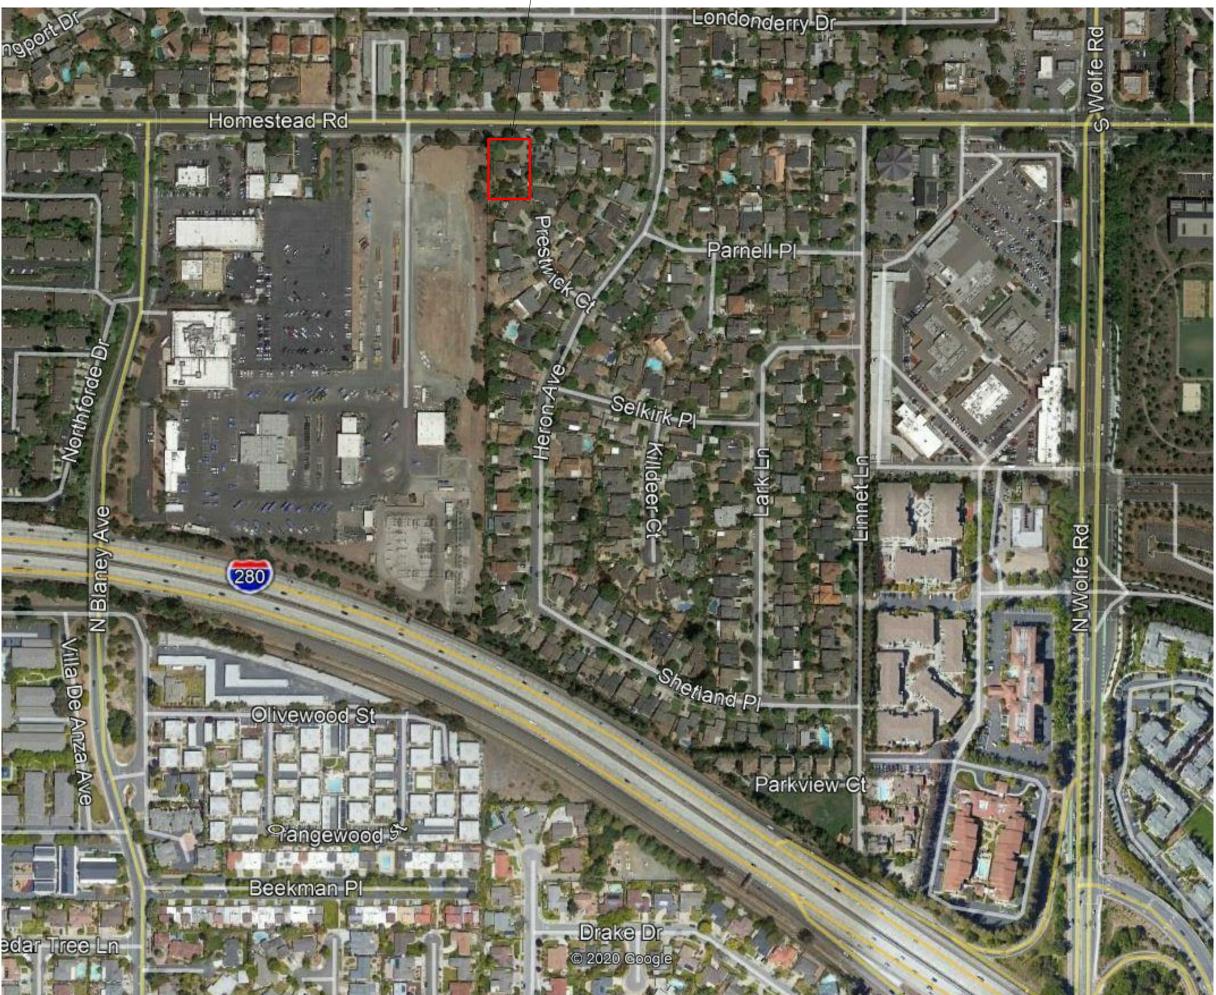

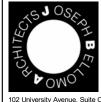

102 University Avenue, Suite (Palo Alto, CA 9430)

www.bellomoarchitects.co

COPYRIGHT

ALL DRAWINGS AND WRITTEN MATERAL.
APPEARING HEREN CONSTITUTE ORIGINAL
AND UNPUBLISHED WORK OF THE
ARCHITECT, AND THE SAME MAYNOT BE
DUPLICATED, USED OT ALTERED WITHOUTHE WRITTEN CONSENT OF THE

	ad, Cupertino	
t Name:	Homestead Roac	

DATE
11/09/2020

SCALE
ABLE TO SCALE FORMAT 12" X 18"

Project Number






PARCEL MAP

EXISTING GENERAL PLAN LAND USE: LOW DENSITY RESIDENTIAL (1-5 DU/Ac)
ADJOING PROPERTIES:
NORTH: HOMESTEAD ROAD

EAST: SINGLE FAMILY RESIDENCE IN CITY OF SUNNYVALE
(ZONE: RO, GENERAL PLAN DEIGNATION: LOW DENSITY RESIDENTIAL)

SOUTH:SINGLE FAMILY RESIDENCE CITY OF SUNNYVALE
(ZONE: RO, GENERAL PLAN DEIGNATION: LOW DENSITY RESIDENTIAL)

WEST: PG&E PROPERTY (QUASI PUBLIC/INSTITUTIONAL)

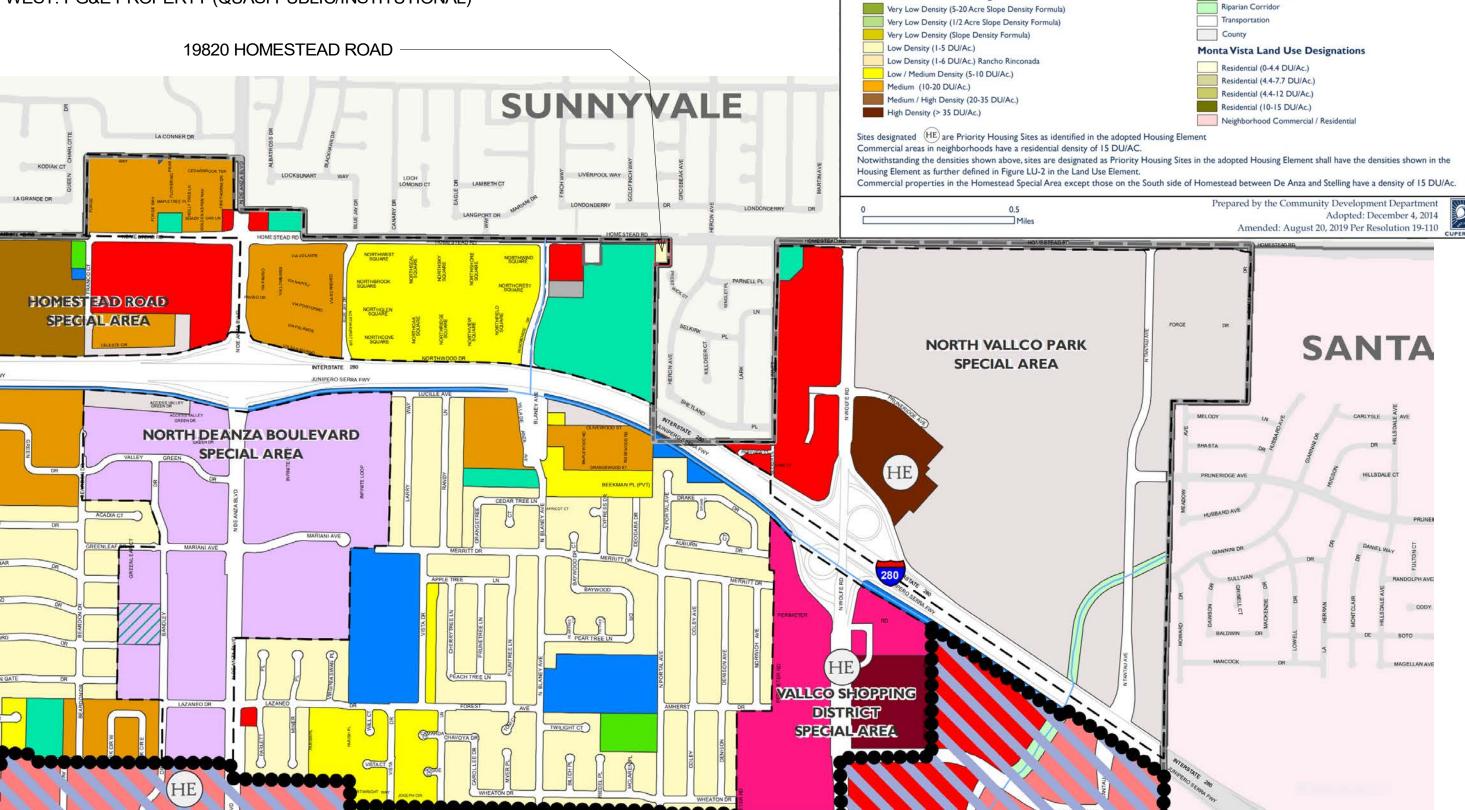



CITY OF CUPERTINO

LAND USE MAP

LEGEND

City Boundary

Urban Service Area

Sphere of Influence

- Creeks

(HE) Housing Element Sites

Residential Land Use Designations

Special Center Boundaries

Heart of the City

Non-Residential Land Use Designations

Regional Shopping

Regional Shopping / Residential

Commercial / Residential Office / Industrial / Commercial / Residentia

Industrial / Residential

Quasi-Public / Institutional

Quasi-Public / Institutional Overlay

Parks and Open Space

Public Facilities

Commercial / Office / Residential

Industrial / Residential / Commercia

Palo Alto, CA 94301 Tel 650.326.0374

www.bellomoarchitects.com

COPYRIGHT 20
ALL DRAWINGS AND WRITTEN MATERAL
APPEARING HEREN CONSTITUTE ORIGINAL
AND UNPUBLISHED WORK OF THE
ARCHITECT, AND THE SAME MAY NOT BE
DUPLICATED, USED OT ALTERED WITHOUT
THE WRITTEN CONSENT OF THE

Western voter of The Technology of The Technology of The Technology of The Technology of Technology

Project Name: 19820 Homestead Road, Cupertino

> DAT 11/09/202 SCAL RINTABLE TO SCALE FORMAT 12" X 1 Project Numbe





CITY OF SUNNYVALE GENERAL PLAN LIMERICK LIVERPOOL KIRKALDY FINCH GROSBEAK HERON FINCH GOLD LONDONDERRY LONDONDERRY LONDONDERRY RON LOW MEDIUM DENSITY I LOW MEDIUM DENSITY **HOMESTEAD** HOMESTEAD HERON 19820 Horizon 2035 GP Land Use **HOMESTEAD** Low Density Residential ROAD, **CUPERTINO** Low Medium Density Residential **LOW DENSITY** Mobile Home Park Medium Density Residential Noday. PARNELL PARNELL PRESTWICK High Density Residential KINGLE Very High Density Residential Transit Mixed Use Commercial Mixed Use Village Mixed Use LARK Commercial Industrial Office SELKIRK **Public Facilities** Baylands sri, HERE, Garmin, Intermap, increment P Corp., GEBCO, USGS FAO, NPS, NRCAN, GeoBase, IGN, Specific Plan Area ance Survey, Esri Japan, MEIII, Esri China (Hong Kong), (c) OpenStreetMap contributors, and the GIS User Community



Project Name: 19820 Homestead Road, Cupertino				ARCHITECT
CITY OF SUNNYVALE GENENRAL PLAN				o

DATE
11/09/2020
SCALE
PRINTABLE TO SCALE FORMAT 12" X 18'
Project Number

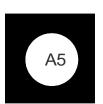

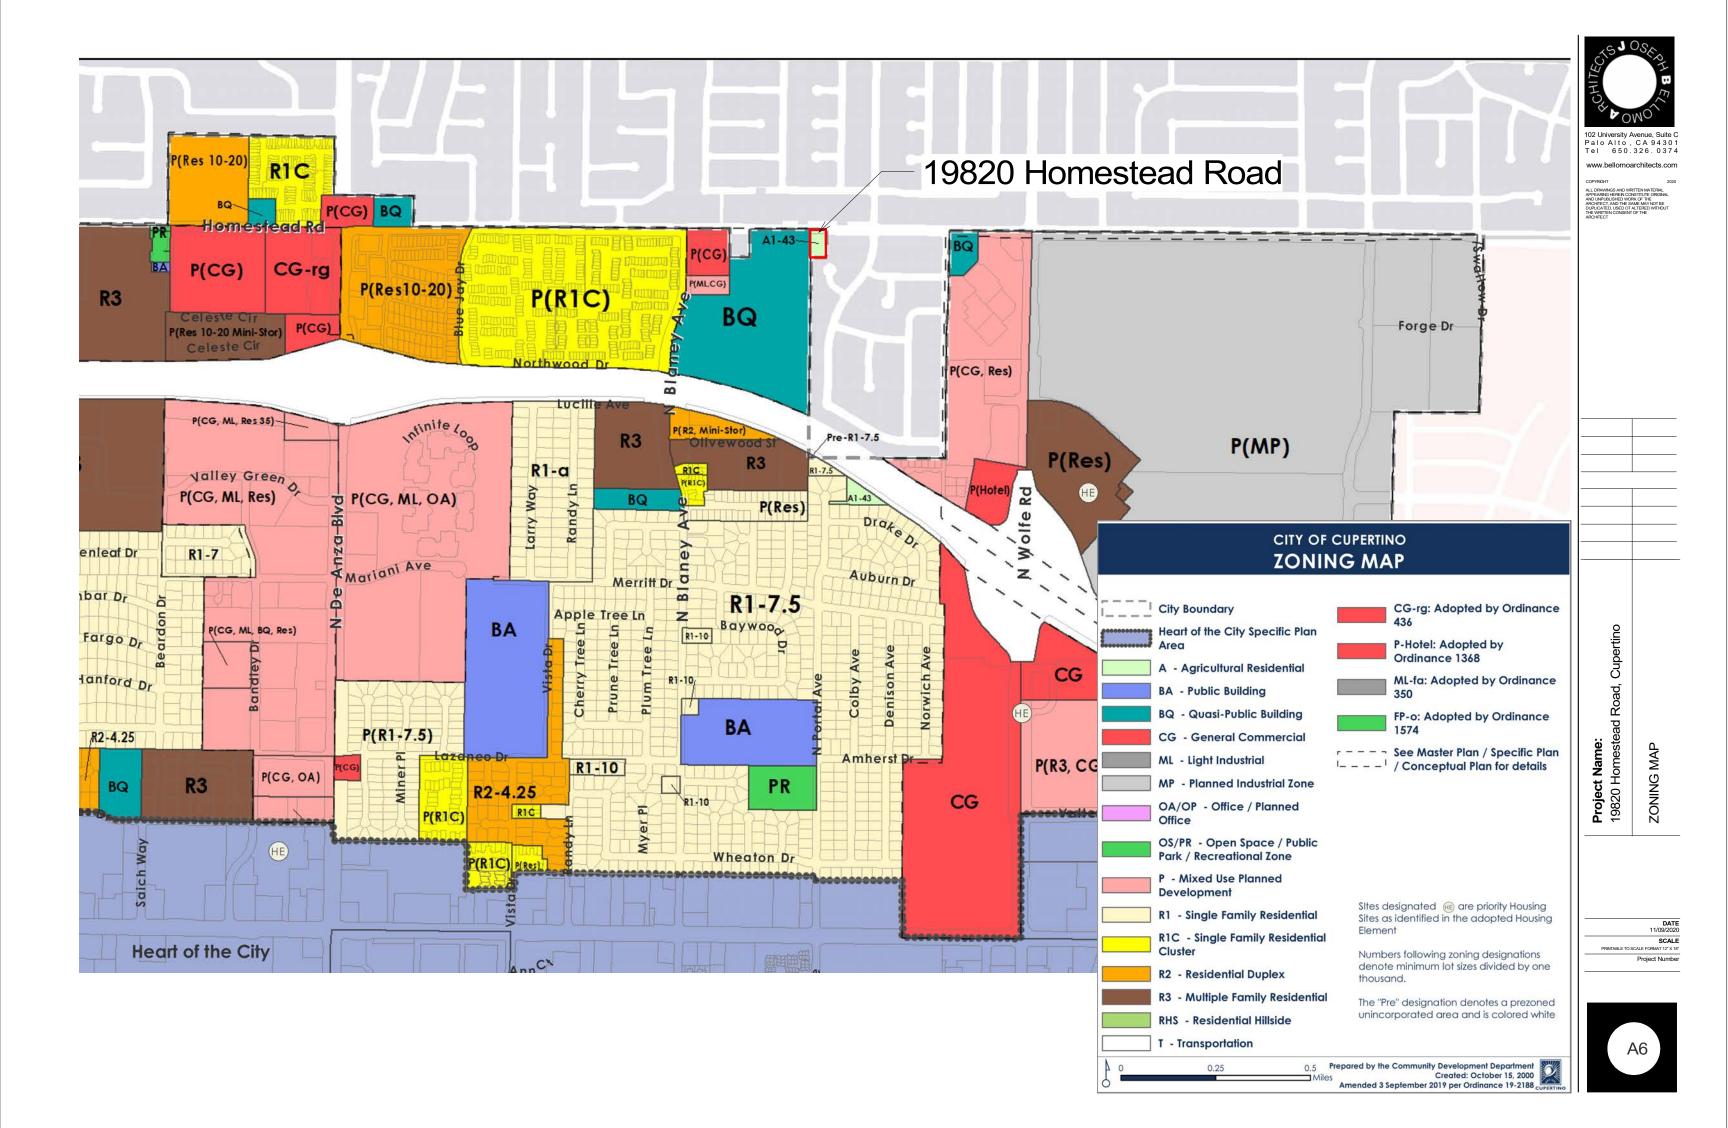

GENERAL PLAN AMENDMENT:

EXISTING LAND USE DESIGNATION: LOW DENSITY RESIDENTIAL (1-5 DU/Ac)

ONE RESIDENTIAL UNIT ON 19095 SQ FT

RESIDENTIAL DENSITY IS: 2.28 DU/Ac

PROPOSED LAND USE DEISGNATION: LOW MEDIUM DENSITY (5-10 DU/Ac)

FOUR RESIDENTIAL UNITS ON 19095 SQ FT

RESIDENTIAL DENSITY IS: 9.12 DU/Ac

Project: 19820 Homestead Road, Cupertino, CA

Cupertino Municipal Code Analysis

Site Information:

Area of the Property: 21,780 sq ft

Current Assigned Zoning: Agriculture A1-43

Proposed Zoning: Planned Development Units

Project Program: 4 Residential Units with 2 ADUs in a Planned Development

Zoning Code Requirements: As per Multifamily Residential: R3

Area of the property without easement for future road: 19,095 sq ft

Site Development Regulation:

A. Density – Maximum number of units cannot exceed that allowed by the General Plan

Existing Density: Low Density (1-5 DU /Ac)

Proposed Density: Low Medium Density (5-10 DU/Ac)

	Required	Proposed: 4 Residential Units
Number of Units	Dwelling net lot area	
Upto 3 Units	9300	
Over 3	2000 additional square feet per dwelling unit	4 Units on 21,780 sq ft.
	Reuired Area for 4 Units: 11,300	
Lot Width	70 feet at front building setback line	115 feet

Building Development Regulations

L			
A	. Maximum Lot Coverage	40% of net lot area	38%
E	. Maximum Height	Limited to two stories (not to exceed 30 feet)	Two Stories 24 ft 6inches

C. Setbacks				
	First Floor		Second Floor	
Front-yard Side-yard	Required : 20 feet	Proposed: 20 ft	Required : 20 ft	Proposed: 20 ft
i. Interior side ii. Street side	Required: 6 feet Required: 12 feet	•	Required :9 ft 12 feet	Proposed : 9 ft
3. Rear-yard	20 feet or 20% of the lot degreater. Main building may as 10 feet to rear lot line if a yard setback area of not lestimes the width of the lot.	oth, whichever is encroach as close a useable rear-	20 feet or 20% of the	lot depth, whichever is
D. Private Outdoor Space - Balconies may be provided to fulfill this standard.	Approximately 20% of each floor area	unit's gross first-	10% of each unit's gr	oss floor area





www.bellomoarchitects.cor


COPYRIGHT 2020
ALL DRAWINGS AND WRITTEN MATERIAL APPEARING HEREN CONSTITUTE ORIGINAL AND UNPUBLISHED WCRK OF THE ARCHITECT, AND THE SAME MAY NOT BE DUPLICATED, USED OT ALL TREM WITHOUT THE WRITTEN CONSENT OF THE

Project Name: 19820 Homestead Road, Cupertino	ZONING CODE COMPLIANCE
	DATE 11/09/2020



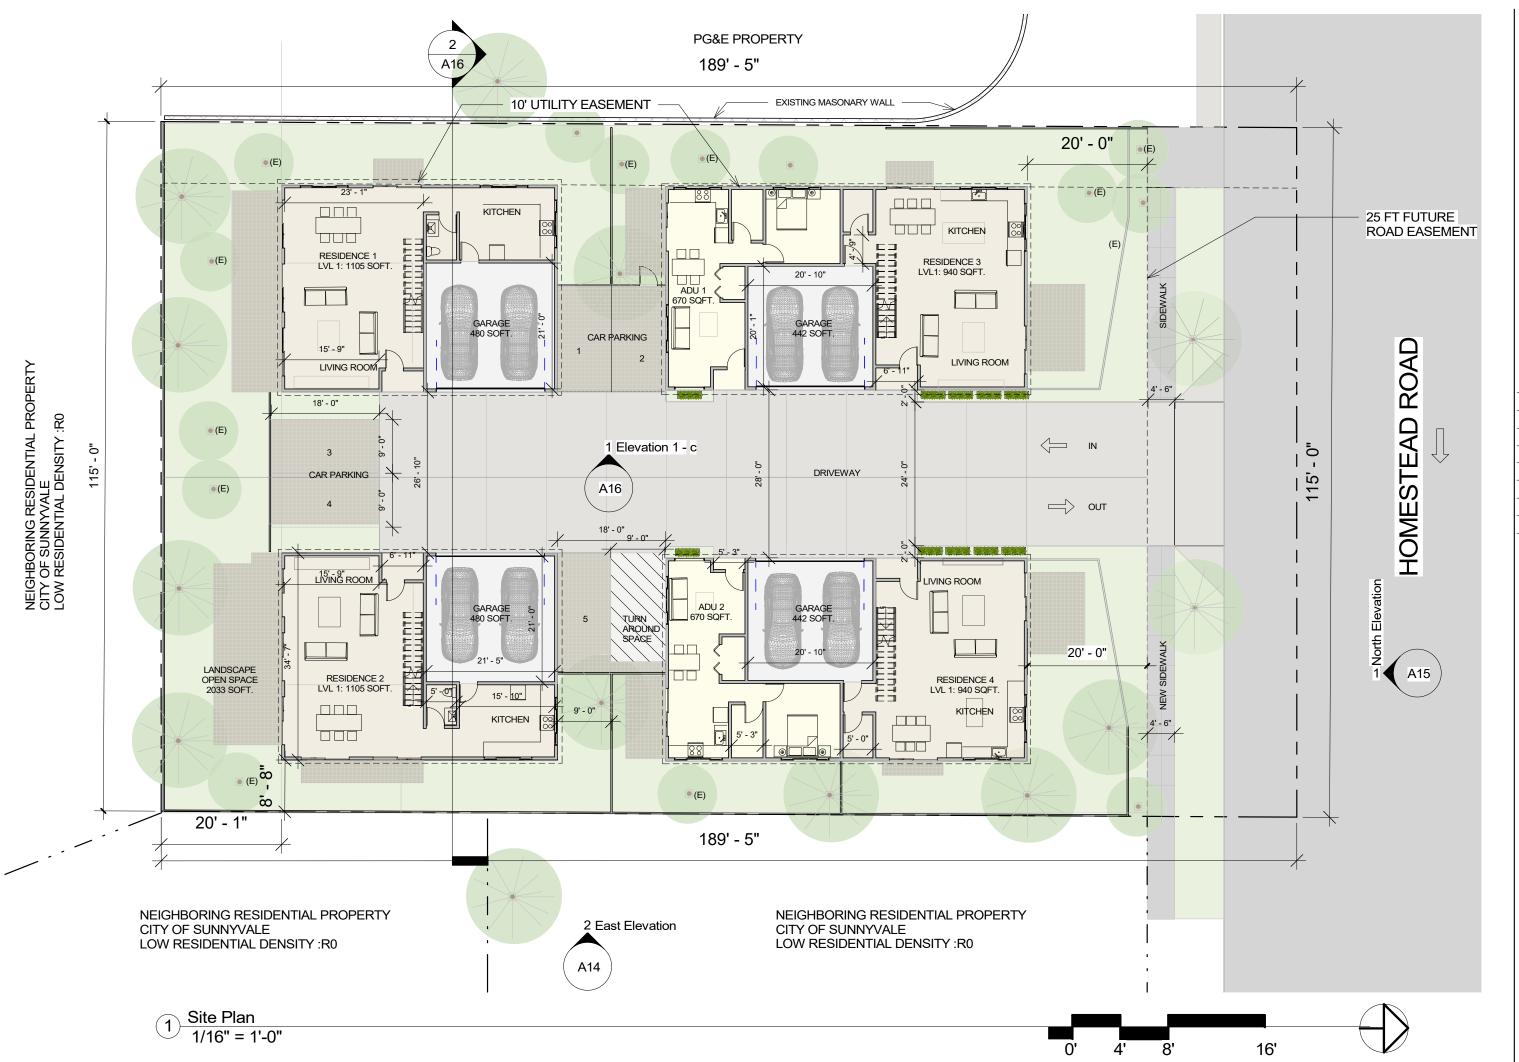

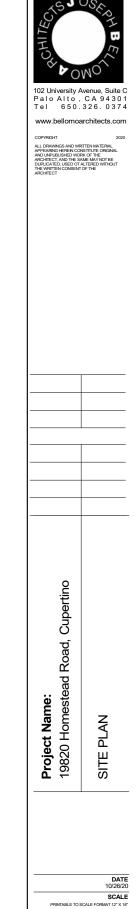

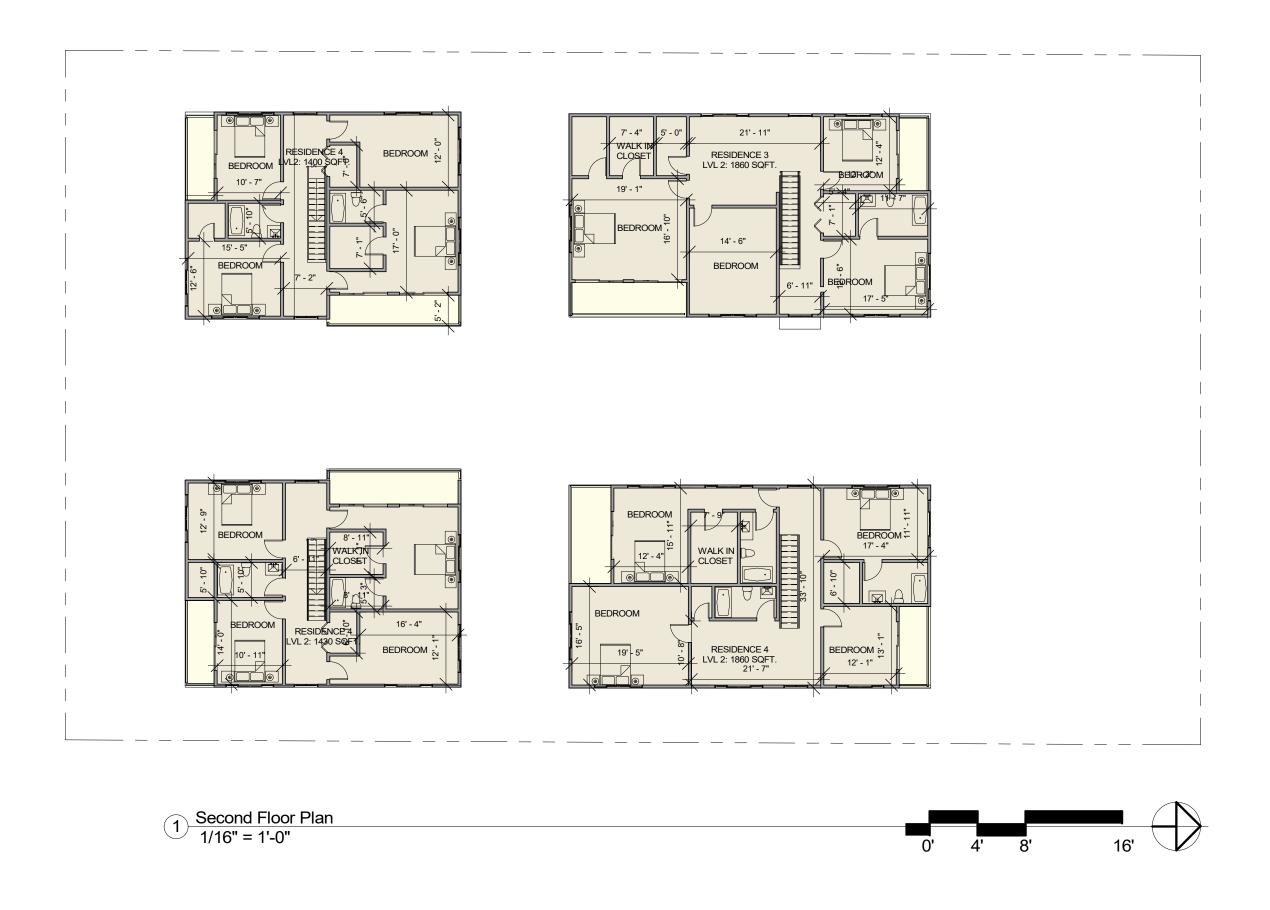



















Size of Individual Unit

Residence 1: 3015 SF

Residence 2: 3015 SF

Residence 3: 3242SF

ADU1: 670 SF

Residence 4: 3242 SF

ADU2: 670 SF

2 Second Floor Plan Area Calculation 1/32" = 1'-0"

0' 4' 8' 16'

19820 Homestead Road, Cupertino

Design Program 4 Residencial Units

DENTIAL UNIT 1 DENTIAL UNIT 2	1,430	1,430						
DENTIAL UNIT 2	1,430	1,430						
10000000000000000000000000000000000000								
SENITIAL LINUT S	1,430	1,430						
DENTIAL UNIT 3	1,860	1,860						
DENTIAL UNIT 4	1,860	1,860						
BLE OPEN SPACE	760			760				
AL 2ND FLOOR	7,340	6,580	0	760	0	0	0	0
DENTIAL UNIT 1	1,105	1,105						
DENTIAL UNIT 2	1,105	1,105						
DENTIAL UNIT 3	940	940						
1	670	670						
DENTIAL UNIT 4	940	940						
2	670	670						
STRIAN OVERLAY	2,685		2,685					
SCAPE OPEN SPACE	7,110				7,110			
ING IN GARAGES	1,844					1,844		
n PARKING	990						990	
E WAY	3,715							3,715
AL 1ST FLOOR	21,774	5,430	2,685	0	7,110	1,844	990	3,715
	20.444	42.040	2.00	762	7440	104	T 000 T	3,715
	LST FLOOR	21.774	LST FLOOR 21,774 5,430	LST FLOOR 21,774 5,430 2,685	LST FLOOR 21,774 5,430 2,685 0	LST FLOOR 21,774 5,430 2,685 0 7,110	LST FLOOR 21,774 5,430 2,685 0 7,110 1,844	LST FLOOR 21,774 5,430 2,685 0 7,110 1,844 990

DOILDING A	REA SUMMARY:				
SITE AREA			Site Cove	erage= Total	Area of the First Floor- Pedestrian
GROSS	21,775 SF		Overlay-	Landscaped	Open space-Parking-Driveway=
NET	19,095 SF		21780-26	585-7110-99	0-3715
F.A.R. RES	IDENTIAL		7,274	SF	38.00%
	12010 SF:19095 SF 0.62:1		55		
LANDSCAP	PED (USEABLE OPEN SPACE		OPEN SP	ACE PROVID	ED PER RESIDENTIAL UNIT
LANDSC.	7,110			RESIDE	NCE 1: 1920 SF
USEABLE	760	9573	1		
LANDSCAP	E / OPEN SPACE COVERAGE = I	ANDSCAPED			
OPEN SPAC	E + USEABLE OPEN SPACE + PE	DESTRIAN		RESIDE	NCE2: 1760 SF
/VEHICULAI			1		
	= 7,870			RESIDE	NCE 3:1222 SF
	41%		î	ADU	J 1: 525 SF
PEDESTRIA	AN/VEHICULAR OVERLAY		II	RESIDE	NCE 4:1200 SF
PED.	2,685		1	ADL	J 2: 456 SF



102 University Avenue, Suite C Palo Alto, CA 94301 Tel 650.326.0374

www.bellomoarchitects.c


COPYRIGHT 202

ALL DRAWINGS AND WRITTEN MATERIAL APPEARING HEREN CONSTITUTE ORIGINAL AND UNPUBLISHED WORK OF THE ARCHITECT, AND THE SAME MAY NOT BE DUPUCATED, USED OF ALTERED WITHOUT THE WRITTEN CONSENT OF THE


Project Name:
19820 Homestead Road, Cupertino
AREA CALCULATIONS

11/09/2
SCA
PRINTABLE TO SCALE FORMAT 12*
Project Num



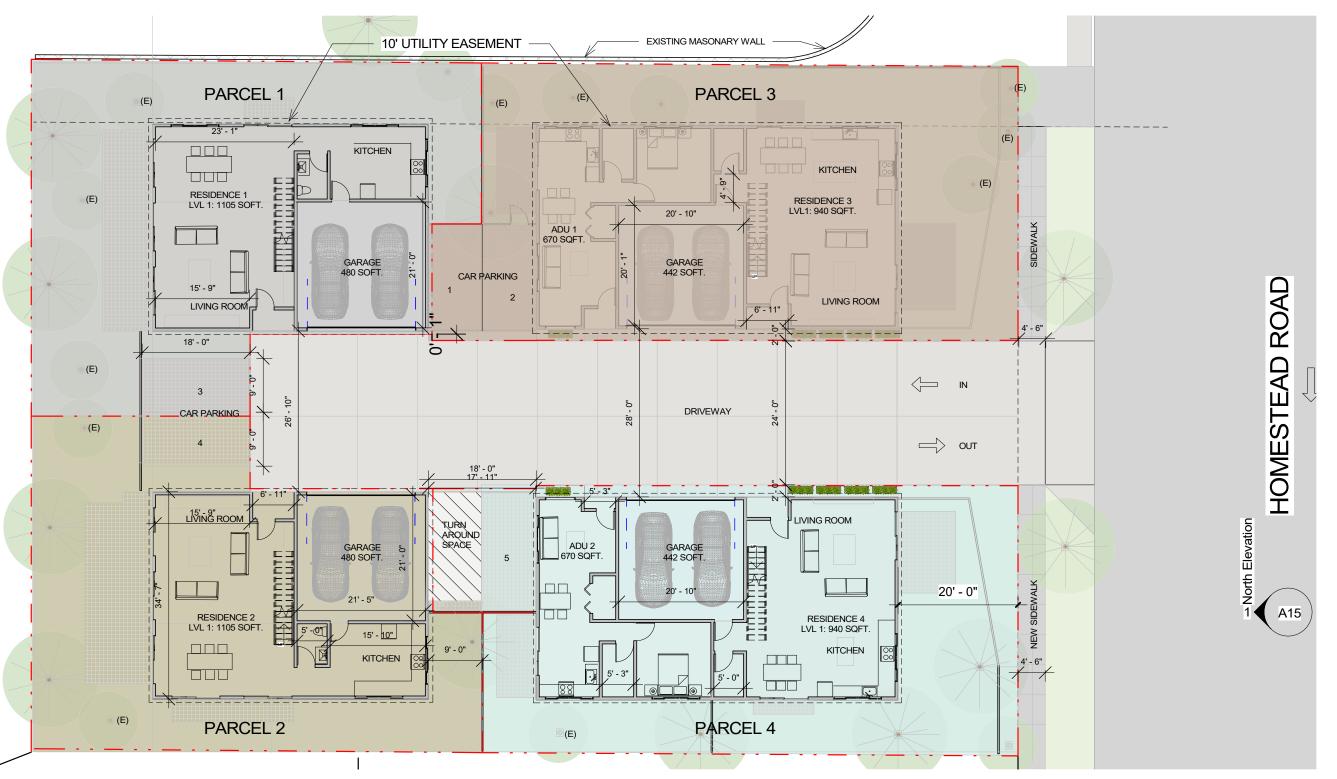

	PARCEL 1	PARCEL 2	PARCEL 3	PARCEL 4
AREA OF THE PARCEL	3750 SQFT	3523 SQFT	4290 SQFT	4010 SQFT
SITE COVERAGE	1585 SQFT= 42%	1585 SQFT=45%	2052 SQFT=48%	2052 SQFT= 51%
SQUARE FOOTAGE	2985 SQFT	2985 SQFT	3912 SQFT	3912 SQFT
FAR	1:0.76	1: 0.85	1:0.90	1:0.97
LANDSCAPED OPEN SPACE	1920 SQFT= 51%	1760 SQFT= 50%	1747 SQFT= 41%	1656 SQFT= 41%

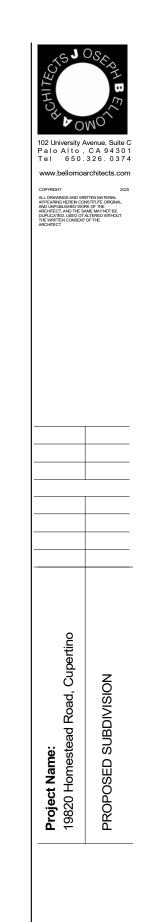


DAT 11/09/2 SCAL INTABLE TO SCALE FORMAT 12" X* Project Numb





EXISTING USE LOW RESIDENTIAL (1-5 DU/Ac)

PROPOSED USE :LOW MEDIUM RESIDENTIAL (5-10 DU/Ac)

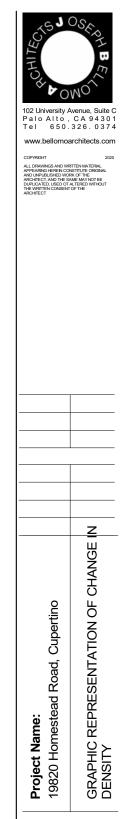







Roof Lvl 24' - 6" Second Floor Plan 10' - 0" 1 West Elevation 1/16" = 1'-0"

0'

4'

16'

8'

102 University Avenue, Suite C Palo Alto, CA 94301 Tel 650.326.0374 Project Name: 19820 Homestead Road, Cupertino EAST AND WEST ELEVATIONS



1 North Elevation 1/16" = 1'-0"



2 South Elevation 1/16" = 1'-0"







Project Name: 19820 Homestead NORTH AND SO	Project Name: 19820 Homestead Road, Cupertino NORTH AND SOUTH ELEVATIONS				l
--	--	--	--	--	---



1 Elevation 1 - c 1/16" = 1'-0"

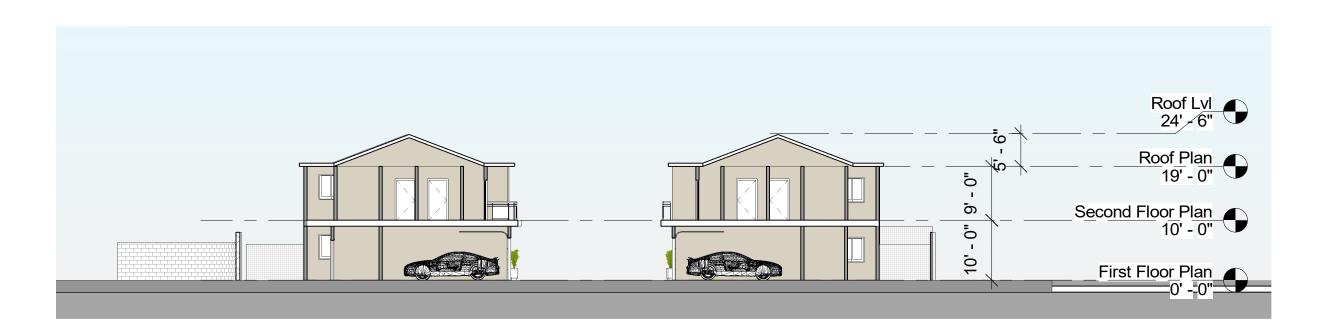

2 Section 1 1/16" = 1'-0"

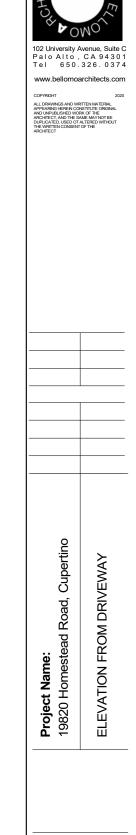





Aerial View



www.bellomoarchitects.c

COPYRIGHT

ALL DRAWINGS AND WRITTEN MATERIA
APPEARING HEREN CONSTITUTE ORIGI
AND UNPULSHED WORK OF THE
ARCHITECT, AND THE SAME MAY NOTE
DUPLICATED, USED OT ALTERED WITH
THE WRITTEN CONSENT OF THE

Project Name:	19820 Homestead Road, Cupertino	

A17



A View from Homestead Road



COPYRIGHT 200

ALL DRAWINGS AND WRITTEN MATERIAL.

APPEARING HEREN CONSTITUTE ORGANAL
AND LIAPLELISHED WORK OF THE
ARCHITECT, AND THE SAME MAY NOT BE
DUPLICATED, USED OT ALTERED WITHOUT
THE WRITTEN CONSENT OF THE

19820 Homestead Road, Cupertino		
STREET VIEW FROM HOMESTEAD ROAD		

DATE 11/09/2020 SCALE PRINTABLE TO SCALE FORMAT 12" X 18" Project Number






Residential Property on East side of the Property: City of Sunnyvale R0 Single Story Single Family Home



PG&E Property on the West Side of the Property. Land Use: Quasi Public/ Institutional

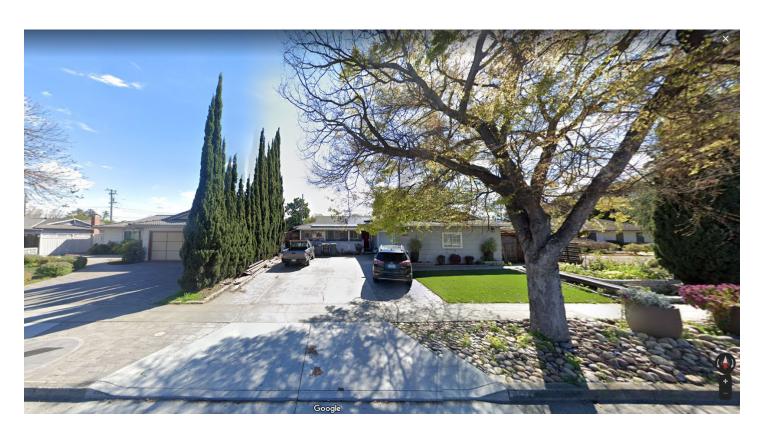

Residential Property on East side of the Property: City of Sunnyvale R0 Single Story Single Family Home



Residential Property on the North side of the Property: City of Sunnyvale Double Story Residences with Low Medium Density




WWW.Dellomoarchitects.cc


COPYRIGHT 24

ALL DRAWINGS AND WRITTEN MATERIA.
APPEARING FEREN CONSTITUTE ORGANIA.
AND LIMPUBLISHED WORK OF THE
ARCHITECT, AND THE SAME MAY NOT BE
THE WRITTEN CONSIST OF THE
ARCHITECT. THE WRITTEN CONSIST OF THE
ARCHITECT.

Project Name:
19820 Homestead Road, Cupertino
CONTEXT PICTURES

DATE 11/09/2020 SCALE PRINTABLE TO SCALE FORMAT 12* X 18* Project Numbei

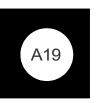

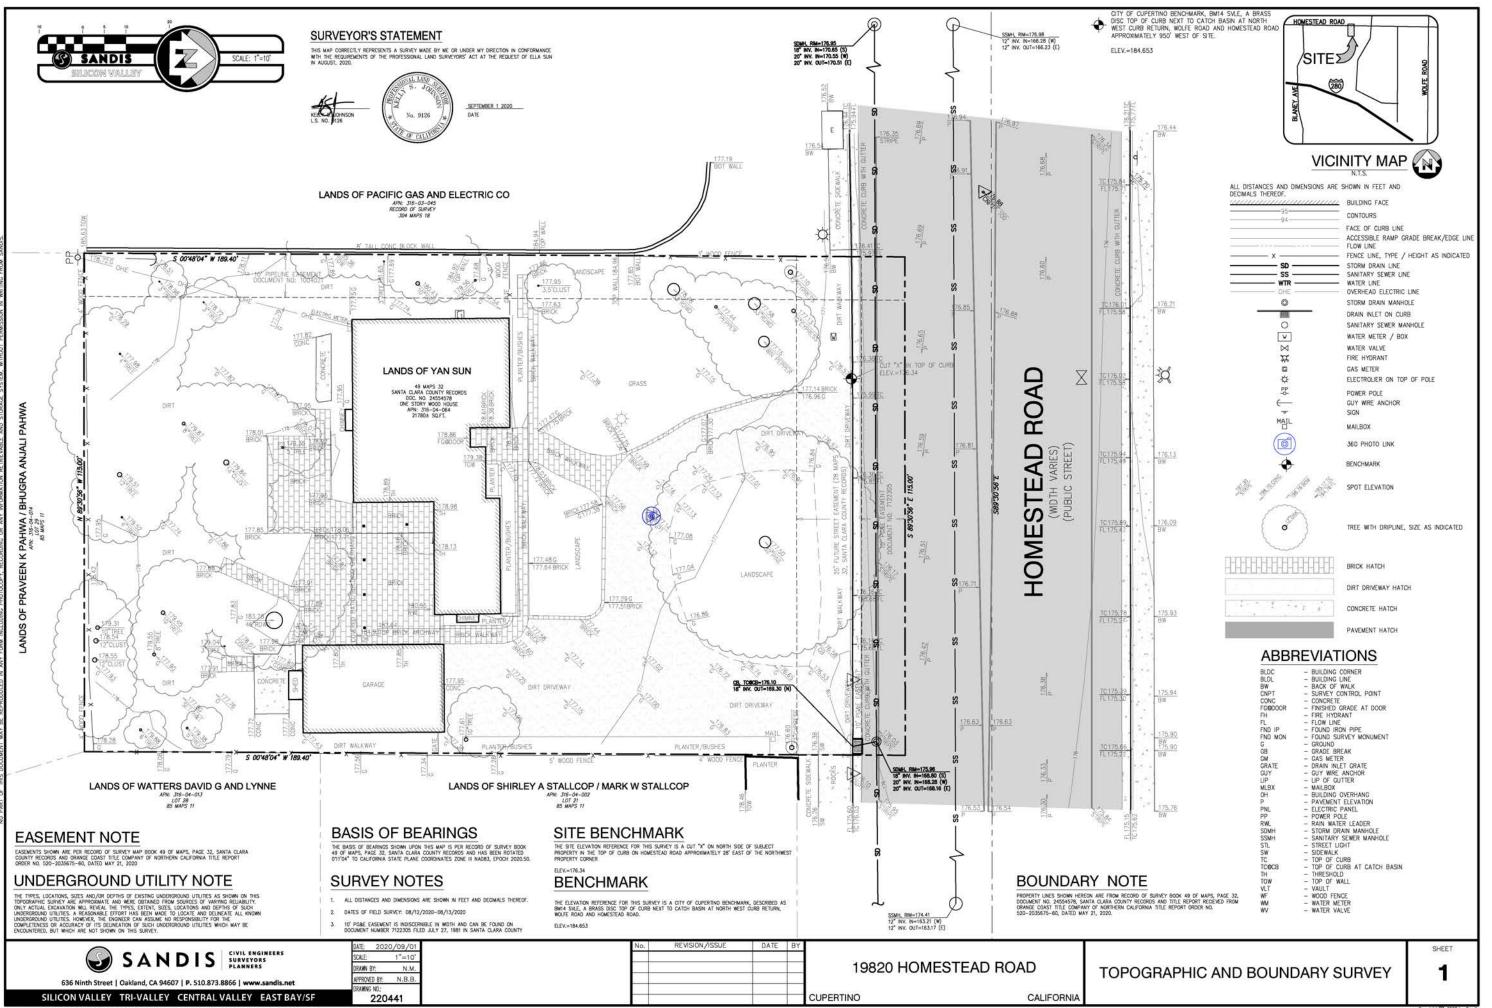

102 University Avenue, Suite C Palo Alto , CA 94301 Tel 650.326.0374

el 650.326.0374

COPYRIGHT 20

ALL DRAWINGS AND WRITTEN MATERIAL
APPEARING HEREIN CONSTITUTE ORIGINAL
AND LINPIUS HEED WORK OF THE
ARCHITECT. AND THE SAME MAYNOT BE
DIEP LICATED LISED OF ALL TERFER WITHOUT

DATE
09/27/20
SCALE
PRINTABLE TO SCALE FORMAT 12* X 18*
Project Number


Cupertino


Homestead Road,

SITE SURVEY

Project Name: 19820 Homestea



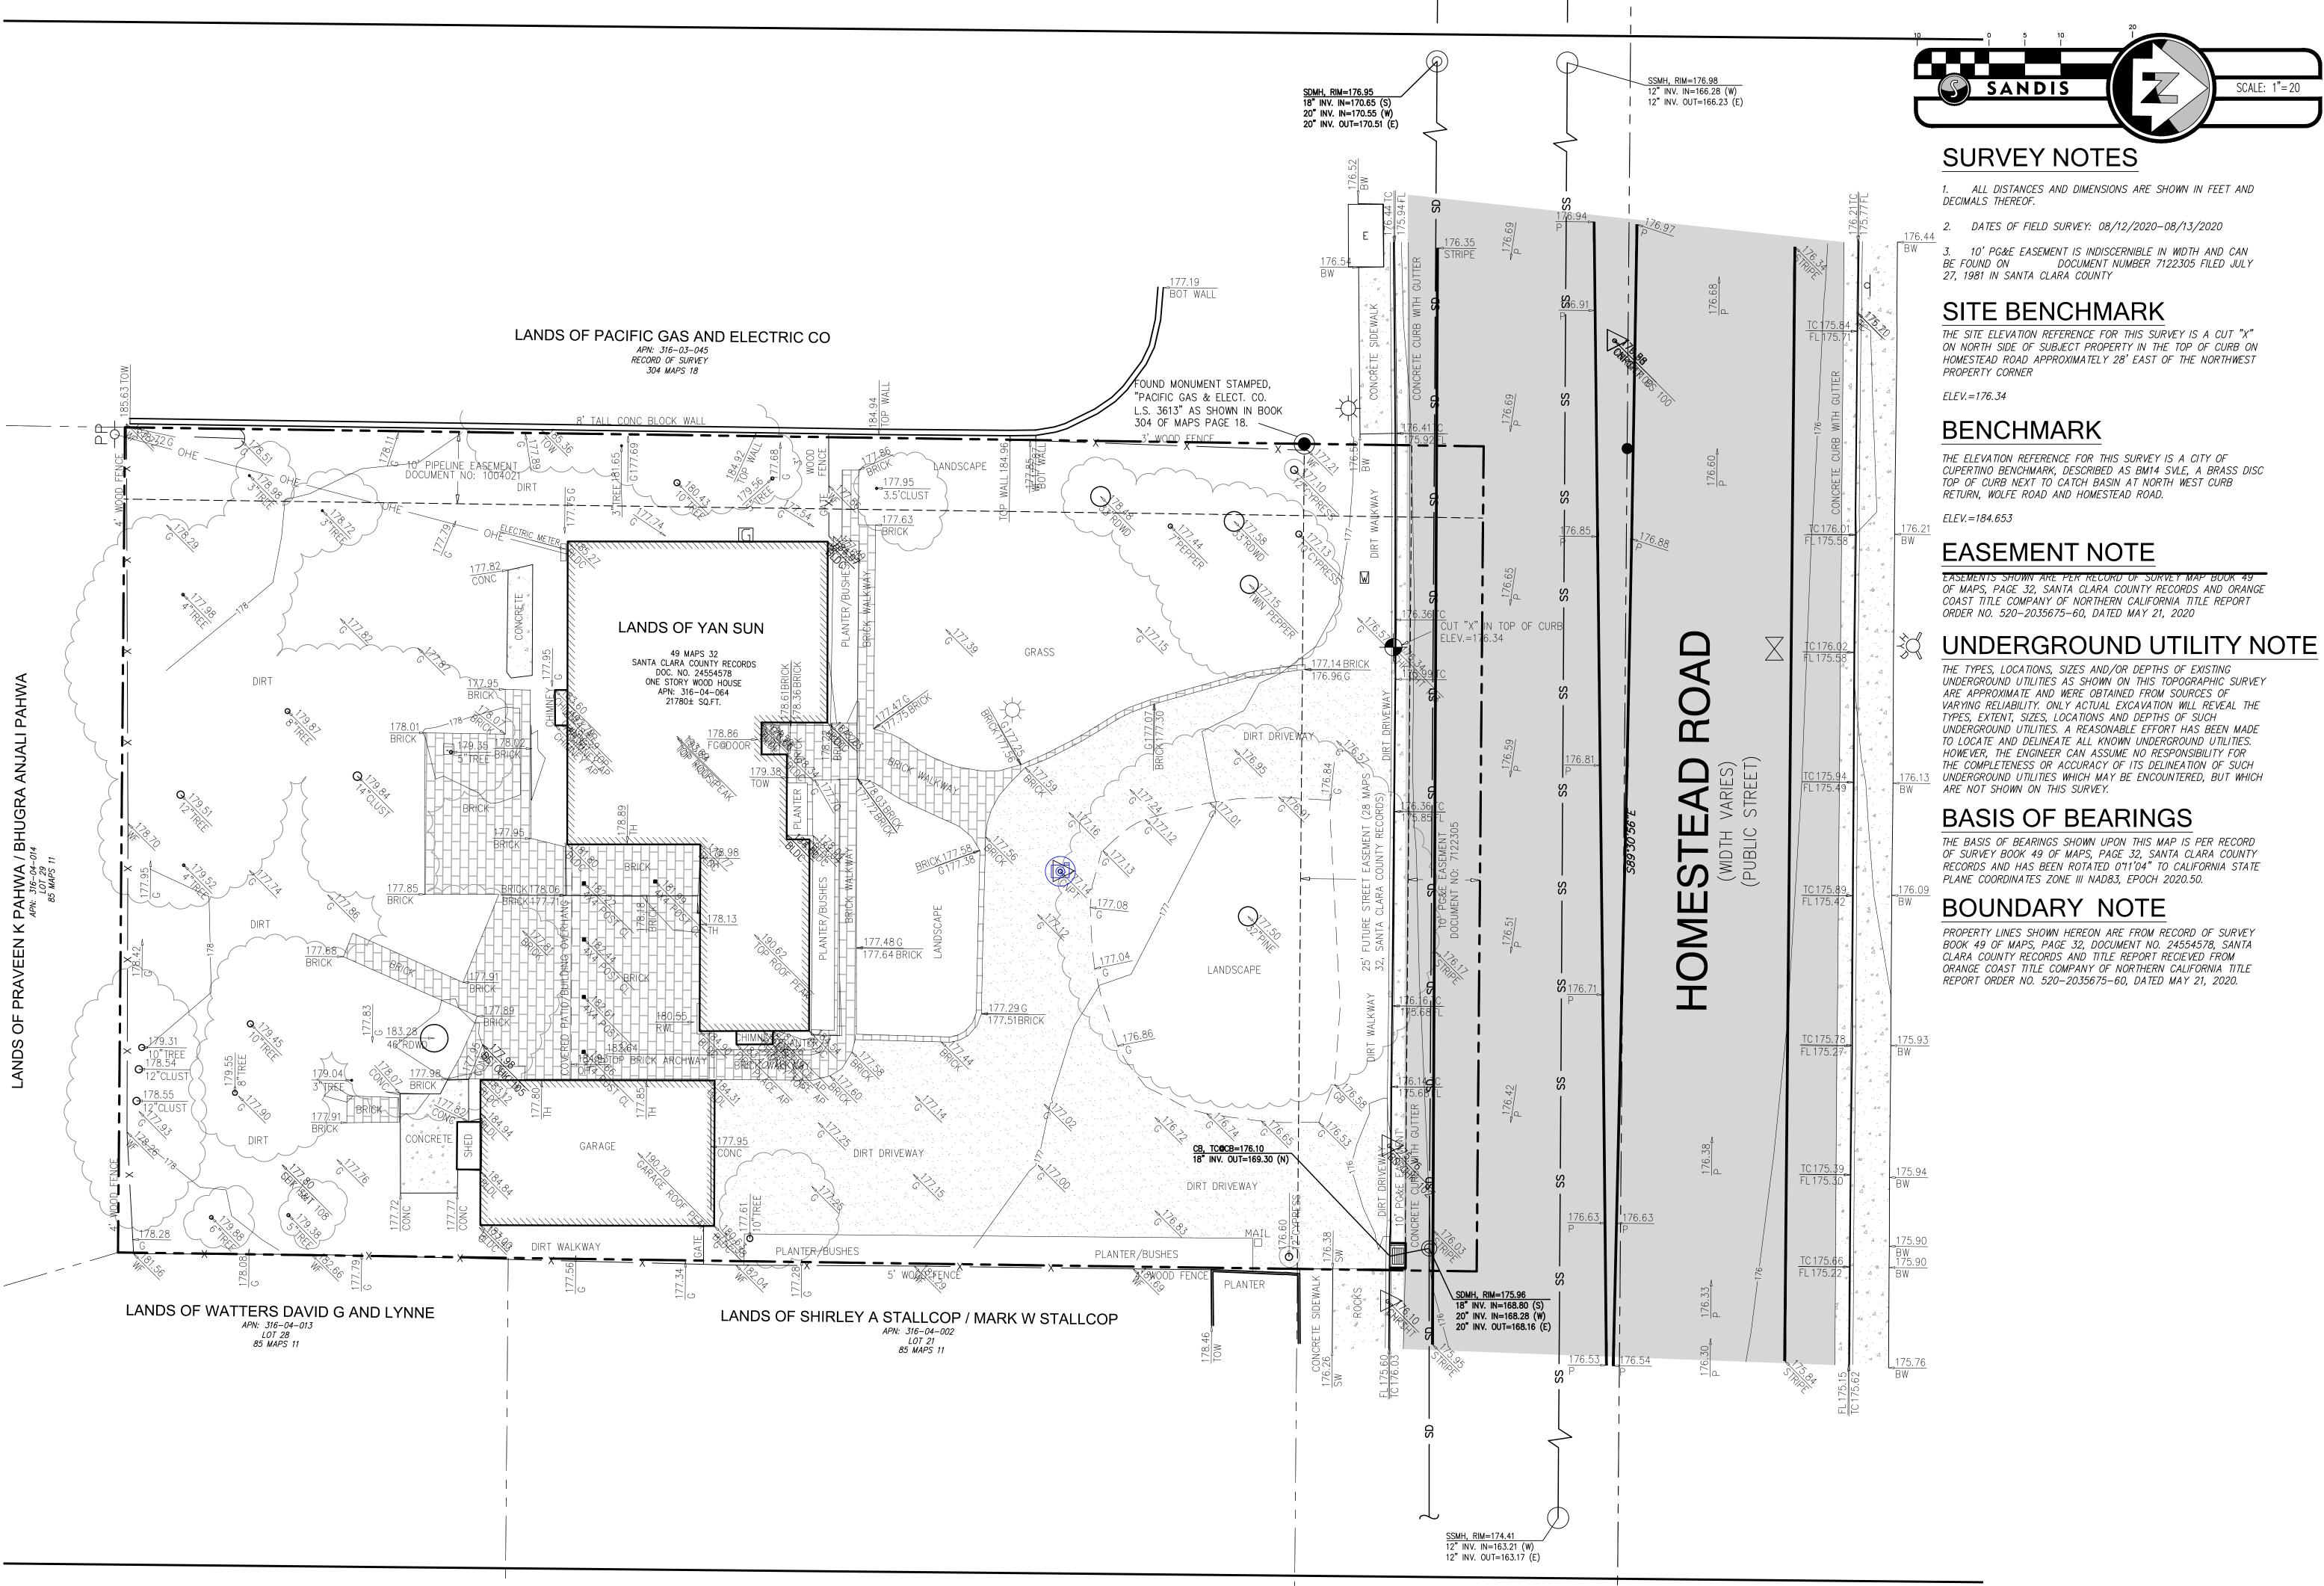

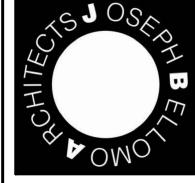


102 University Avenue, Suite C Palo Alto, CA 94301 Tel 650.326.0374

www.bellomoarchitects.com

COPYRIGHT 2020


ALL DRAWINGS AND WRITTEN MATERIAL APPEARING HEREIN CONSTITUTE ORIGINAL AND UNPUBLISHED WORK OF THE ARCHITECT, AND THE SAME MAY NOT BE DUPLICATED, USED OT ALTERED WITHOUT THE WRITTEN CONSENT OF THE ARCHITECT


DATE 10/26/20 SCALE AS SHOWN Project Number

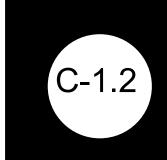

Cupe

Project Name: 19820 Homestea

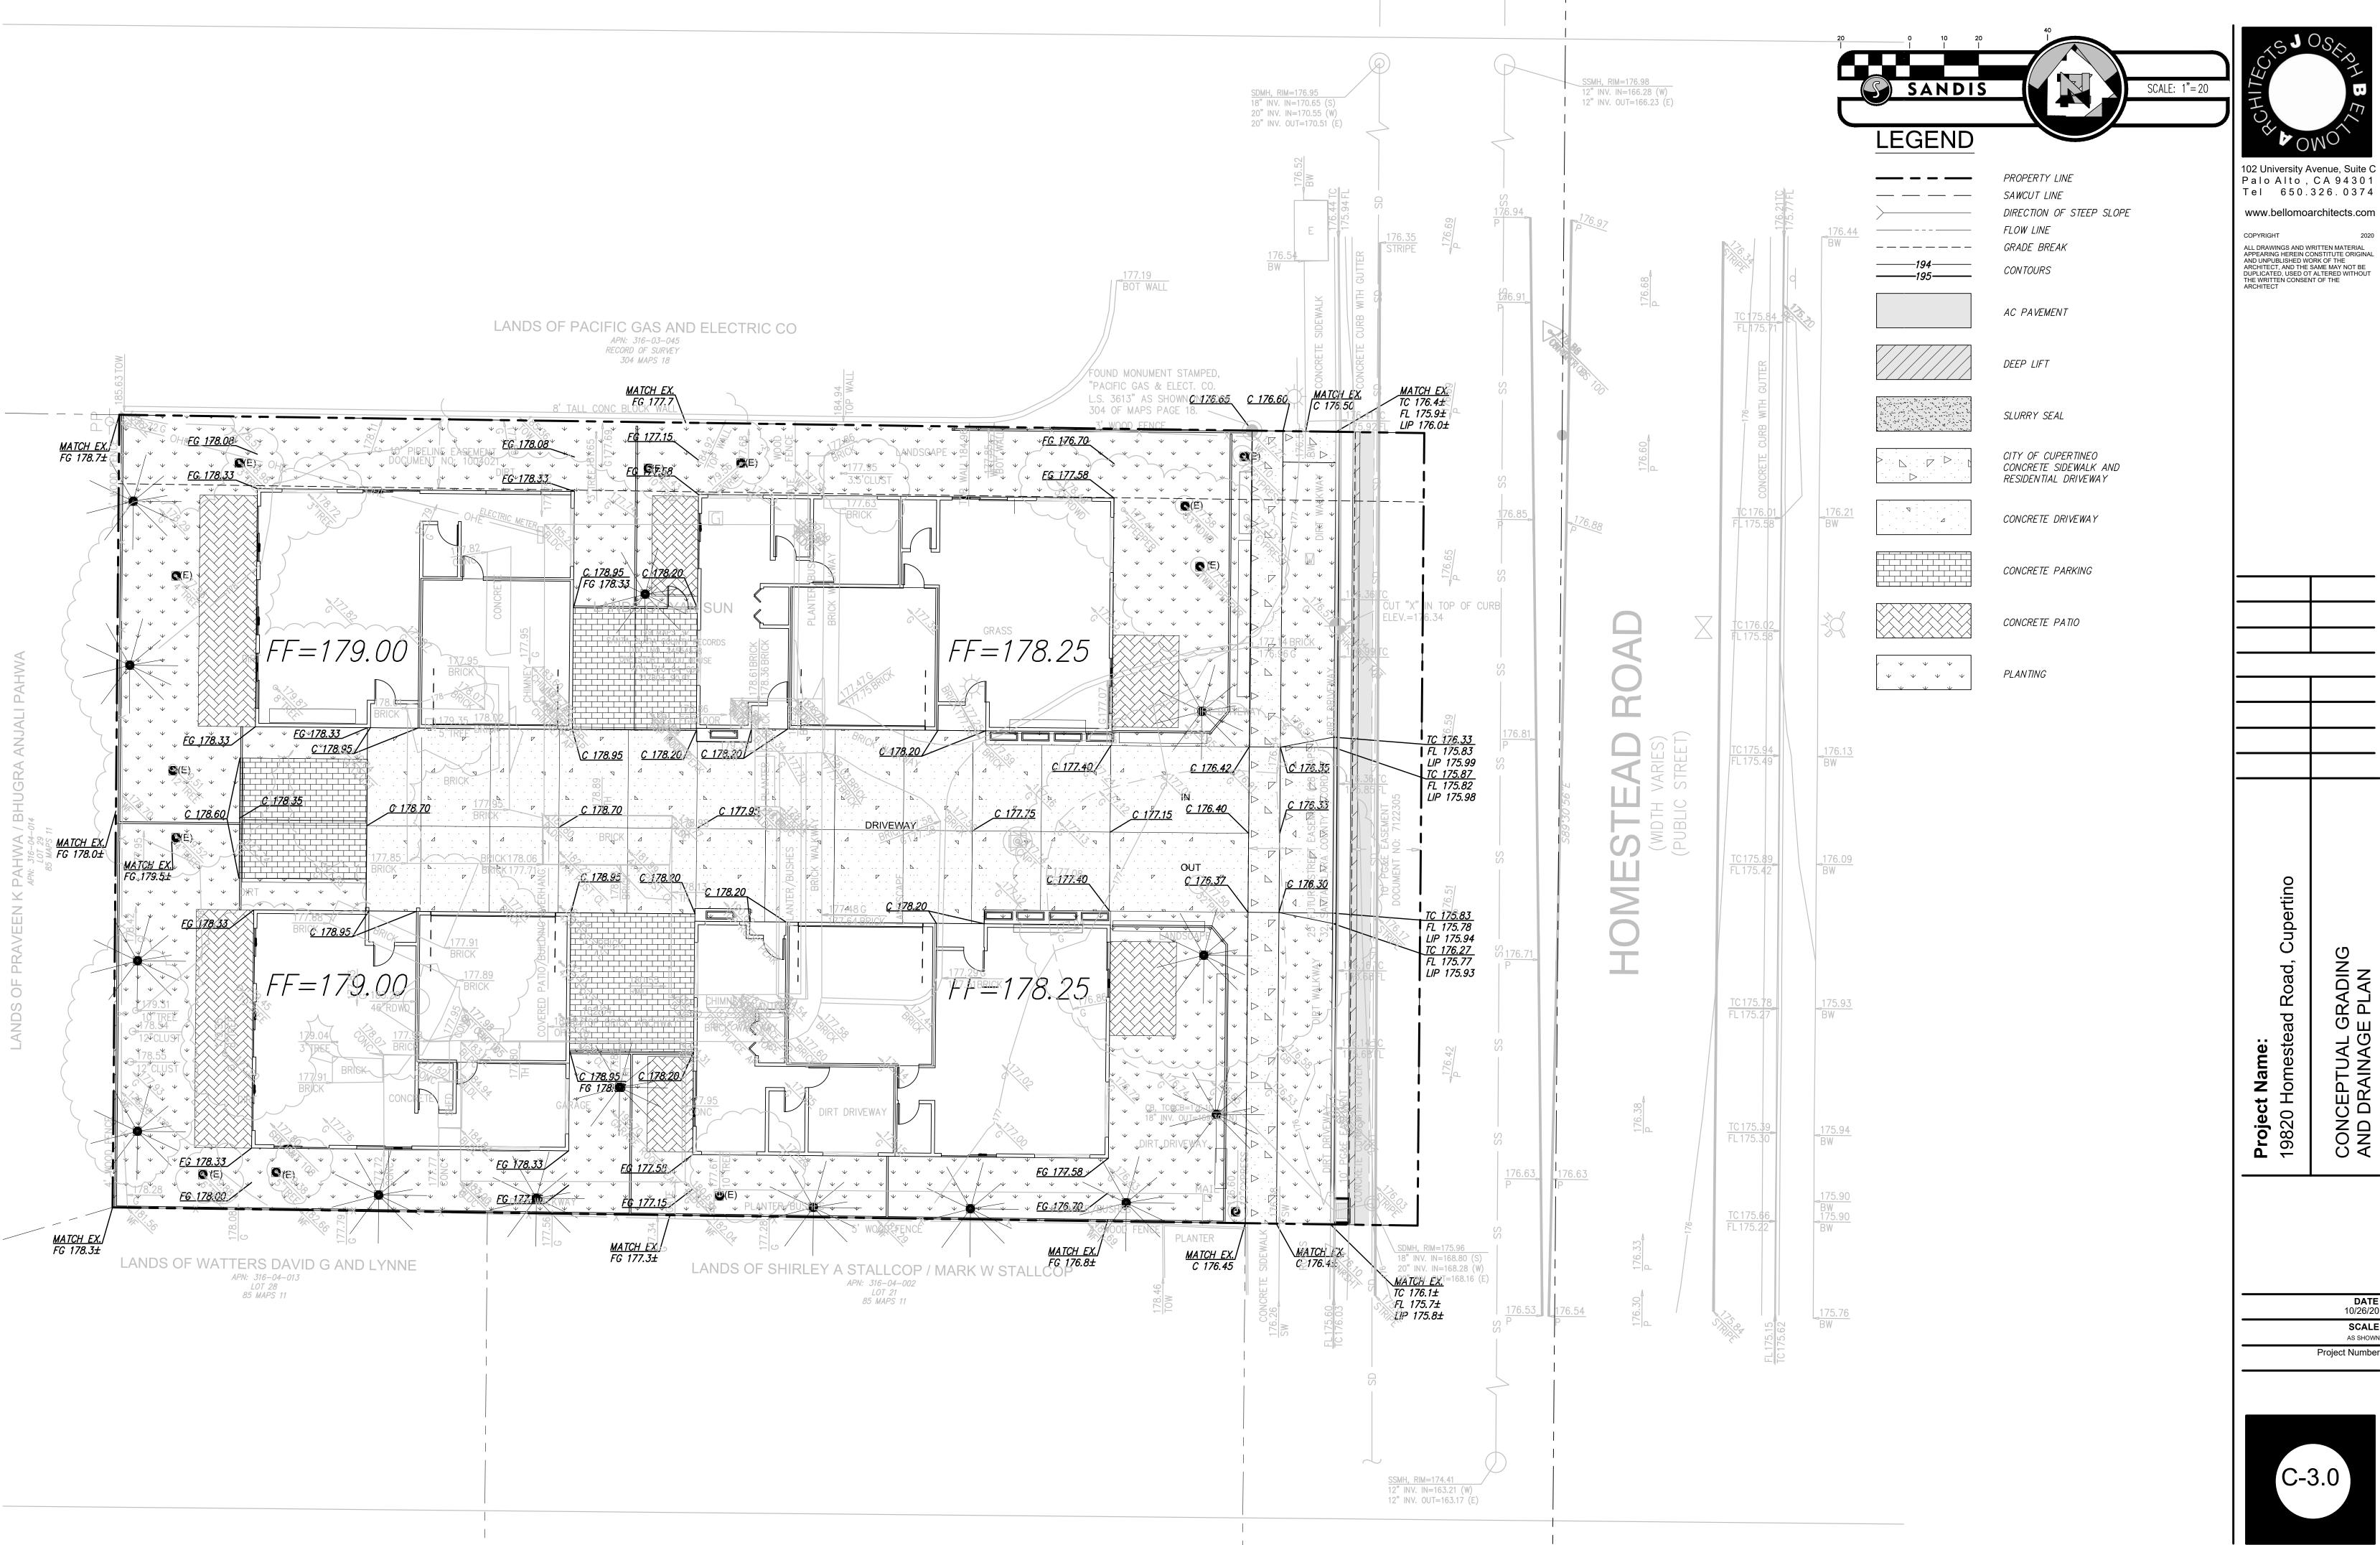


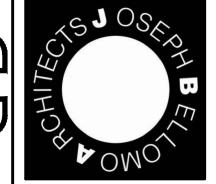


Palo Alto, CA 94301 Tel 650.326.0374 www.bellomoarchitects.com

ALL DRAWINGS AND WRITTEN MATERIAL APPEARING HEREIN CONSTITUTE ORIGINAL AND UNPUBLISHED WORK OF THE ARCHITECT, AND THE SAME MAY NOT BE DUPLICATED, USED OT ALTERED WITHOUT THE WRITTEN CONSENT OF THE ARCHITECT

DATE 10/26/20 SCALE AS SHOWN Project Number

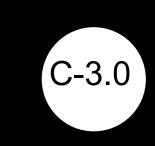

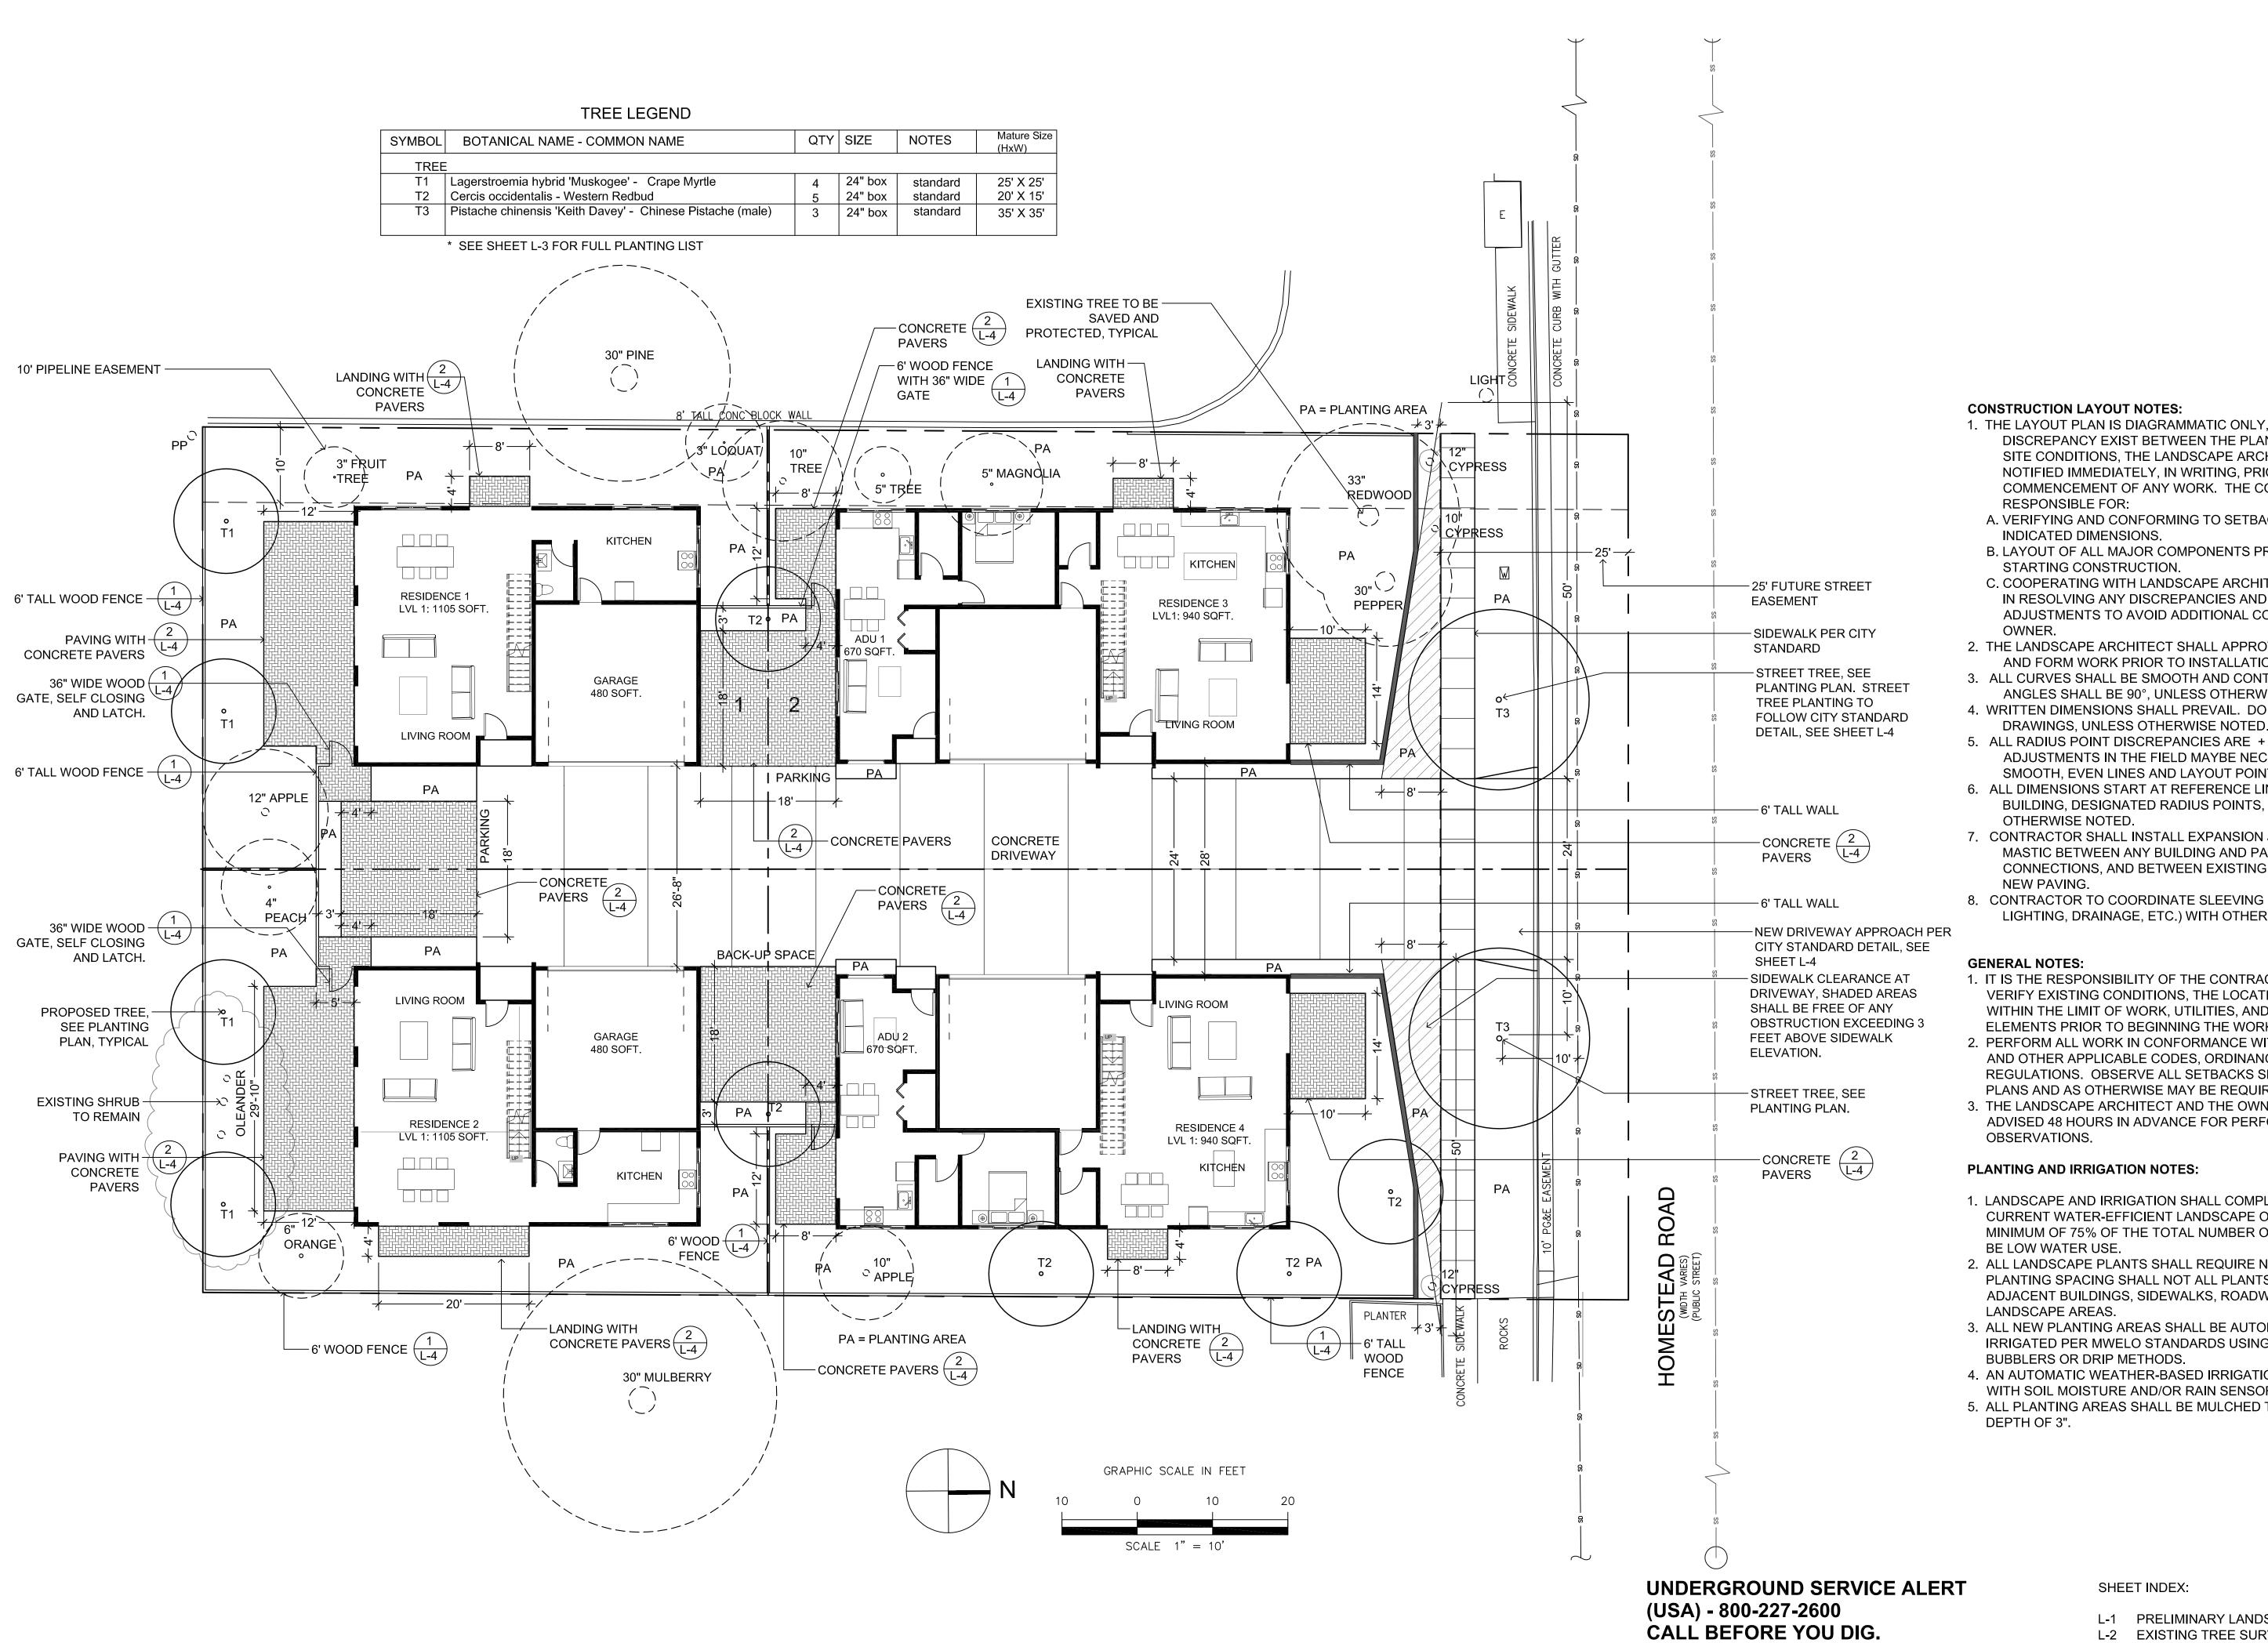

LANDSCAPE STUDIO

2647 ROYAL ANN DRIVE UNION CITY, CA 94587 anyi@anyilandscape.com 650-533-0107

REVISION DATE | NO.

- 1. THE LAYOUT PLAN IS DIAGRAMMATIC ONLY, SHOULD A DISCREPANCY EXIST BETWEEN THE PLAN AND ACTUAL SITE CONDITIONS, THE LANDSCAPE ARCHITECT SHALL BE NOTIFIED IMMEDIATELY, IN WRITING, PRIOR TO COMMENCEMENT OF ANY WORK. THE CONTRACTOR IS RESPONSIBLE FOR:
- A. VERIFYING AND CONFORMING TO SETBACKS AND OTHER INDICATED DIMENSIONS.
- B. LAYOUT OF ALL MAJOR COMPONENTS PRIOR TO
- C. COOPERATING WITH LANDSCAPE ARCHITECT AND OWNER IN RESOLVING ANY DISCREPANCIES AND MAKING ADJUSTMENTS TO AVOID ADDITIONAL COSTS TO THE
- 2. THE LANDSCAPE ARCHITECT SHALL APPROVE ALL STAKE UP AND FORM WORK PRIOR TO INSTALLATION.
- 3. ALL CURVES SHALL BE SMOOTH AND CONTINUOUS AND ALL
- ANGLES SHALL BE 90°, UNLESS OTHERWISE NOTED. 4. WRITTEN DIMENSIONS SHALL PREVAIL. DO NOT SCALE
- 5. ALL RADIUS POINT DISCREPANCIES ARE +/-.
- ADJUSTMENTS IN THE FIELD MAYBE NECESSARY FOR SMOOTH, EVEN LINES AND LAYOUT POINTS.
- 6. ALL DIMENSIONS START AT REFERENCE LINES, FACE OF BUILDING, DESIGNATED RADIUS POINTS, UNLESS OTHERWISE NOTED.
- 7. CONTRACTOR SHALL INSTALL EXPANSION JOINTS WITH MASTIC BETWEEN ANY BUILDING AND PAVING CONNECTIONS, AND BETWEEN EXISTING PAVING AND
- 8. CONTRACTOR TO COORDINATE SLEEVING (IRRIGATION, LIGHTING, DRAINAGE, ETC.) WITH OTHER CONTRACTORS
- 1. IT IS THE RESPONSIBILITY OF THE CONTRACTOR TO FIELD VERIFY EXISTING CONDITIONS, THE LOCATION OF ALL TREES WITHIN THE LIMIT OF WORK, UTILITIES, AND ALL SITE ELEMENTS PRIOR TO BEGINNING THE WORK.
- 2. PERFORM ALL WORK IN CONFORMANCE WITH REQUIREMENTS AND OTHER APPLICABLE CODES, ORDINANCES AND REGULATIONS. OBSERVE ALL SETBACKS SHOWN ON THE PLANS AND AS OTHERWISE MAY BE REQUIRED.
- 3. THE LANDSCAPE ARCHITECT AND THE OWNER SHALL BE ADVISED 48 HOURS IN ADVANCE FOR PERFORMANCE OF SITE

PLANTING AND IRRIGATION NOTES:

- 1. LANDSCAPE AND IRRIGATION SHALL COMPLY WITH CITY'S CURRENT WATER-EFFICIENT LANDSCAPE ORDINANCE. A MINIMUM OF 75% OF THE TOTAL NUMBER OF PLANTS SHALL
- 2. ALL LANDSCAPE PLANTS SHALL REQUIRE NO SHEARING. PLANTING SPACING SHALL NOT ALL PLANTS TO GROW IN ADJACENT BUILDINGS, SIDEWALKS, ROADWAYS, OR
- 3. ALL NEW PLANTING AREAS SHALL BE AUTOMATICALLY IRRIGATED PER MWELO STANDARDS USING LOW-FLOW BUBBLERS OR DRIP METHODS.
- 4. AN AUTOMATIC WEATHER-BASED IRRIGATION CONTROLLER WITH SOIL MOISTURE AND/OR RAIN SENSOR SHALL BE USED.
- 5. ALL PLANTING AREAS SHALL BE MULCHED TO A MINIMUM

SHEET INDEX:

CONTRACTOR TO CALL USA 2 DAYS BEFORE EXCAVATION

TO LOCATE UNDERGROUND UTILITIES.

- L-1 PRELIMINARY LANDSCAPE PLAN
- L-2 EXISTING TREE SURVEY
- L-3 PRELIMINARY PLANTING PLAN
- L-4 LANDSCAPE CONSTRUCTION DETAILS

AND

DATE: 11/6/2020 SCALE: 1" = 10'-0" DRAWN BY:


SHEET

TOTAL SHEETS: 4

 AH

PROJECT#

20031

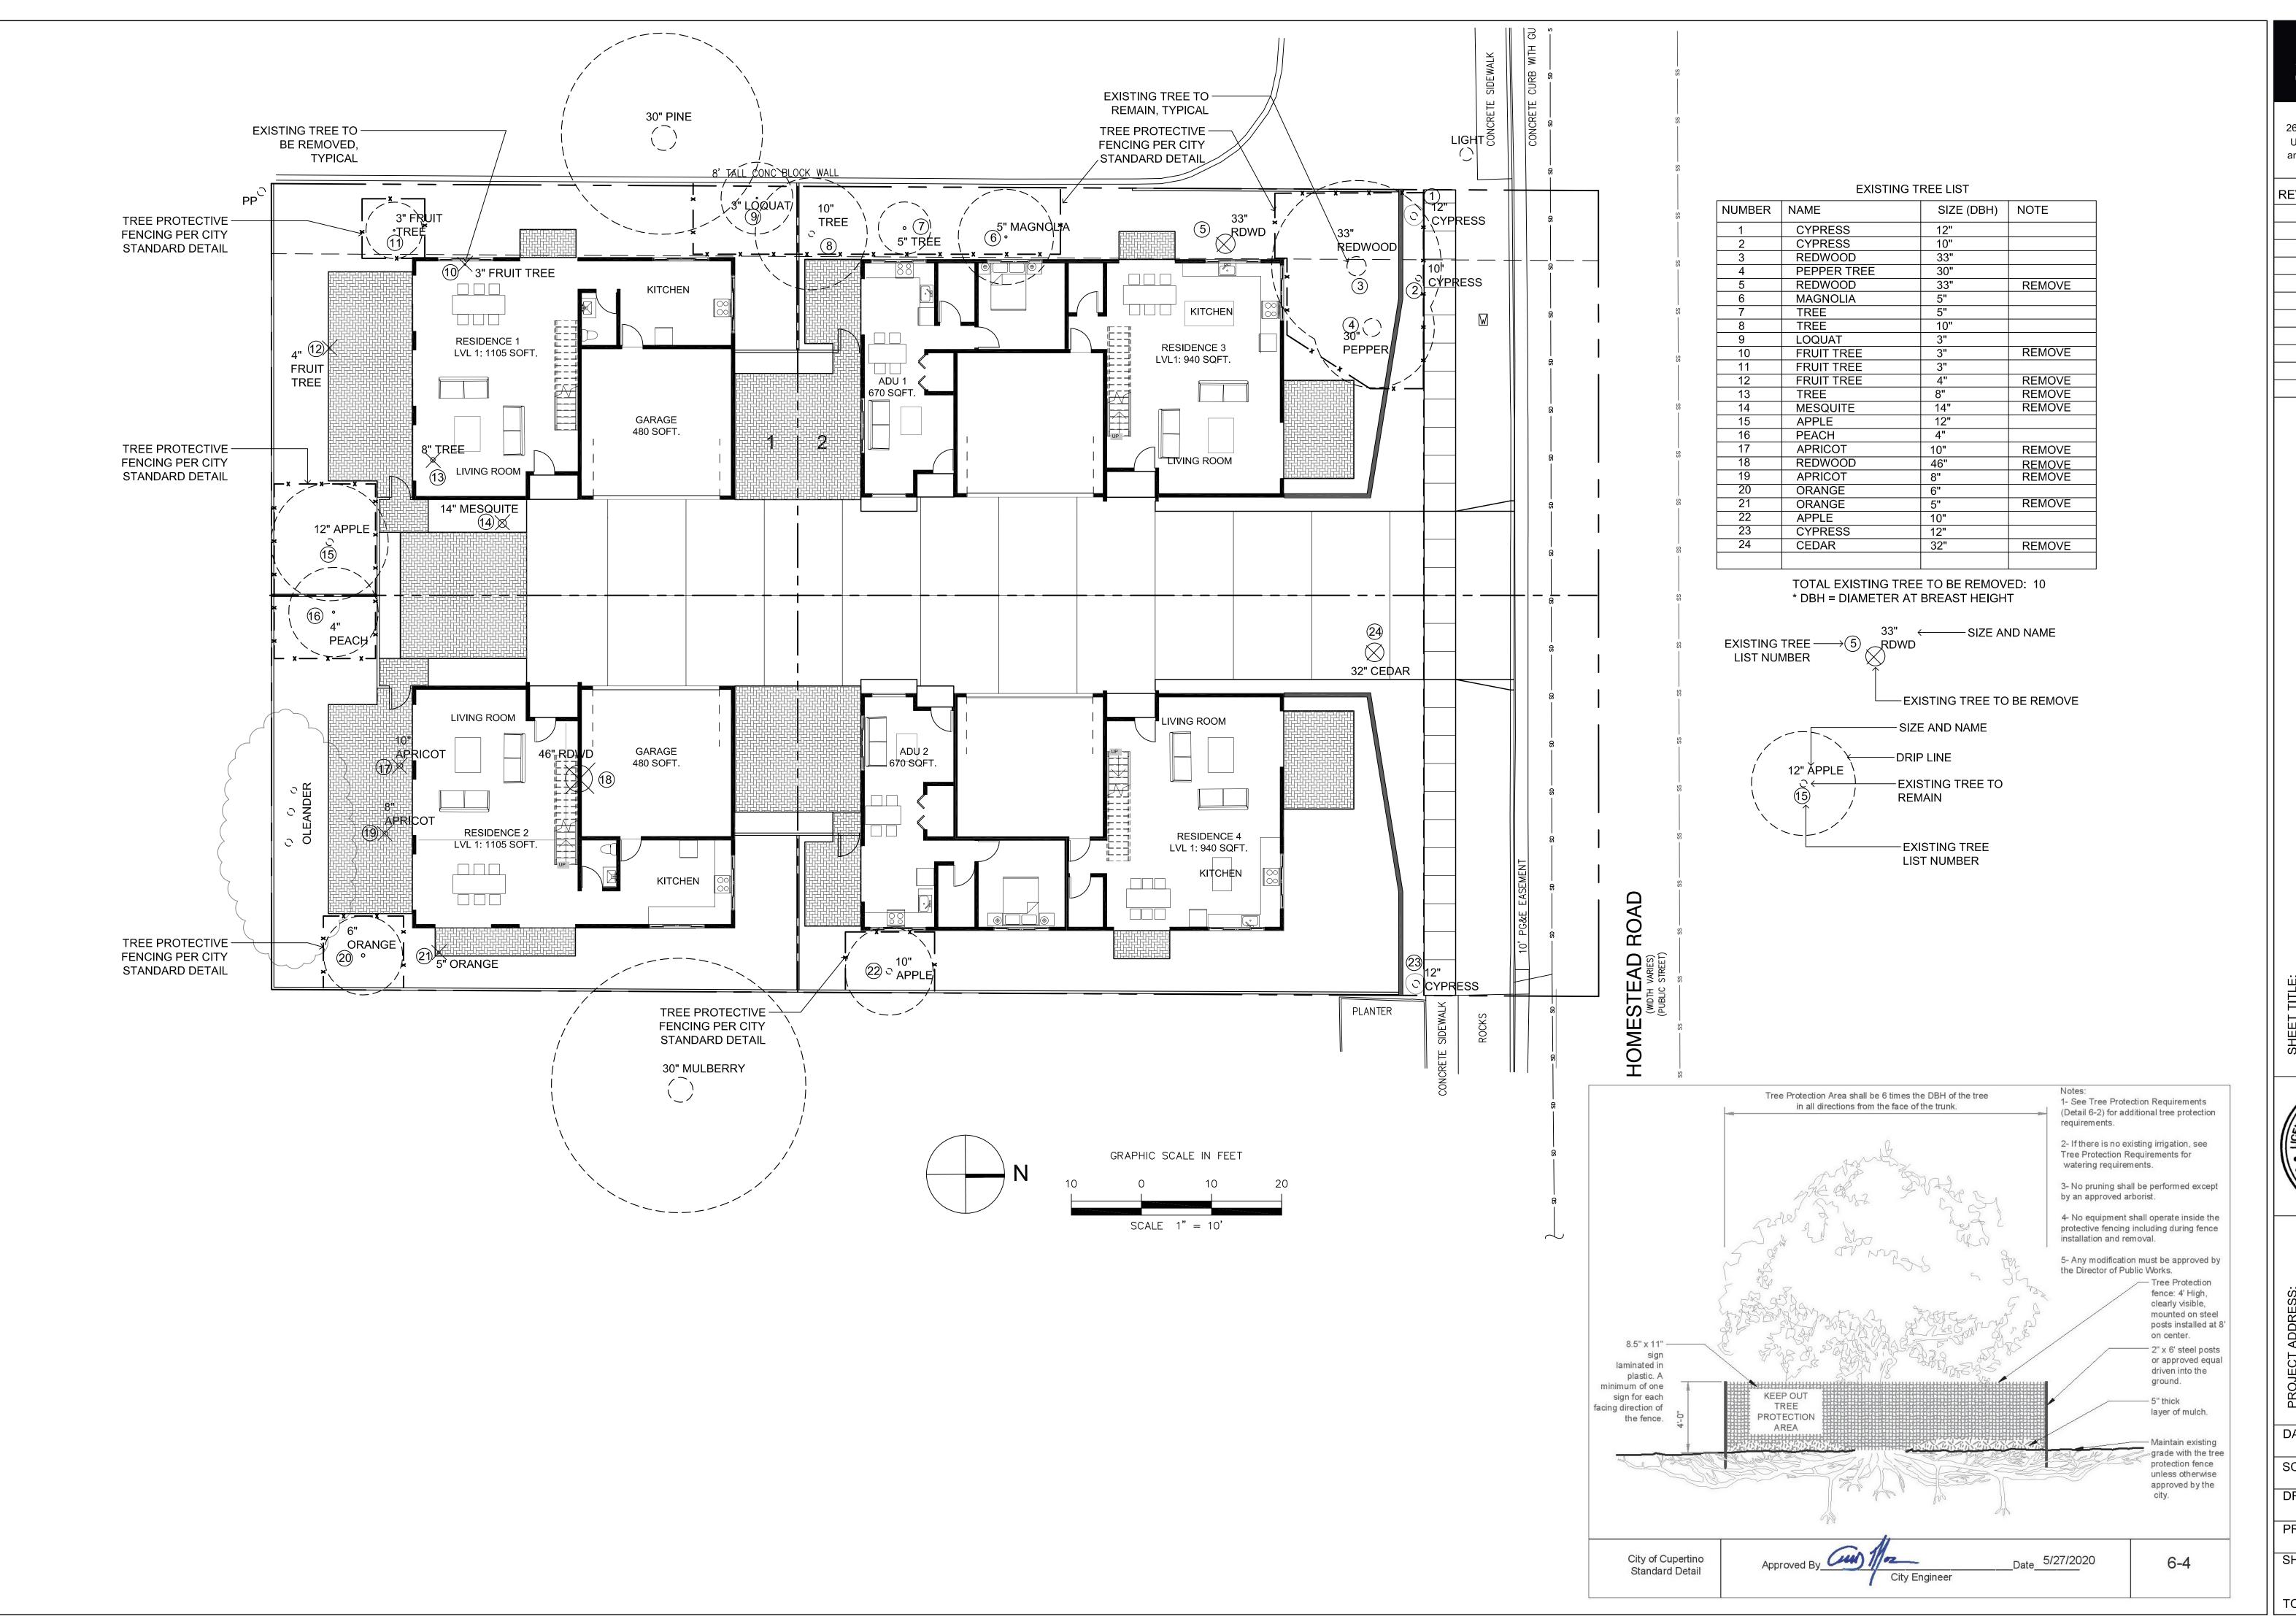


LANDSCAPE STUDIO

2647 ROYAL ANN DRIVE UNION CITY, CA 94587 anyi@anyilandscape.com 650-533-0107

REVISION DATE NO.

SUR TRE EXISTING

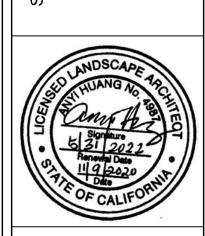

DATE 11/6/2020

SCALE: DRAWN BY: AH PROJECT# 20031

SHEET

TOTAL SHEETS: 4



PLANTING LIST


SYMBOL	BOTANICAL NAME - COMMON NAME	QTY	SIZE	WUCOLS	NOTES	Mature Size (HxW)
TREE						
T1	Lagerstroemia hybrid 'Muskogee' - Crape Myrtle	4	24" box	L	standard	25' X 25'
T2	Cercis occidentalis - Western Redbud	5	24" box	L	standard	20' X 15'
Т3	Pistache chinensis 'Keith Harvey' - Chinese Pistache (male)	3	24" box	L	standard	35' X 35'
SHRI ac	JBS Acacia cognata 'Cousin Itt' - Cousin Itt Acacia	12	5 gallon			3' x 6'
Di	Dietes iridioides - African Iris	12	5 gallon	Ĺ		3' x 3'
Lm	Lomandra longifolium 'Breeze' - Dwarf Mat Rush	30	1 gallon	L		3' x 3'
My	Myoporum 'Putah Creek' - Putah Creek Myoporum	32	1 gallon	L		1' x 8'
IVIY	, , ,		5 gallon	ı		3' x 3'
N	Nandina domestica 'Gulf Stream' - Gulf Stream Nandina	6	j o galion	-		3 \ 3
	Nandina domestica 'Gulf Stream' - Gulf Stream Nandina Pittosporum tobira 'Cream de Mint' - Dwarf Variegated Tobira	7	5 gallon	L		2'x2'


WUCOLS CATEGORIES OF WATER NEEDS: VL = VERY LOW, L = LOW WATER USE, M = MODERATE WATER USE

I HAVE COMPLIED WITH THE CRITERIA OF THE ORDINANCE AND APPLIED THEM FOR THE EFFICIENT USE OF WATER IN THE LANDSCAPE DESIGN PLANS.

PLANTING NOTE:

- 1. Before planting till the following materials into the top 6" of soil (for each 1,000 S.F.):
 - a. 6 cubic yards green waste compost
 - 10 LB fertilizer (N16/P6/K8) w/ 2% iron c. 5 LB sulfate of ammonia
- 2. Mulch all planted areas with a 3" thick layer of medium recycled wood chips, color 'Dark
- 3. For trees, nursery stakes shall be removed at the time of planting. See tree planting detail. Street tree planting to follow city Standard Detail 6-10 / SHEET L-4.
- 4. The Landscape Architect and the Owner reserve the right to reject any or all plant material, if such material does not meet the American Standards for Nursery Stock (ANSI). Plant materials shall be guaranteed against latent defects, injuries, pests, diseases or death of plants due to improper planting. Tree missing central leader will be rejected. The Contractor shall promptly replace plants that have died or are not in a vigorous, healthy condition with plants of the same kind and size as originally specified
- at no expense to the Owner. 5. Landscape Architect to approve plant locations prior to planting.
- 6. The Contractor shall be responsible to continuously maintain grades, plant material, and irrigation through the 60 days maintenance period until final acceptance of the work by the Owner.
- 7. The Contractor shall be responsible for the adequate protection of the improvements during construction period and through maintenance period. Damaged areas, such as sprinkler heads or plant materials, shall be replaced or repaired at no additional expense to the Owner.

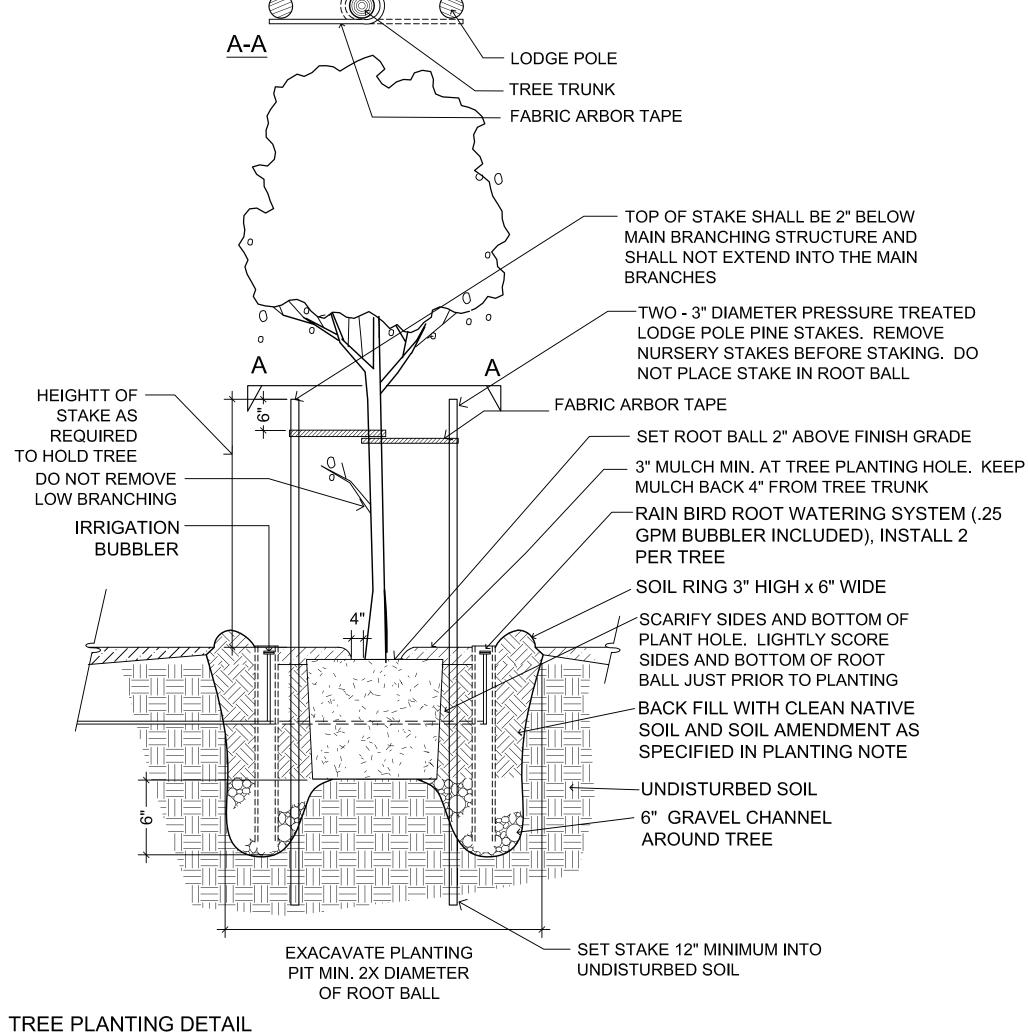

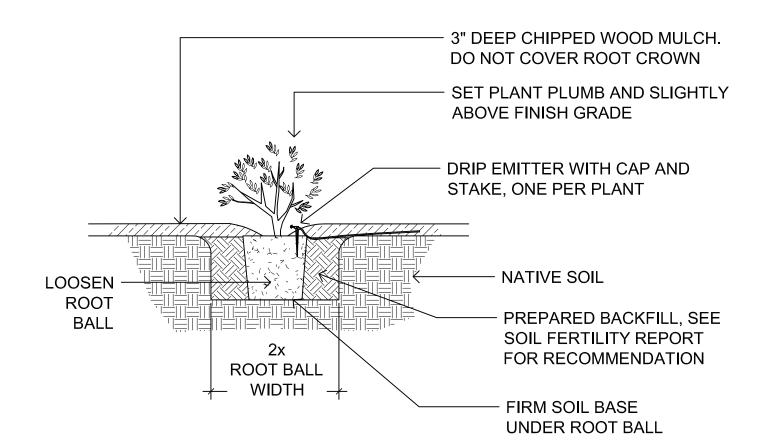


SHRUB PLANTING DETAIL



2647 ROYAL ANN DRIVE UNION CITY, CA 94587 anyi@anyilandscape.com 650-533-0107

REVISION DATE NO.

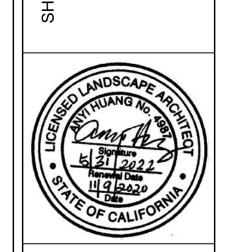

JECT

DATE: 11/6/2020 SCALE: 1" = 10'-0" DRAWN BY: AH PROJECT#

20031 SHEET


_ - 3 TOTAL SHEETS: 4


DRIVEWAY DETAIL - DETACHED SIDEWALK


APPROVED BY:

(m) 1/2

CITY ENGINEER

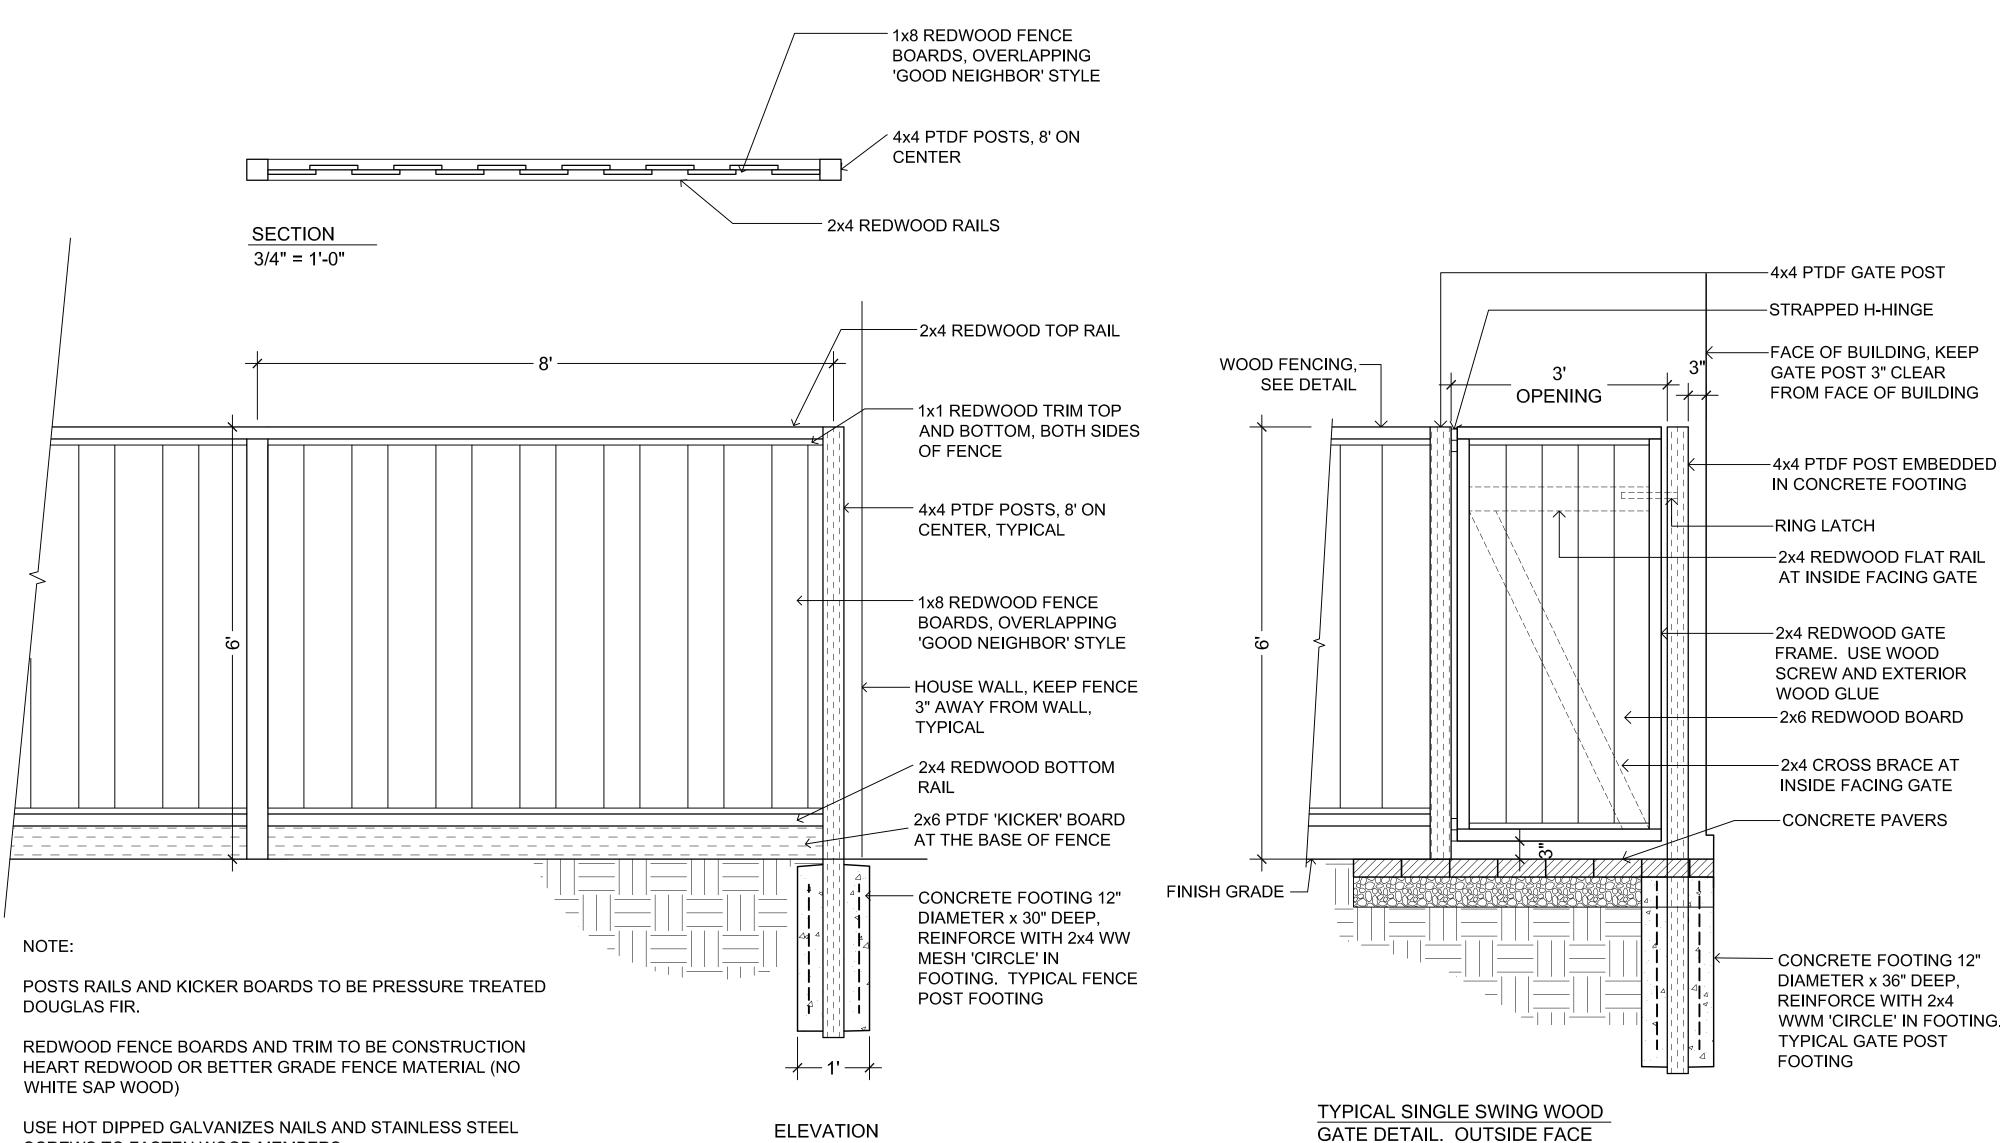

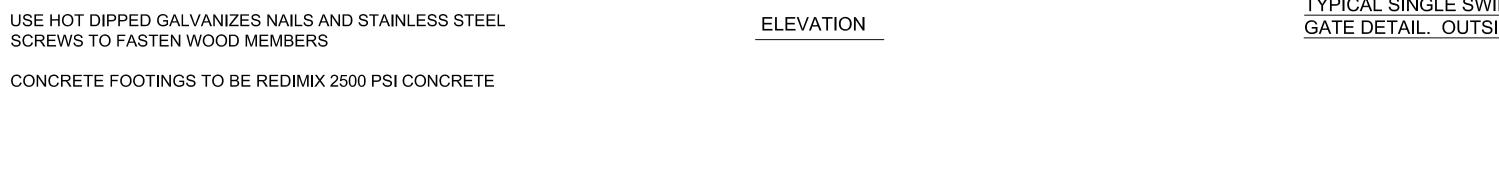

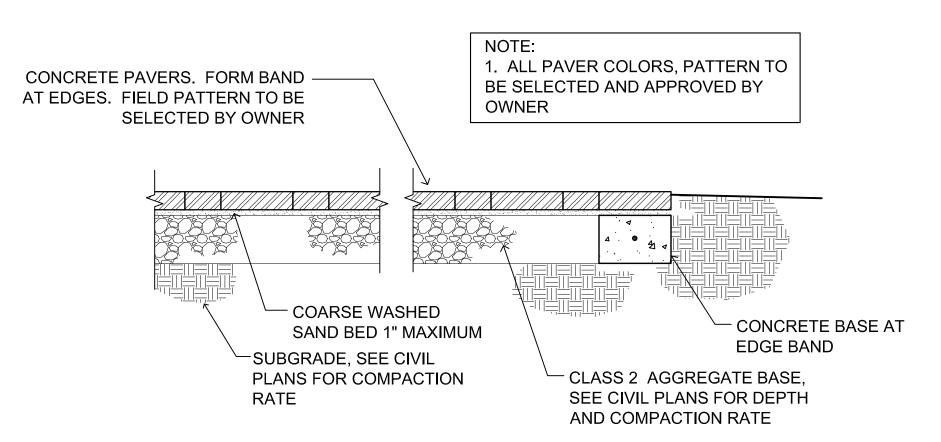

TYPICAL PAVING WITH CONCRETE PAVERS SECTION SCALE: 3/4" = 1'-0"

PAVING WITH CONCRETE PAVERS DETAIL

6' TALL WOOD FENCE AND 36" OPENING GATE TYPICAL DETAILS

SCALE: 3/4" = 1'-0"


SCALE: 3/4" = 1'-0"

-SCH. 80 PVC NIPPLE PVC LATERAL LINE - 4-PLY 1"x 2'-0" RUBBER TIES INSTALLED W/ A
TWIST & NAILED
TO THE STAKES -1 1/ 4 " GALV. ROOFING NAIL (1 EACH END) RUBBER TIES PLACED 6" MAX BELOW MAIN FORK OR BRANCH INSTALLED WITH A TWIST AND 1/2' FLEX PIPE . GRATE COVER -COMPACTED TOPSOIL NAILED TO STAKE -15 GAL. OR SMALLER
(2) 3" DIA LODGE POLE PINE STAKES
-24" BOX OR LARGER "1"x 4" ROUGH REDWOOD WITH (2) 2" GALV. NAILS EACH CONNECTION BE RE (LOCATE ON PREVAILING -PLACE ROOT CROWN 1/2"- 3/4 ----- ABOVE FINISHED GRADE 2" OF FINE SCREENED FIR BARK FINISHED GRADE SCH. 80 PVC NIPPLE PIPE SIZE - MATCH BASE OF HEAD -SCARIFY SIDES PROVIDE A 4" MIN., 6" MAX.
SLOT TO ALLOW FOR SETTLEMENT
WRAP OPENING WITH 2 LAYERS OF
MIRAFI DRAINAGE REALIGN TABLE CLOTH - FERTILIZER TABLETS
AS SPECIFIED 4" DIA. x 3'-0" PERFORATED STYRENE DRAIN PIPE NOIL AMENDED PLANTING FILL MIX AS SPECIFIED FILL BOTTOM 6" OF DRAIN PIPE WITH DRAIN ROCK 2 X CONTAINER 1 GAL. 2 TABLETS 4" D NOM. 4" DIA. x 3'-0" LONG 2 OR 5 GAL. 3 TABLETS PERFORATED STYRENE PIPE WITH 6 TABLETS 15 GAL. STYRENE DRAIN GRATE COVER AND BUBBLER DETAIL NOTES: BUBBLER IRRIGATION 24" BOX OR LARGER 10 TABLETS USE 2 PIPES IN CONCRETE CUT-OUT AREAS. PUT PIPE ON UPHILL SIDE OF TREE. LEVEL SITE NORTH OF TREE. FERTILIZER .

CITY OF CUPERTINO

STANDARD DETAILS

CITY STANDARD DETAIL - STREET TREE PLANTING

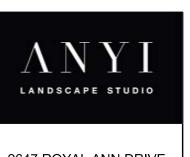

2647 ROYAL ANN DRIVE UNION CITY, CA 94587 anyi@anyilandscape.com 650-533-0107

REVISION DATE | NO.

ONS⁻

REVISED 2/2020

DATE: 5/1/2020

DATE 11/6/2020 SCALE: DRAWN BY: ΑH PROJECT# 20031

SHEET TOTAL SHEETS: 4