
### **ABBREVIATIONS ADJUSTABLE INSIDE DIAMETER** ADJ ALUMINUM **INSUL** INSULATION ALUM ANGLE **MECH** MECHANICAL MET **APPROX APROXIMATE METAL** MFR MANUFACTURER A.F.F. ABOVE FINISHED FLOOR MIN MINIMUM BOARD MOUNTED BLDG BUILDING (N) NEW CAB. CABINET NIC NOT IN CONTRACT **CENTER LINE** NO./# NUMBER CLG CEILING NTS NOT TO SCALE CLR CLEAR ON CENTER COL COLUMN O.D. OUTSIDE DIAMETER CONC CONCRETE OWNER FURNISHED, CONST CONSTRUCTION CONTRACTOR INSTALLED CONT CONTINUOUS RAD **RADIUS** CSK COUNTERSINK CWREC COLD WATER RECESSED RECT RECTANGLE DET DETAIL REF REFERENCE DIA DIAMETER REINFORCED/ING DIM **DIMENSION** REQ REQUIRED DWG **DRAWING** SOLID CORE **EACH** EA **SCHEDULE ELEV ELEVATION** SHEET ELEC ELECTRICAL SIM SIMILAR EQ **EQUAL SPECS SPECIFICATIONS** EXH **EXHAUST SQUARE** STD STANDARD **EXISTING** STLEXT EXTERIOR STAINLESS STEEL EXP **EXPANSION** SUSPENDED **FINISH THICK** FLR **FLOOR** TOP OF SLAB **FEET** TYP **TYPICAL** FIX **FIXTURE** V.I.F. VERIFY IN FIELD GA **GAUGE** VOLUME GALV **GALVANIZED** GL **GLASS** WITH GYP **GYPSUM**

## SYMBOLS

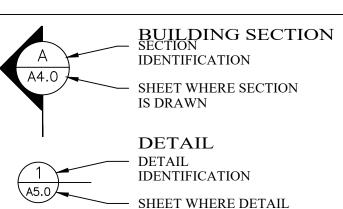

IS DRAWN

WALL

TYPE

## PROJECT NAME

# 76 Gas Stations 10490 S. De Anza Blvd. CUPERTINO, CA

## SCOPE OF WORK

The project consists of a demolition of existing building, and build a new 2,487 sq. ft. of metal stud construction with cement plaster finish convenience store. The new construction and new trash enclosure are fully sprinkered according to to the California Fire code (CFC) and Building code (CBC).

A4.1

WALL

ROOM

**NUMBER** 

COLUMN

**ELEVATION** 

**POINT** 

LINE GRID

**SECTION** 

The existing gas pumps will be slightly moved from west to the east in order to create more space for cars. Landscaping consists of turf and ground covers of varying heights with medium height shrubs, Trees, in clusters of 3 or 4, supply visual vertical screening at wood fence corners per landscaping drawings. Colored river rock is placed in certain areas to introduce a low maintenance item, providing a variety in materials

at selected accent areas. This building will construct based on the California Green Building code.

The hours of operation for this location will 24 hours and the number of occupancy will be 10.

# PROJECT BUILDING DATA CONSULTANTS

### **BUILDING DATA:**

A.P.N.: 369-39-041 ADDRESS: 10490 S. De Anza Blvd. Cupertino, CA 95014 Commercial LAND USE: **EXISTING ZONING** P (CG) Gas Station **EXISTING USE:** 1,221 Sq. ft. **EXISTING FOOT PRINT** LOT SIZE: GROSS Sq. ft. 16,097 Sq.ft. OCCUPANCY GROUP TYPE OF CONSTRUCTION V-B **STORIES** 

**SPRINKLER** Full New wood fence **FENCE** 2,487 Sq. ft. **BUILDING COVERAGE** 2,963 Sq. ft. 22 % LANDSCAPE COVERAGE TRASH ENCLOSURE 235 Sq.ft. 2 % PAVING COVERAGE: 7,489 Sq. ft. 58%

2,487 Sq.ft./ 16,097 Sq. ft. = 15% < 25% Max. FLOOR AREA RATIO (BEFORE LAND DEDICATION) ACTUAL LAND: BEFORE LAND DEDICATION 16,097 Sq. ft.

ACTUAL LAND: AFTER LAND DEDICATION 14,103 Sq. ft. TOTAL LAND DEDICATION 16,097 Sq. ft. - 14103 Sq.ft. = 1994 Sq.ft.

FLOOR AREA RATIO 2,487 Sq.ft./ 14,103 Sq. ft. = 18% < 25% Max. ( AFTER LAND DEDICATION)

Type I Construction **PARKING** Required: 7 Provided per City site study report

235 Sq.ft./ 13,174 Sq. ft. = 2% (Sprinklered)

### **APPLICABLE CODES:**

TRASH ENCLOSURE

1. CALIFORNIA BUILDING CODE, 2016 2. CALIFORNIA PLUMBING CODE, 2016

3. CALIFORNIA FIRE CODE, 2016 4. CALIFORNIA ELECTRICAL CODE, 2016 5. CALIFORNIA MECHANICAL CODE, 2016

6. CALIFORNIA ENERGY CODE, 2016 7. CALIFORNIA GREEN BUILDING CODES 8. CITY OF CUPERTINO CODES AND ORDINANCES, OWNER: Liaoning Benefit Petroleum (US) Corporation 10490 S. De Anza Blvd. Cupertino, CA 95014

ARCHITECT: A.G.P. Design Group Amir Khojasteh Mike Foresee 1296 Virginia Ave. Campbell, CA 95008 Tel.: (408) 316-6168 E-mail: agp@pacbell.net

SMP ENGINEERS SURVEY: Saied Razavi 1534 Carob Lane Los Altos, CA 94024 Tel.: (650) 941-8055 E-mail: smpengineers@yahoo.com

### FIRE SPRINKLERS NOTES:

A) THE CITY OF CUPERTINO REQUIRES FIRE SPRINKLERS THROUGHOUT ALL NEW AND EXISTING BUILDINGS AND STRUCTURES SHALL BE PROVIDED IN THE LOCATIONS DESCRIBED IN THIS SECTION OR IN SECTION 903.2.1THE OWNER(S), OCCUPANT(S) AND ANY CONTRACTOR(S) OR SUBCONTRACTOR(S)

WOOD

GENERAL NOTES

ARE RESPONSIBLE FOR CONSULTING WITH THE WATER PURVEYOR OF RECORD IN ORDER TO DETERMINE IF ANY MODIFICATION OR UPGRADE OF THE EXISTING WATER SERVICE IS REQUIRED. BY CMC. FIRE WALLS AND FIRE BARRIERS USED TO SEPARATE BUILDING AREAS SHALL BE CONSTRUCTED IN ACCORDANCE WITH THE CALIFORNIA BUILDING CODE AND SHALL BE WITHOUT OPENING OR PENETRATIONS.

B) THE AUTOMATIC SPRINKLER SYSTEM SHALL BE INSTALLED IN ACCORDANCE WITH CFC, CMC

C) FAST RESPONSE FIRE SPRINKLER HEADS SHALL BE INSTALLED IN GARAGE AND WORKSHOP AREAS.

D) THE SUPPRESSION CONTRACTOR SHALL PROVIDE TWO COPIES OF THE DRAWINGS AND CALCULATIONS

### E) THE DISTRICT SHALL ISSUE A PERMIT PRIOR TO INSTALLATION OF THE AUTOMATIC SPRINKLER SYSTEM. WATER SUPPLY REQUIREMENT:

POTABLE WATER SUPPLIES SHALL BE PROTECTED FROM CONTAMINATION CAUSED BY FIRE PROTECTION WATER SUPPLIES. 2013 CFC AND HEALTH AND SAFETY CODE.

### TIMING OF INSTALLATION:

WHEN FIRE APPARATUS ACCESS ROAD OR WATER SUPPLY FOR FIRE PROTECTION IS REQUIRED TO BE INSTALLED, SUCH PROTECTION SHALL BE INSTALLED AND MADE SERVICEABLE PRIOR TO AND DURING THE TIME OF CONSTRUCTION. TEMPORARY STREET SIGN SHALL BE INSTALLED AT EACH STREET INTERSECTION WHEN CONSTRUCTION OF NEW ROADWAYS ALLOWS PASSAGE BY VEHICLES,

### PREMISES IDENTIFICATION:

APPROVED NUMBERS OR ADDRESSES SHALL BE PLACED ON ALL NEW BUILDING IN SUCH POSITION AS TO BE PLAINLY VISIBLE AND LEGIBLE FROM STREET OR ROAD FRONTING THE PROPERTY. NUMBERS SHALL CONTRAST WITH THEIR BACKGROUND. CFC.

CONSTRUCTION SITE FIRE SAFETY:

ALL CONSTRUCTION SITES MUST COMPLY WITH CFC. CHAPTER 33 AND STANDARD DETAIL AND SPECIFICATION SI-7.

### PLANTING AND IRRIGATION SYSTEMS:

BUBBLER IRRIGATION WILL BE USED FOR TREES AND SHRUBS POP-UP SPRINKLER HEADS WILL BE USED TO IRRIGATE THE TURF AREAS. CONCEALED QUICK COUPLER VALVES AND BACK FLOW PREVENTERS COMPLETE THE SYSTEM.

LANDSCAPING WILL BE PRIVATELY MAINTAINED. ALL IRRIGATION PIPING SHALL BE PVC SCHEDULE 40,

### GREEN BUILDING CODE:

CONTRACTOR TO COMPLY WITH CALIFORNIA BUILDING CODE AND REGULATIONS.

### ADDRESS IDENTIFICATION:

INSTALLED AT A DEPTH OF 18" BELOW GRADE.

NEW AND EXISTING BUILDING SHALL HAVE APPROVED ADDRESS NUMBERS, BUILDING NUMBERS OR BUILDING IDENTIFICATION PLACED IN , A POSITION THAT IS PLAINLY LEGIBLE AND VISIBLE FROM THE STREET OR ROAD FRONTING THE PROPERTY. THESE NUMBERS SHALL CONTRAST WITH THEIR BACKGROUND. WHERE REQUIRED BY THE FIRE CODE OFFICIAL, ADDRESS NUMBERS SHALL BE PROVIDED IN ADDITIONAL APPROVED LOCATION TO FACILITATE EMERGENCY RESPONSE. NUMBERS SHALL BE A MINIMUM OF 4 INCHES HIGH WITH A MINIMUM STROKE WIDTH OF 0.5 INCH. ADDRESS NUMBERS SHALL BE MAINTAINED. CFC SEC. 505.1.

### **HAZMAT REVIEW:**

A SEPARATE REVIEW BY HAZMAT DIVISION IS REQUIRED. DETAILED PLANS FOR THE PROPOSED SYSTEM MUST BE SUBMITTED SEPARATELY AND DIRECTLY TO THE OFFICE LOCATED AT 14700 WINCHESTER BLVD. LOS GATOS, CA. ALL PERMITS REQUIRED BY HAZMAT DIVISION MU ST BE OBTAINED PRIOR TO COMMENCING WORK, OR AS INDICATED BY THE HAZMAT REVIEW.

### RESTRICTIONS FOR SALES OF ALCOHOL

- a. NO BEER OR WINE SHALL BE DISPLAYED WITHIN FIVE FEET OF THE CASH REGISTER OR THE FRONT DOOR UNLESS IT IS IN A PERMANENTLY AFFIXED COOLER.
- b. NO ADVERTISEMENT OF ALCOHOLIC BEVERAGES SHALL BE DISPLAYED AT MOTOR FUEL ISLANDS.
- c. NO SALE OF ALCOHOLIC BEVERAGES SHALL BE MADE FROM A DRIVE-IN WINDOW. d. NO DISPLAY OR SALE OF BEER OR WINE SHALL BE MADE FROM AN ICE TUB.
- e. NO BEER OR WINE ADVERTISING SHALL BE LOCATED ON MOTOR FUEL ISLANDS AND NO SELF-ILLUMINATED FOR BEER OR WINE SHALL BE LOCATED ON BUILDINGS OR WINDOWS.
- f. EMPLOYEES ON DUTY BETWEEN THE HOURS OF TEN P.M. AND TWO A.M. WHO SELL BEER OR WINE SHALL BE AT LEAST TWENTY-ONE YEARS OF AGE.

### **ARCHITECTURAL**

A.1.0EXISTING/ DEMO. SITE PLAN PROPOSED SITE PLAN

A.2.0

A.3.0PROPOSED FLOOR PLAN, ENLARGED TOILET PLAN, DETAILS

A.5.0FLOOR AREA DIAGRAM

BUILDING ELEVATIONS, DOOR & WINDOW ELEVATIONS

A.9.0

LINE OF SITE COLOR AND MATERIAL A.10.0

### LANDSCAPING

LANDSCAPE PLAN

FUTURE CONCEPTUAL SITE PLAN

T.1 **SURVEY** C-1

**DETAILS** C-3

**COVER SHEET** 

SHEET INDEX

FUTURE CONCEPTUAL INTERSECTION LAYOUT

A.4.0TRASH ENCLOSURE, CANOPY ELEVATIONS

A.6.0ROOF PLAN, DETAILS

BUILDING SECTIONS, TRASH ENCLOSURE SECTION

A.11.0 **RENDERING-3D** 

### CIVIL

**COVER SHEET** C-2 GRADING & DRAINAGE PLAN


C-4

STORM WATER CONTROL PLAN/ MEASURES STORM WATER CONTROL MEASURES/ DETAILS

EROSION CONTROL PLAN

# PROJECT LOCATION

INCLUDING, BUT NOT LIMITED TO, FIRE AND ZONING.

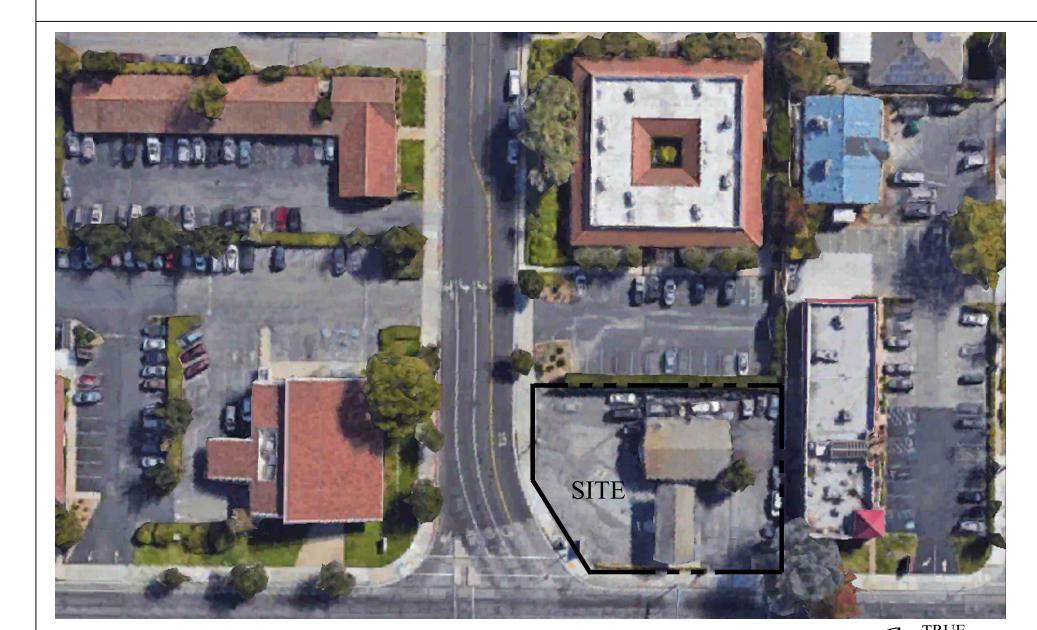


VICINITY MAP



Tel:(408) 316.6168


E-Mail:agp@pacbell.net

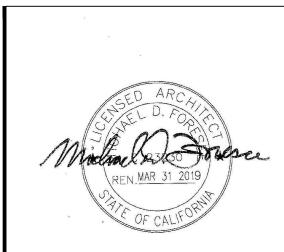

REVISIONS NO. ITEM DATE Planning Submittal Planning Submittal 12/11/17 1/18/18 Planning Comments

Planning Submittal

DRAWN BY: CHECKED BY: DATE: PROJECT NO: 2016.01 SCALE: AS SHOWN 08-18-2016

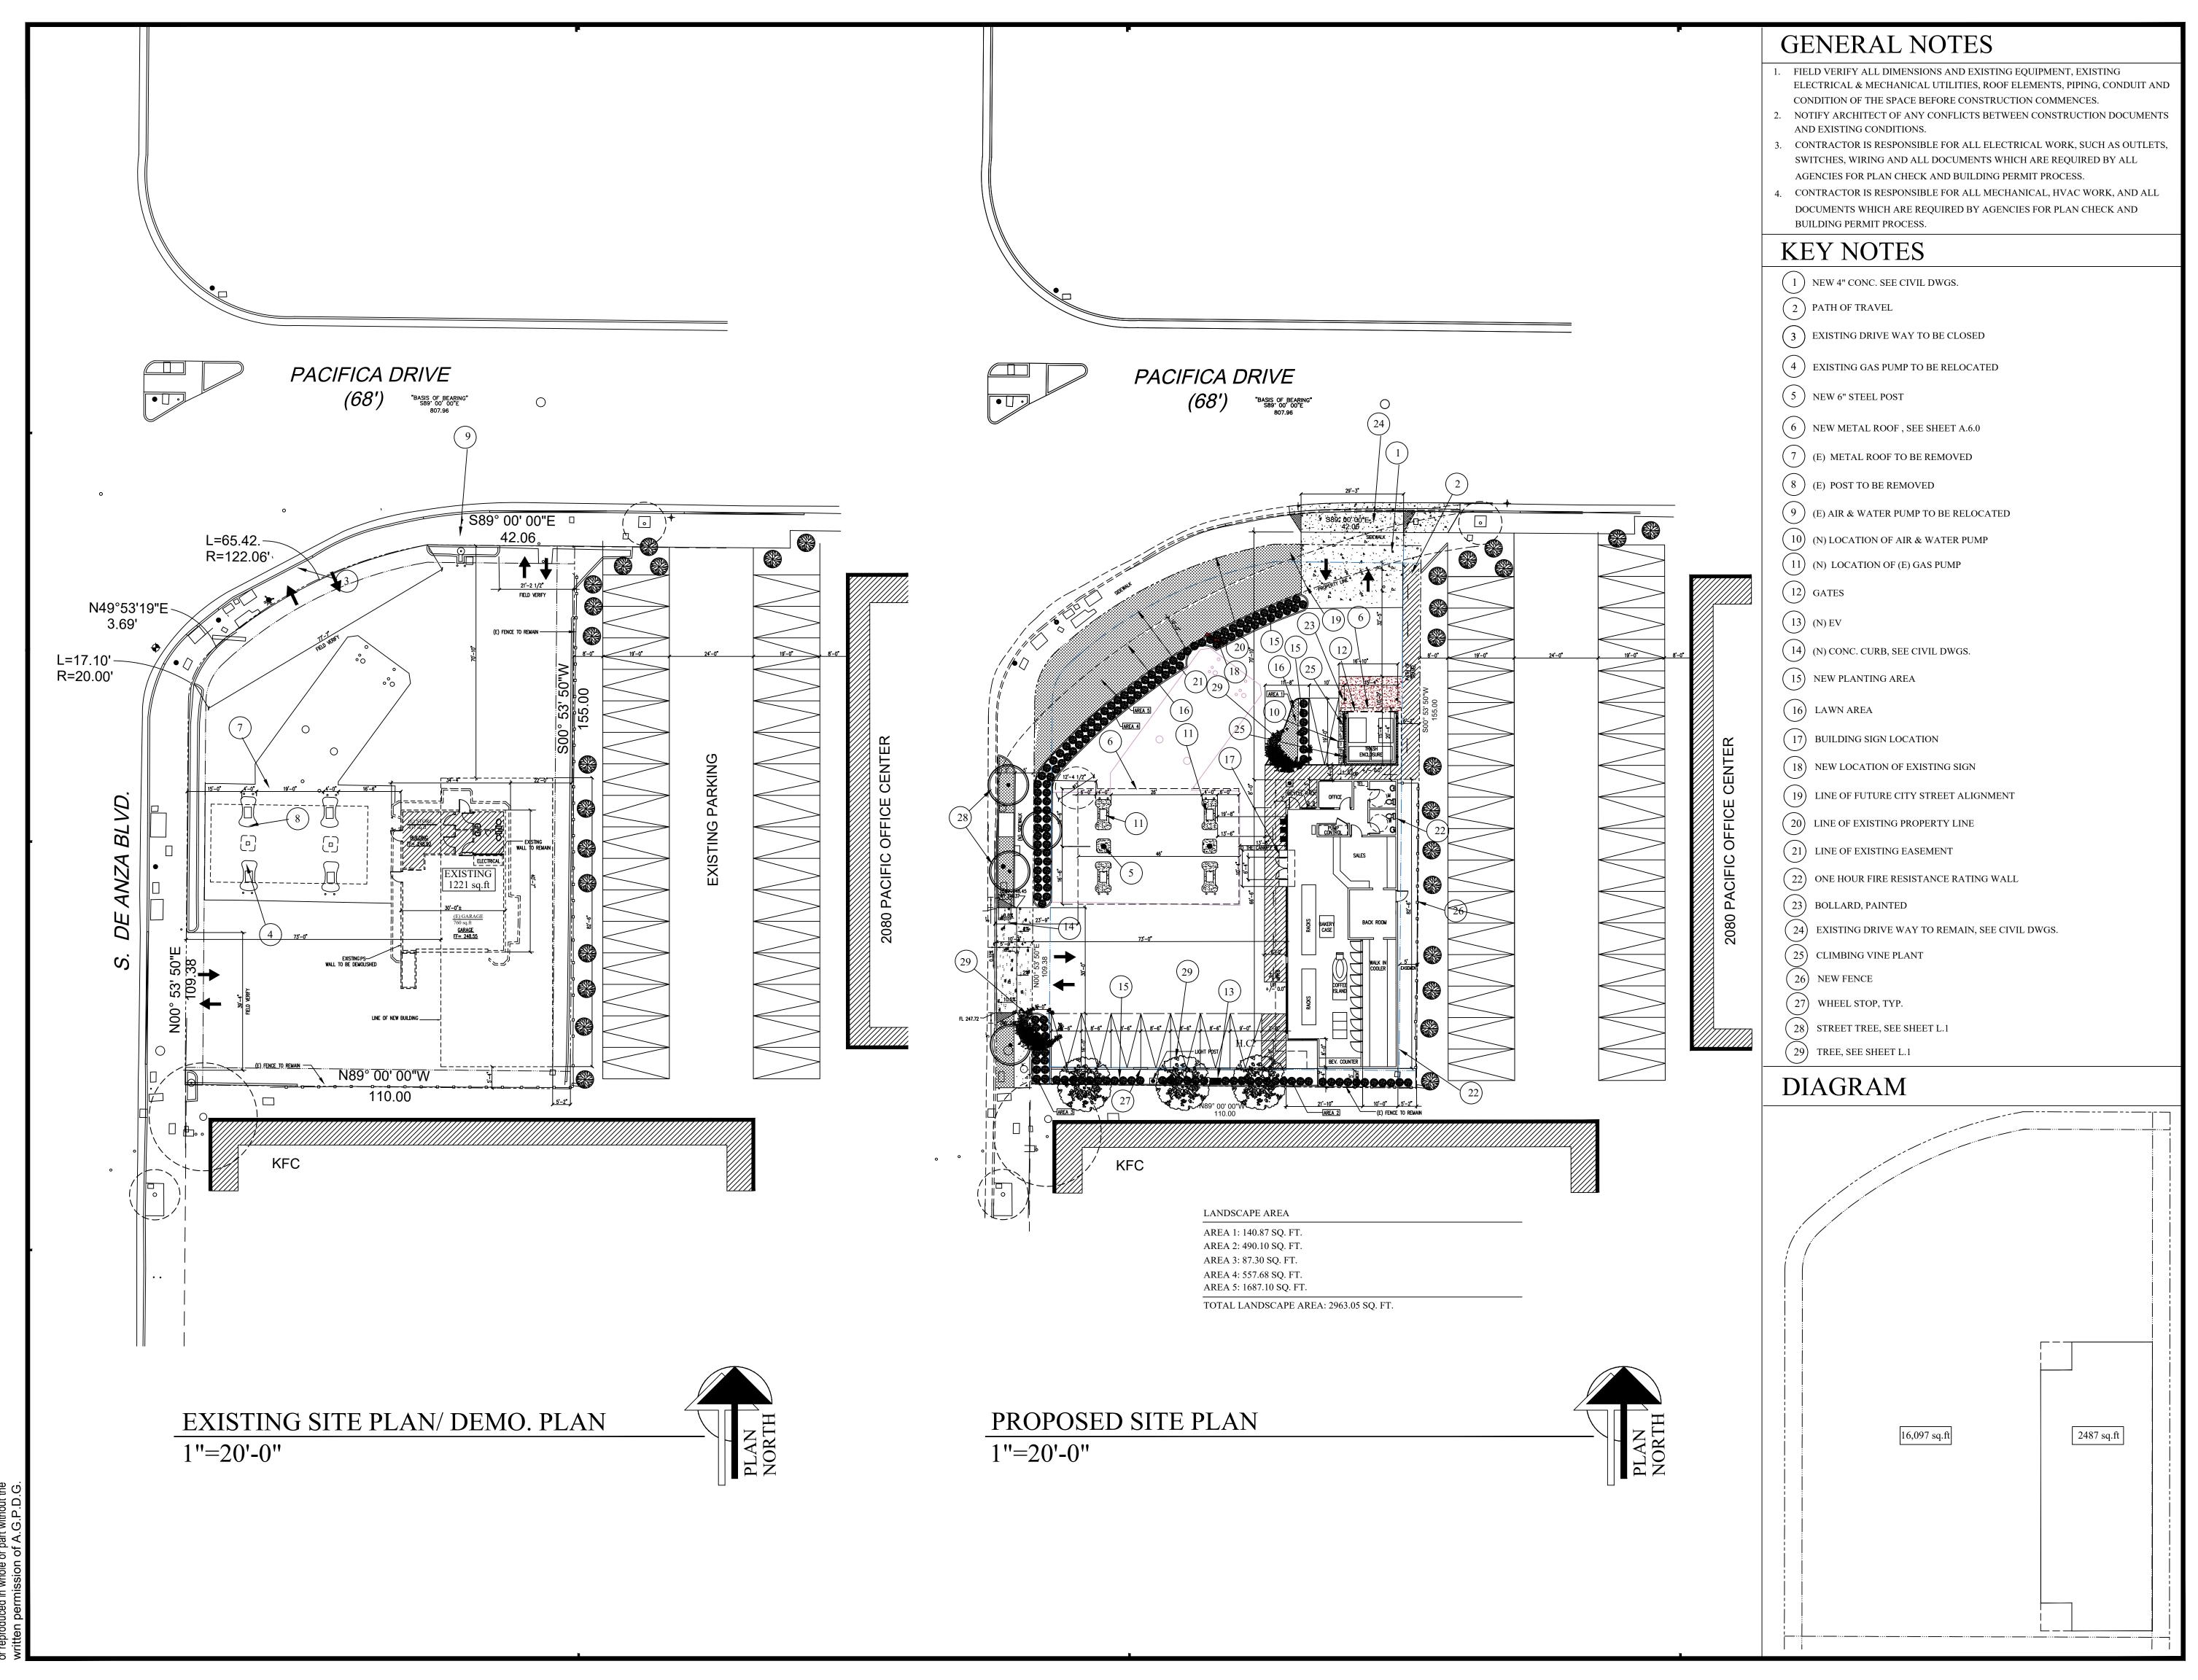

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490 S. DE ANZA BLV

REVISIONS
NO. ITEM DATE

Planning Submittal 9/6/16

Planning Review 2/21/17

Planning Submittal 10/04/17

Planning Submittal 12/11/17

3/7/18

PLOT SCALE: 12"=1'-0"

DRAWN BY: AK


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PROJECT NO: DATE:

SCALE: AS SHOWN 07-6-16

Planning Submittal


A.1.0

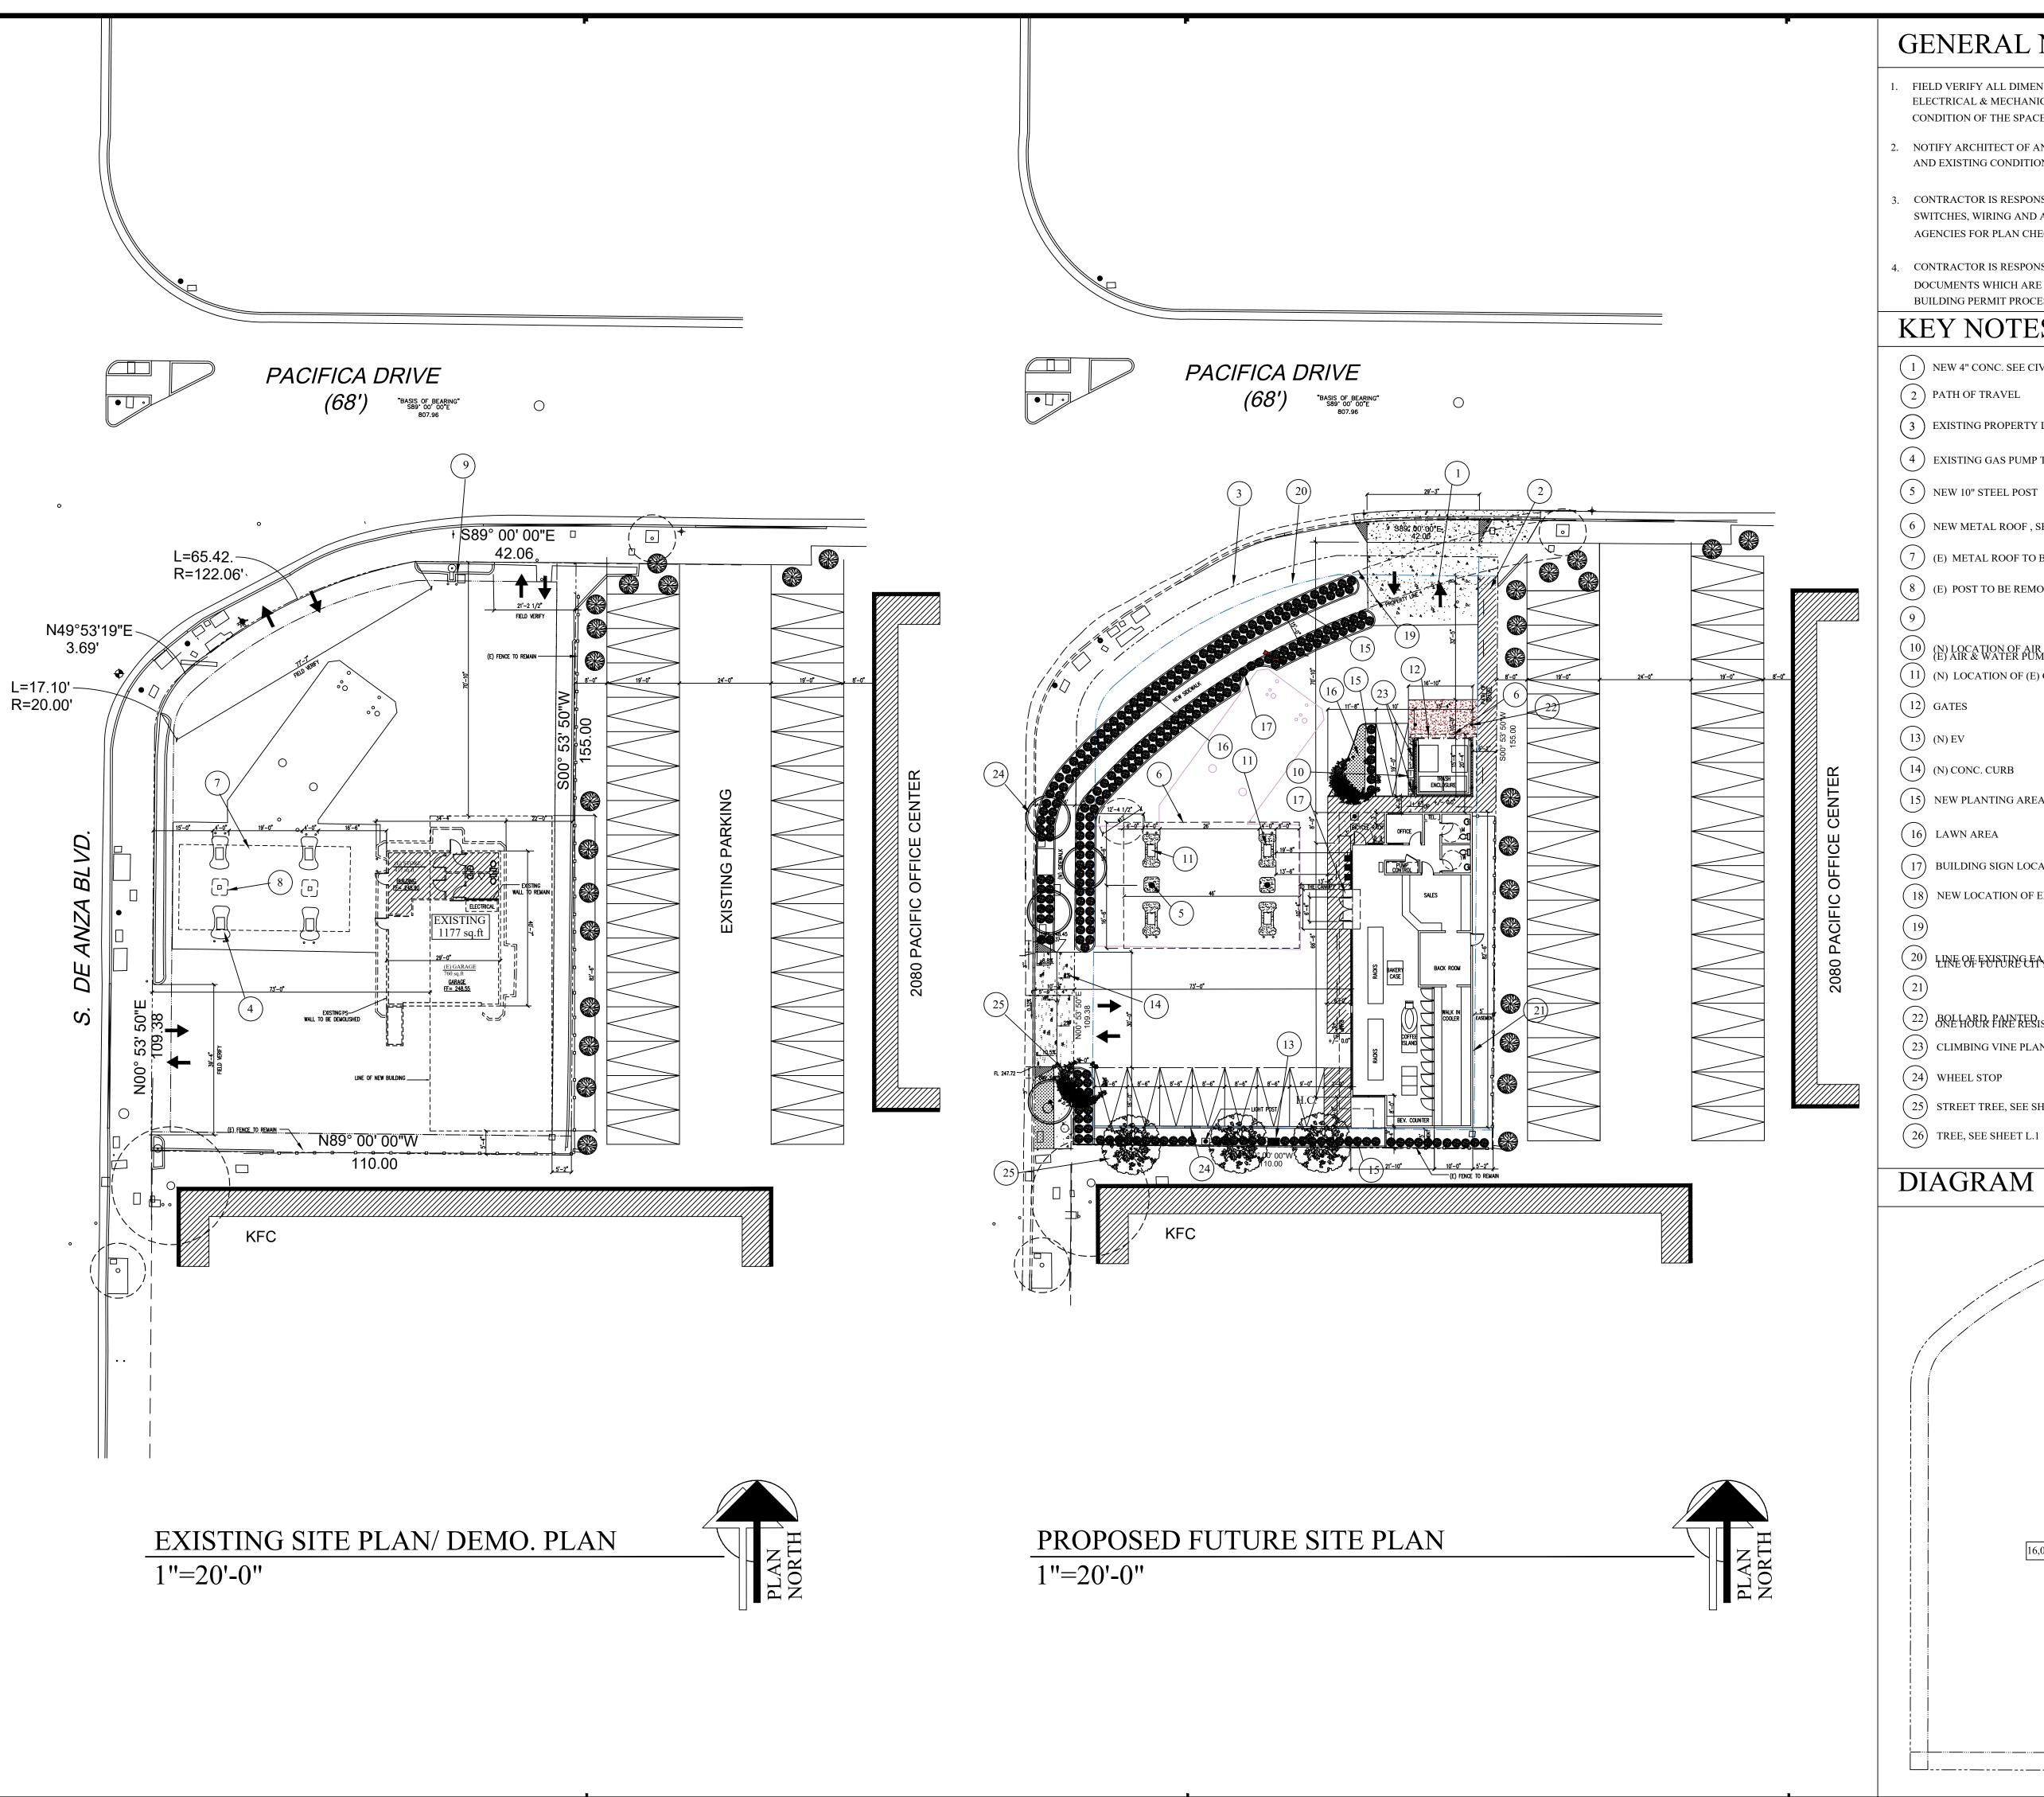

- 1. FIELD VERIFY ALL DIMENSIONS AND EXISTING EQUIPMENT, EXISTING ELECTRICAL & MECHANICAL UTILITIES, ROOF ELEMENTS, PIPING, CONDUIT AND CONDITION OF THE SPACE BEFORE CONSTRUCTION COMMENCES.
- 2. NOTIFY ARCHITECT OF ANY CONFLICTS BETWEEN CONSTRUCTION DOCUMENTS AND EXISTING CONDITIONS.
- 3. CONTRACTOR IS RESPONSIBLE FOR ALL ELECTRICAL WORK, SUCH AS OUTLETS, SWITCHES, WIRING AND ALL DOCUMENTS WHICH ARE REQUIRED BY ALL AGENCIES FOR PLAN CHECK AND BUILDING PERMIT PROCESS.
- 4. CONTRACTOR IS RESPONSIBLE FOR ALL MECHANICAL, HVAC WORK, AND ALL DOCUMENTS WHICH ARE REQUIRED BY AGENCIES FOR PLAN CHECK AND BUILDING PERMIT PROCESS.

### KEY NOTES


- 1 NEW 4" CONC. SEE CIVIL DWGS.
- 3 EXISTING PROPERTY LINE
- (4) EXISTING GAS PUMP TO BE RELOCATED
- (5) NEW 10" STEEL POST
- (6) NEW METAL ROOF, SEE SHEET A2.1
- (7) (E) METAL ROOF TO BE REMOVED
- (8) (E) POST TO BE REMOVED
- (N) LOCATION OF AIR & WATER PUMP (E) AIR & WATER PUMP TO BE RELOCATED
- (11) (N) LOCATION OF (E) GAS PUMP
- (14) (N) CONC. CURB
- 15) NEW PLANTING AREA
- (17) BUILDING SIGN LOCATION
- (18) NEW LOCATION OF EXISTING SIGN
- 20 LINE OF EXISTING EASEMENT ALIGNMENT
- 22) BOLLARD, PAINTED ONE HOUR FIRE RESISTANCE RATING WALL
- (23) CLIMBING VINE PLANT
- 25) STREET TREE, SEE SHEET L.1

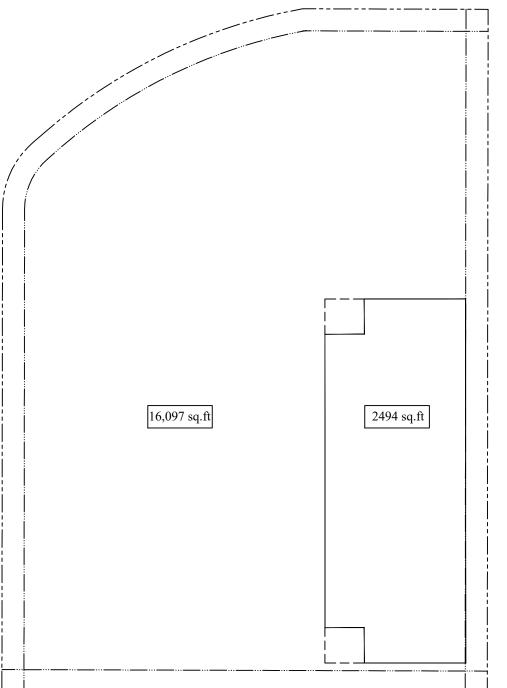




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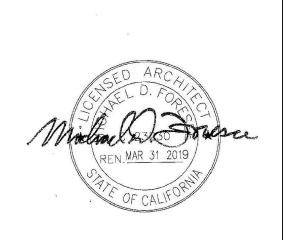
REVISIONS NO. ITEM Planning Submittal 9/6/16 Planning Review 10/04/17 Planning Submittal

DRAWN BY: CHECKED BY: PROJECT NO: SCALE: AS SHOWN

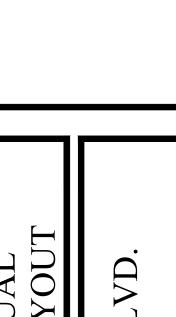

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PLAN I, DETAILS LVD.

ENLARGED TOILET PLAN, DE 10490 S. DE ANZA BLVD.

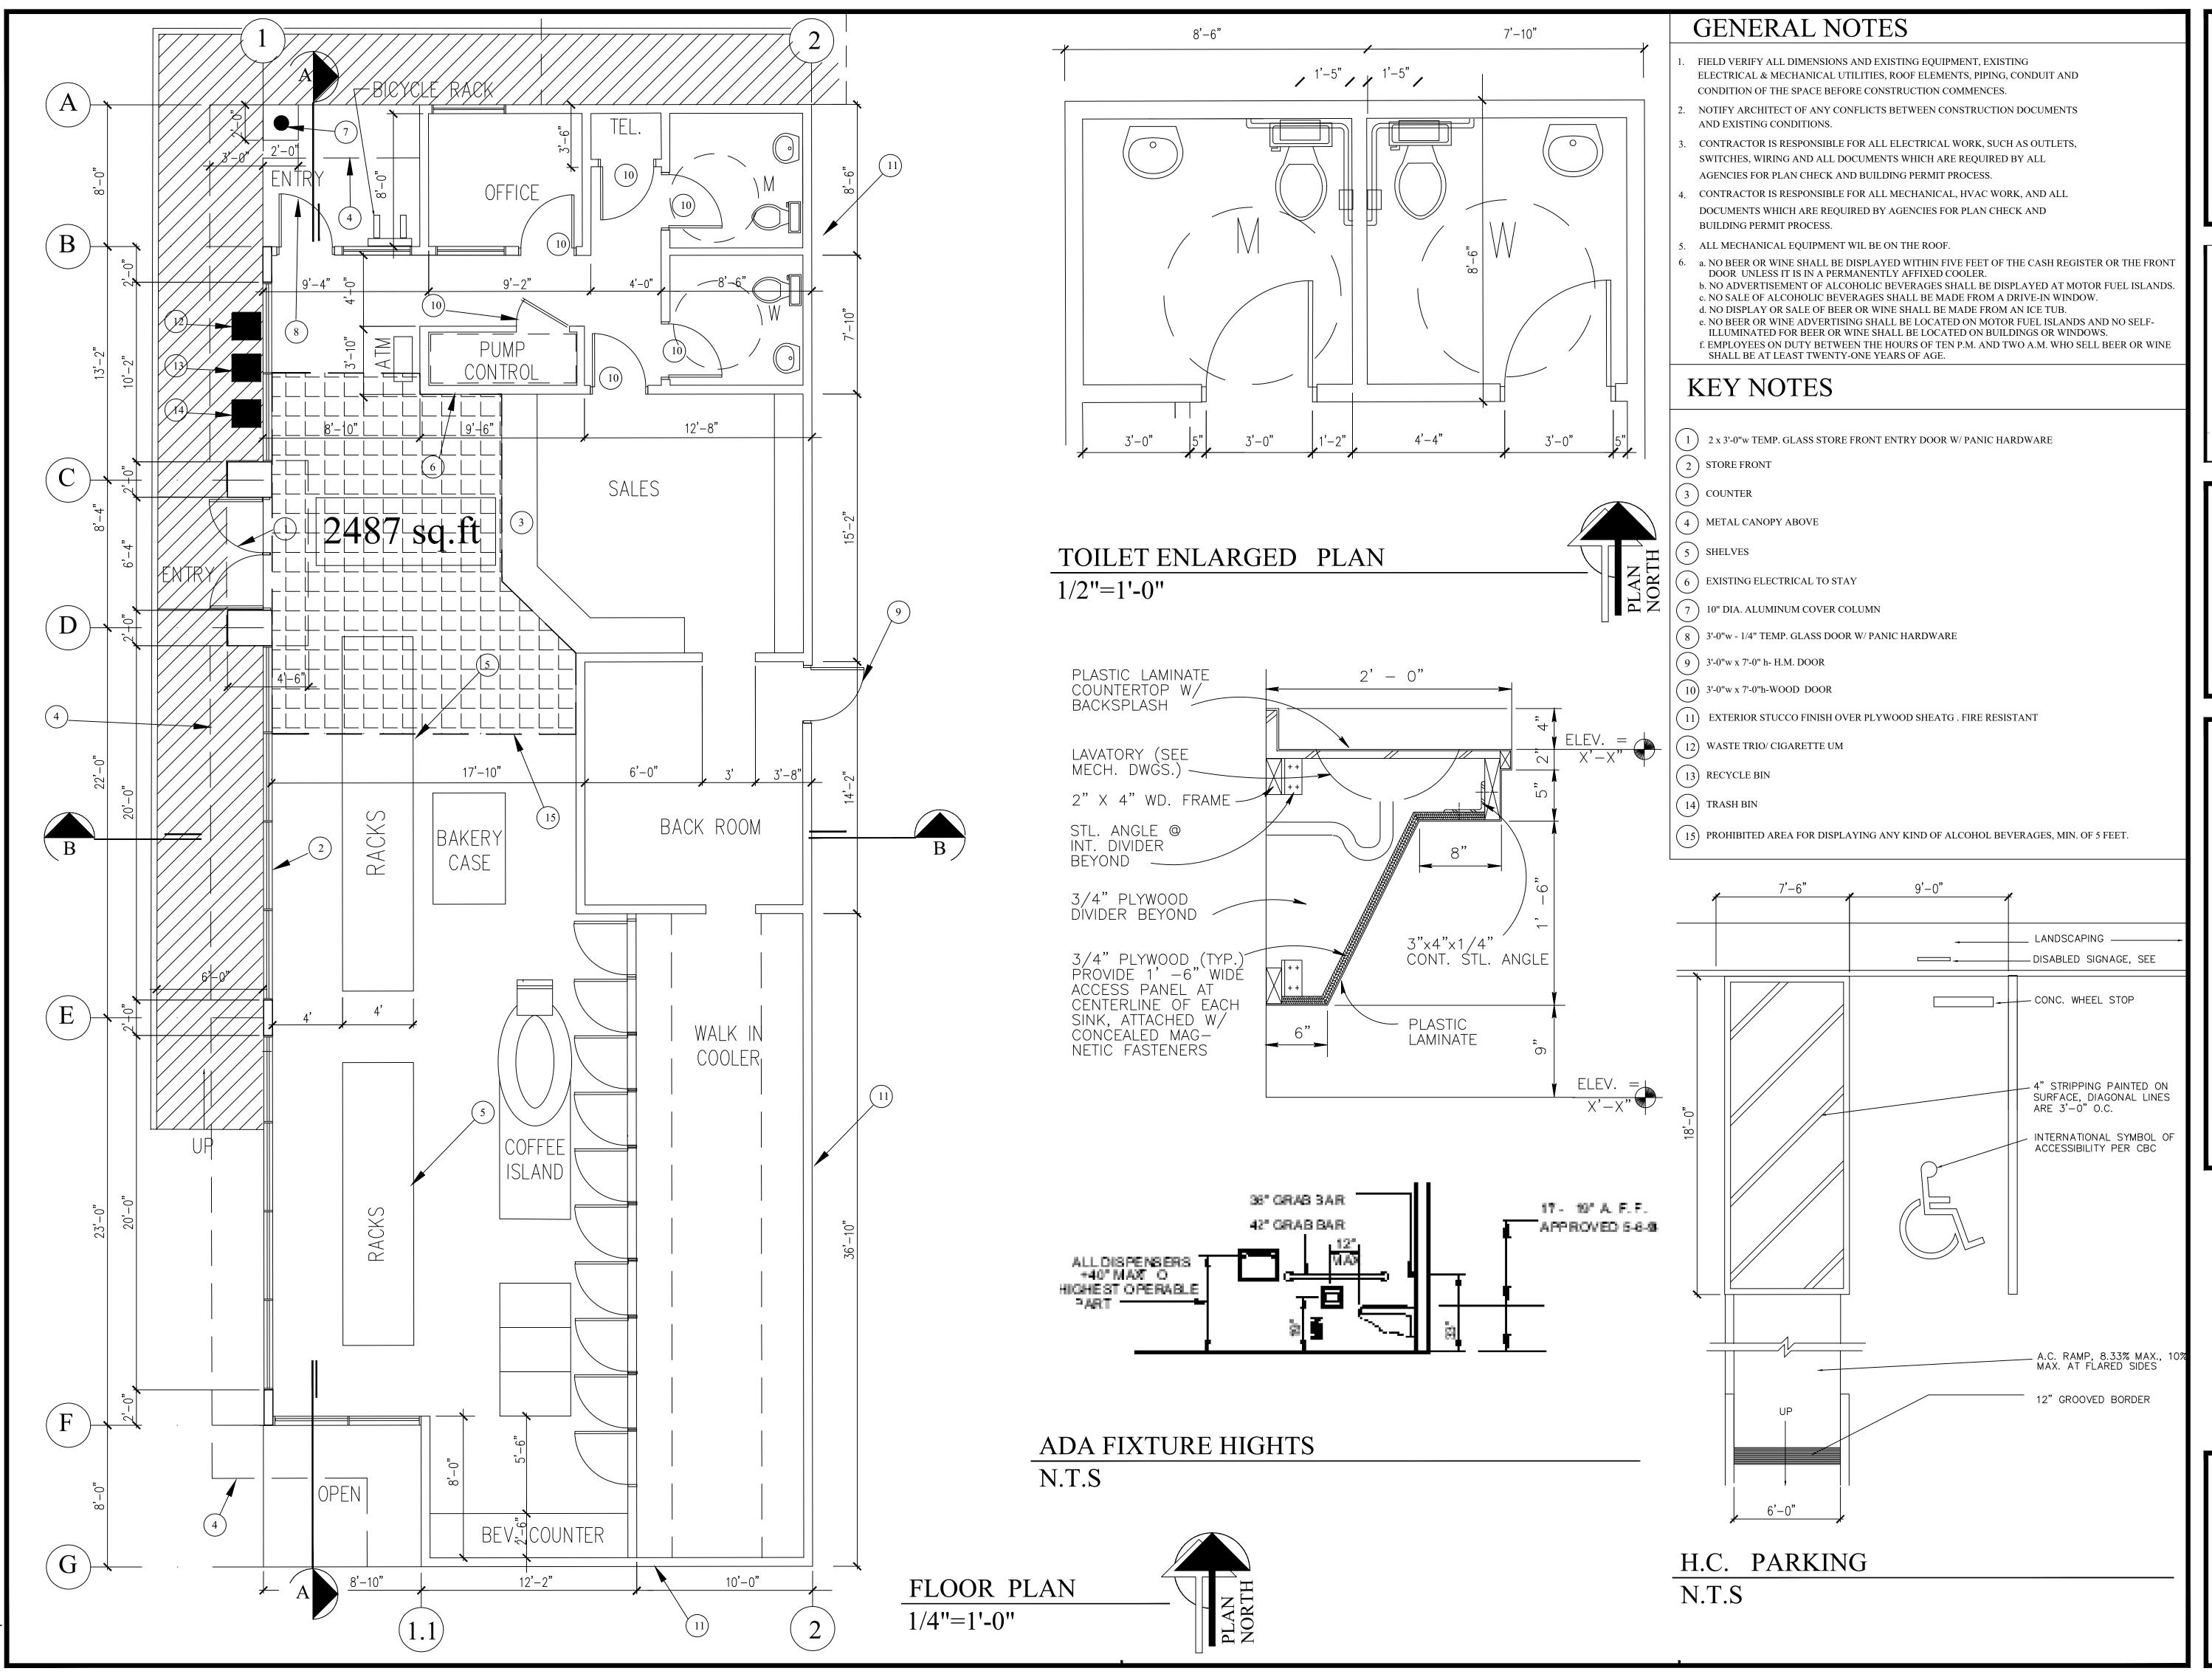REVISIONS
NO. ITEM DATE

Planning Submittal 9/6/16

Planning Submittal 12/11/17

Planning Comments 1/18/18

Planning Submittal 3/7/18

PLOT SCALE: 12"=1'-0"


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SCALE: AS SHOWN 07-6-16

A.3.0




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- ALL MECHANICAL EQUIPMENT WIL BE ON THE ROOF.
- TRASH ENCLOSURE IS TYPE I CONSTRUCTION AND FULLY FIRE SPRINKLERED.


### KEY NOTES

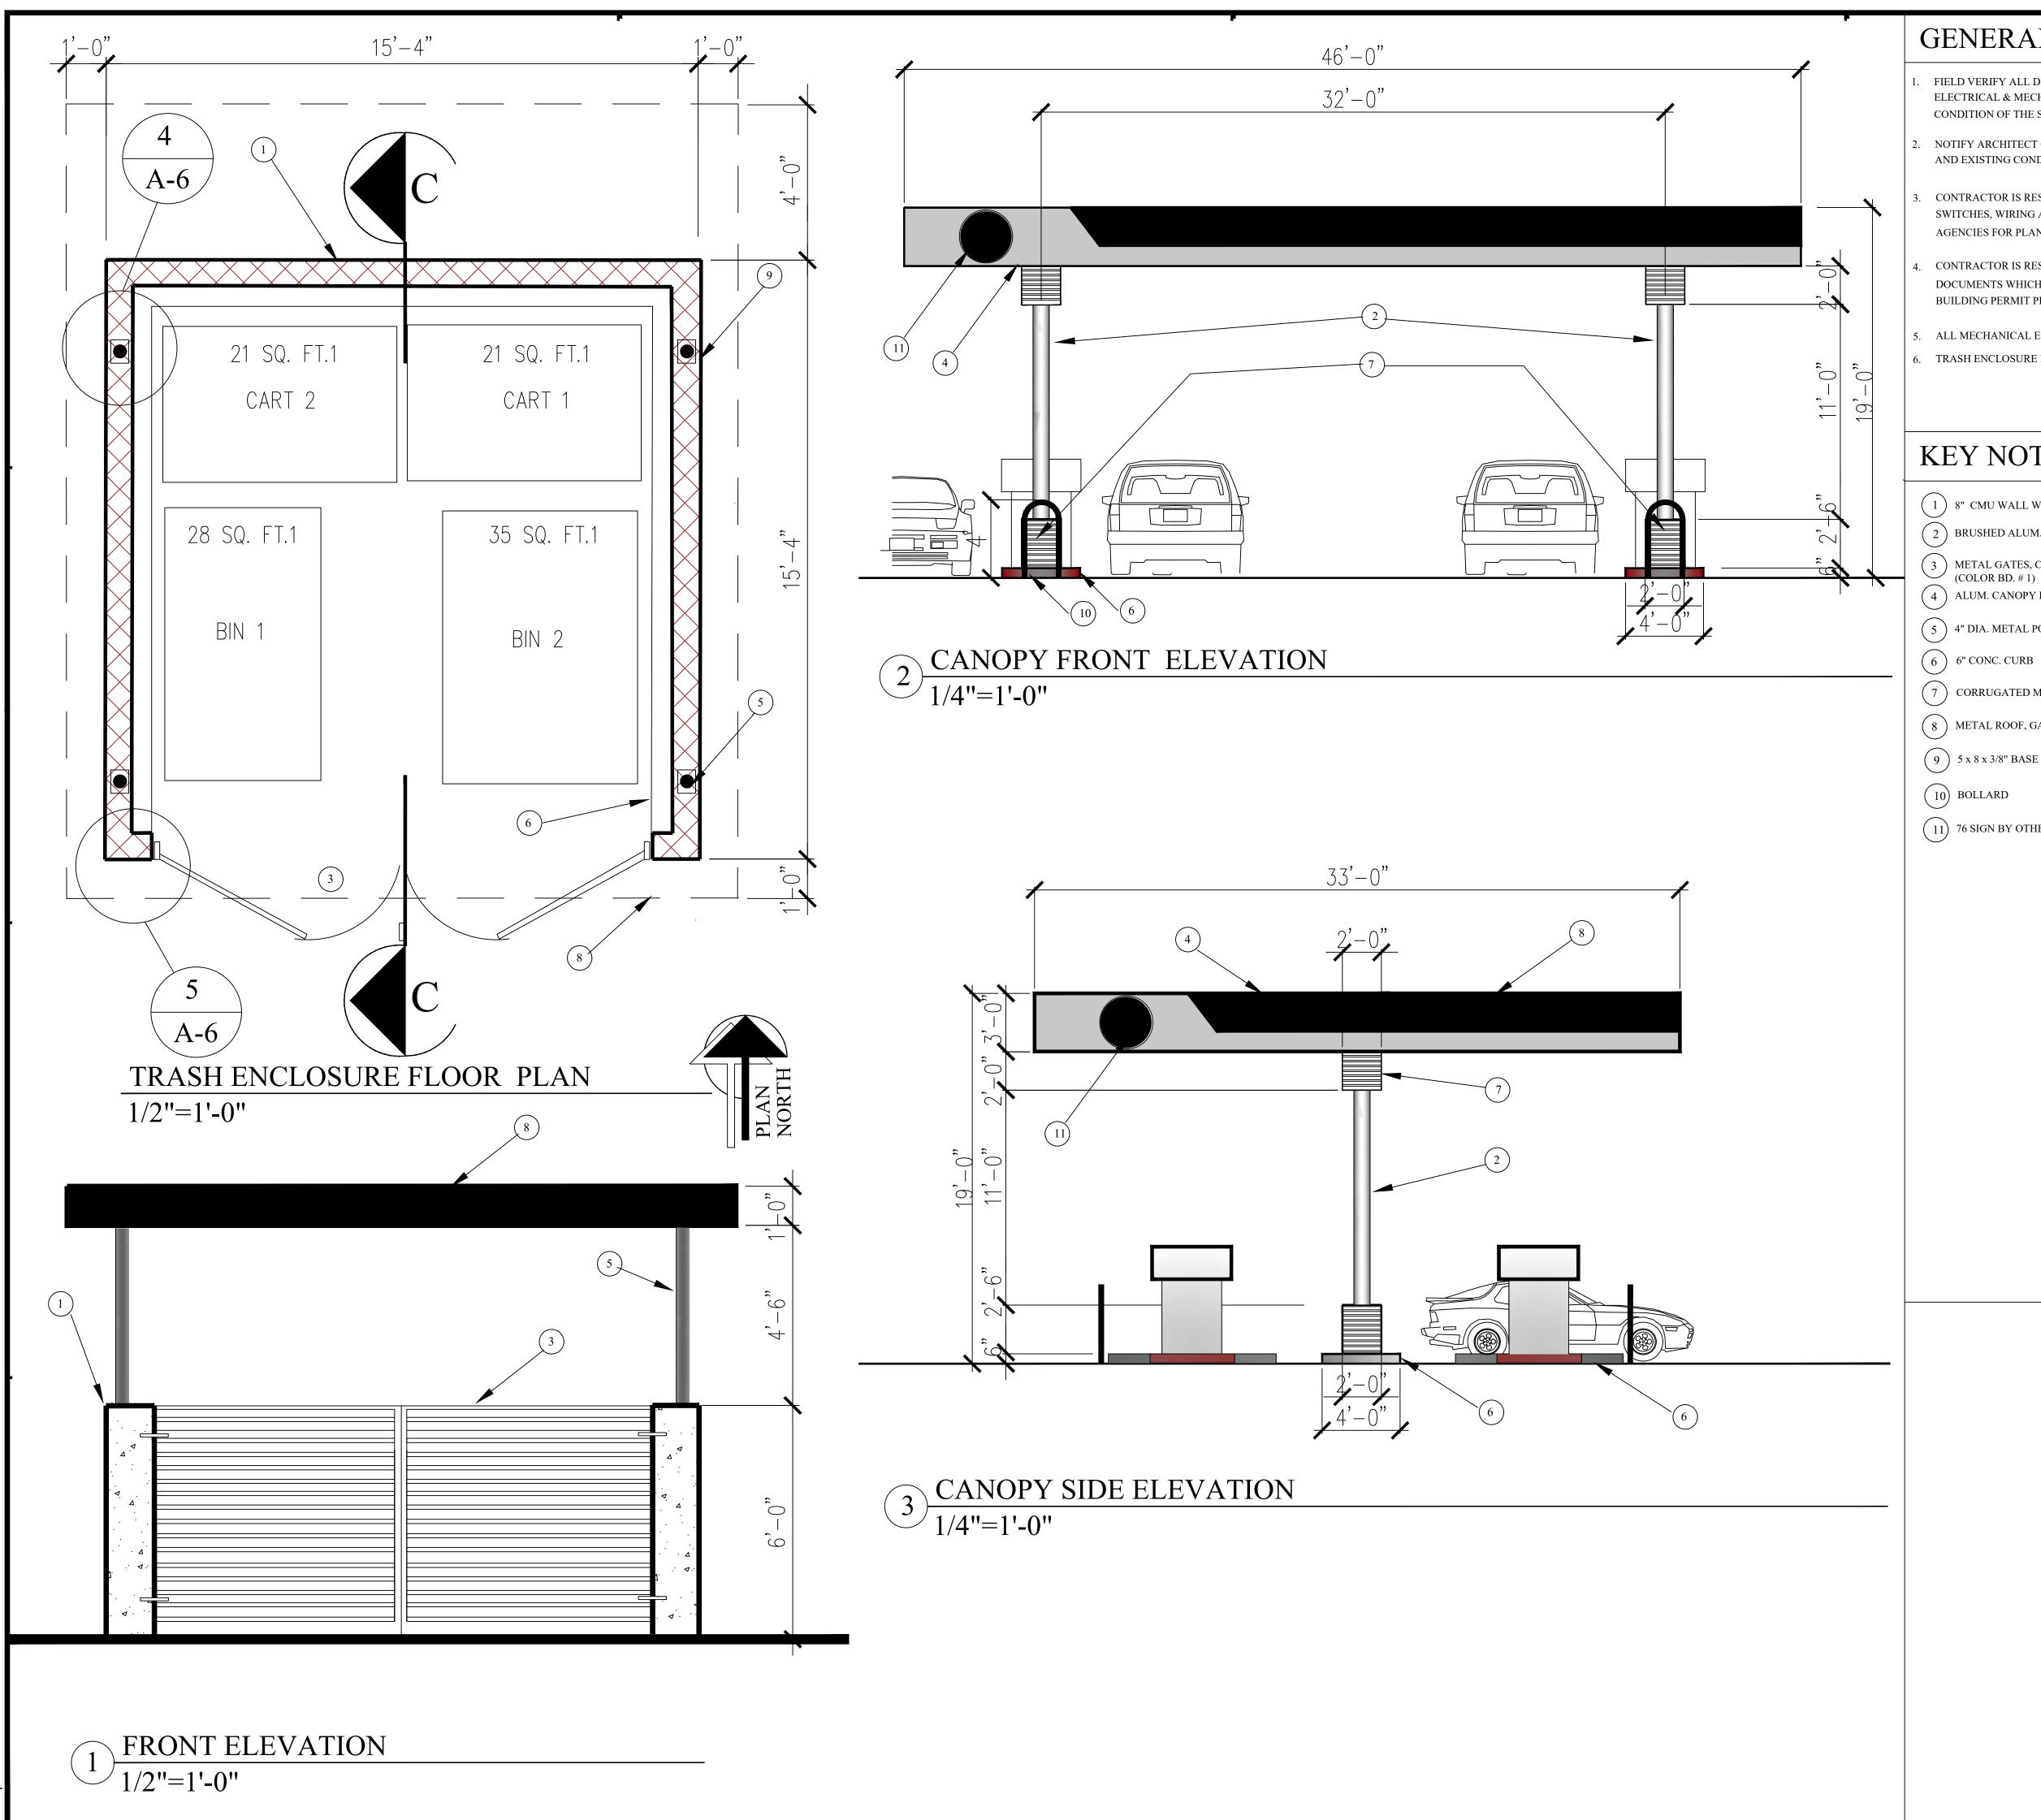- ( 1 ) 8" CMU WALL WITH PLASTER CEMENT FINISH, COLOR TO MATCH BUILDING
- 2 BRUSHED ALUM. COVERED OVER 10" DIA. STEEL COL. (COLOR BD. # 10)
- 3 METAL GATES, CORRUGATED METAL PANEL, SILVER SMITH SR1: 51 BY ATAS
- 4 ALUM. CANOPY FASCIA, DESIGN PER PETROLEUM'S COOPERATE SPEC. (BY OTHERS)
- (5) 4" DIA. METAL POST WARPED WITH BRUSHED ALUM TO MATCH BUILDING COL.
- (7) CORRUGATED METAL PANEL, SILVER SMITH SR1: 51 BY ATAS (COLOR BD. # 1)
- 8 METAL ROOF, GALVANIZED SILVER, BY AEP SPAN
- 9 5 x 8 x 3/8" BASE PLATE
- (11) 76 SIGN BY OTHERS

Design Group

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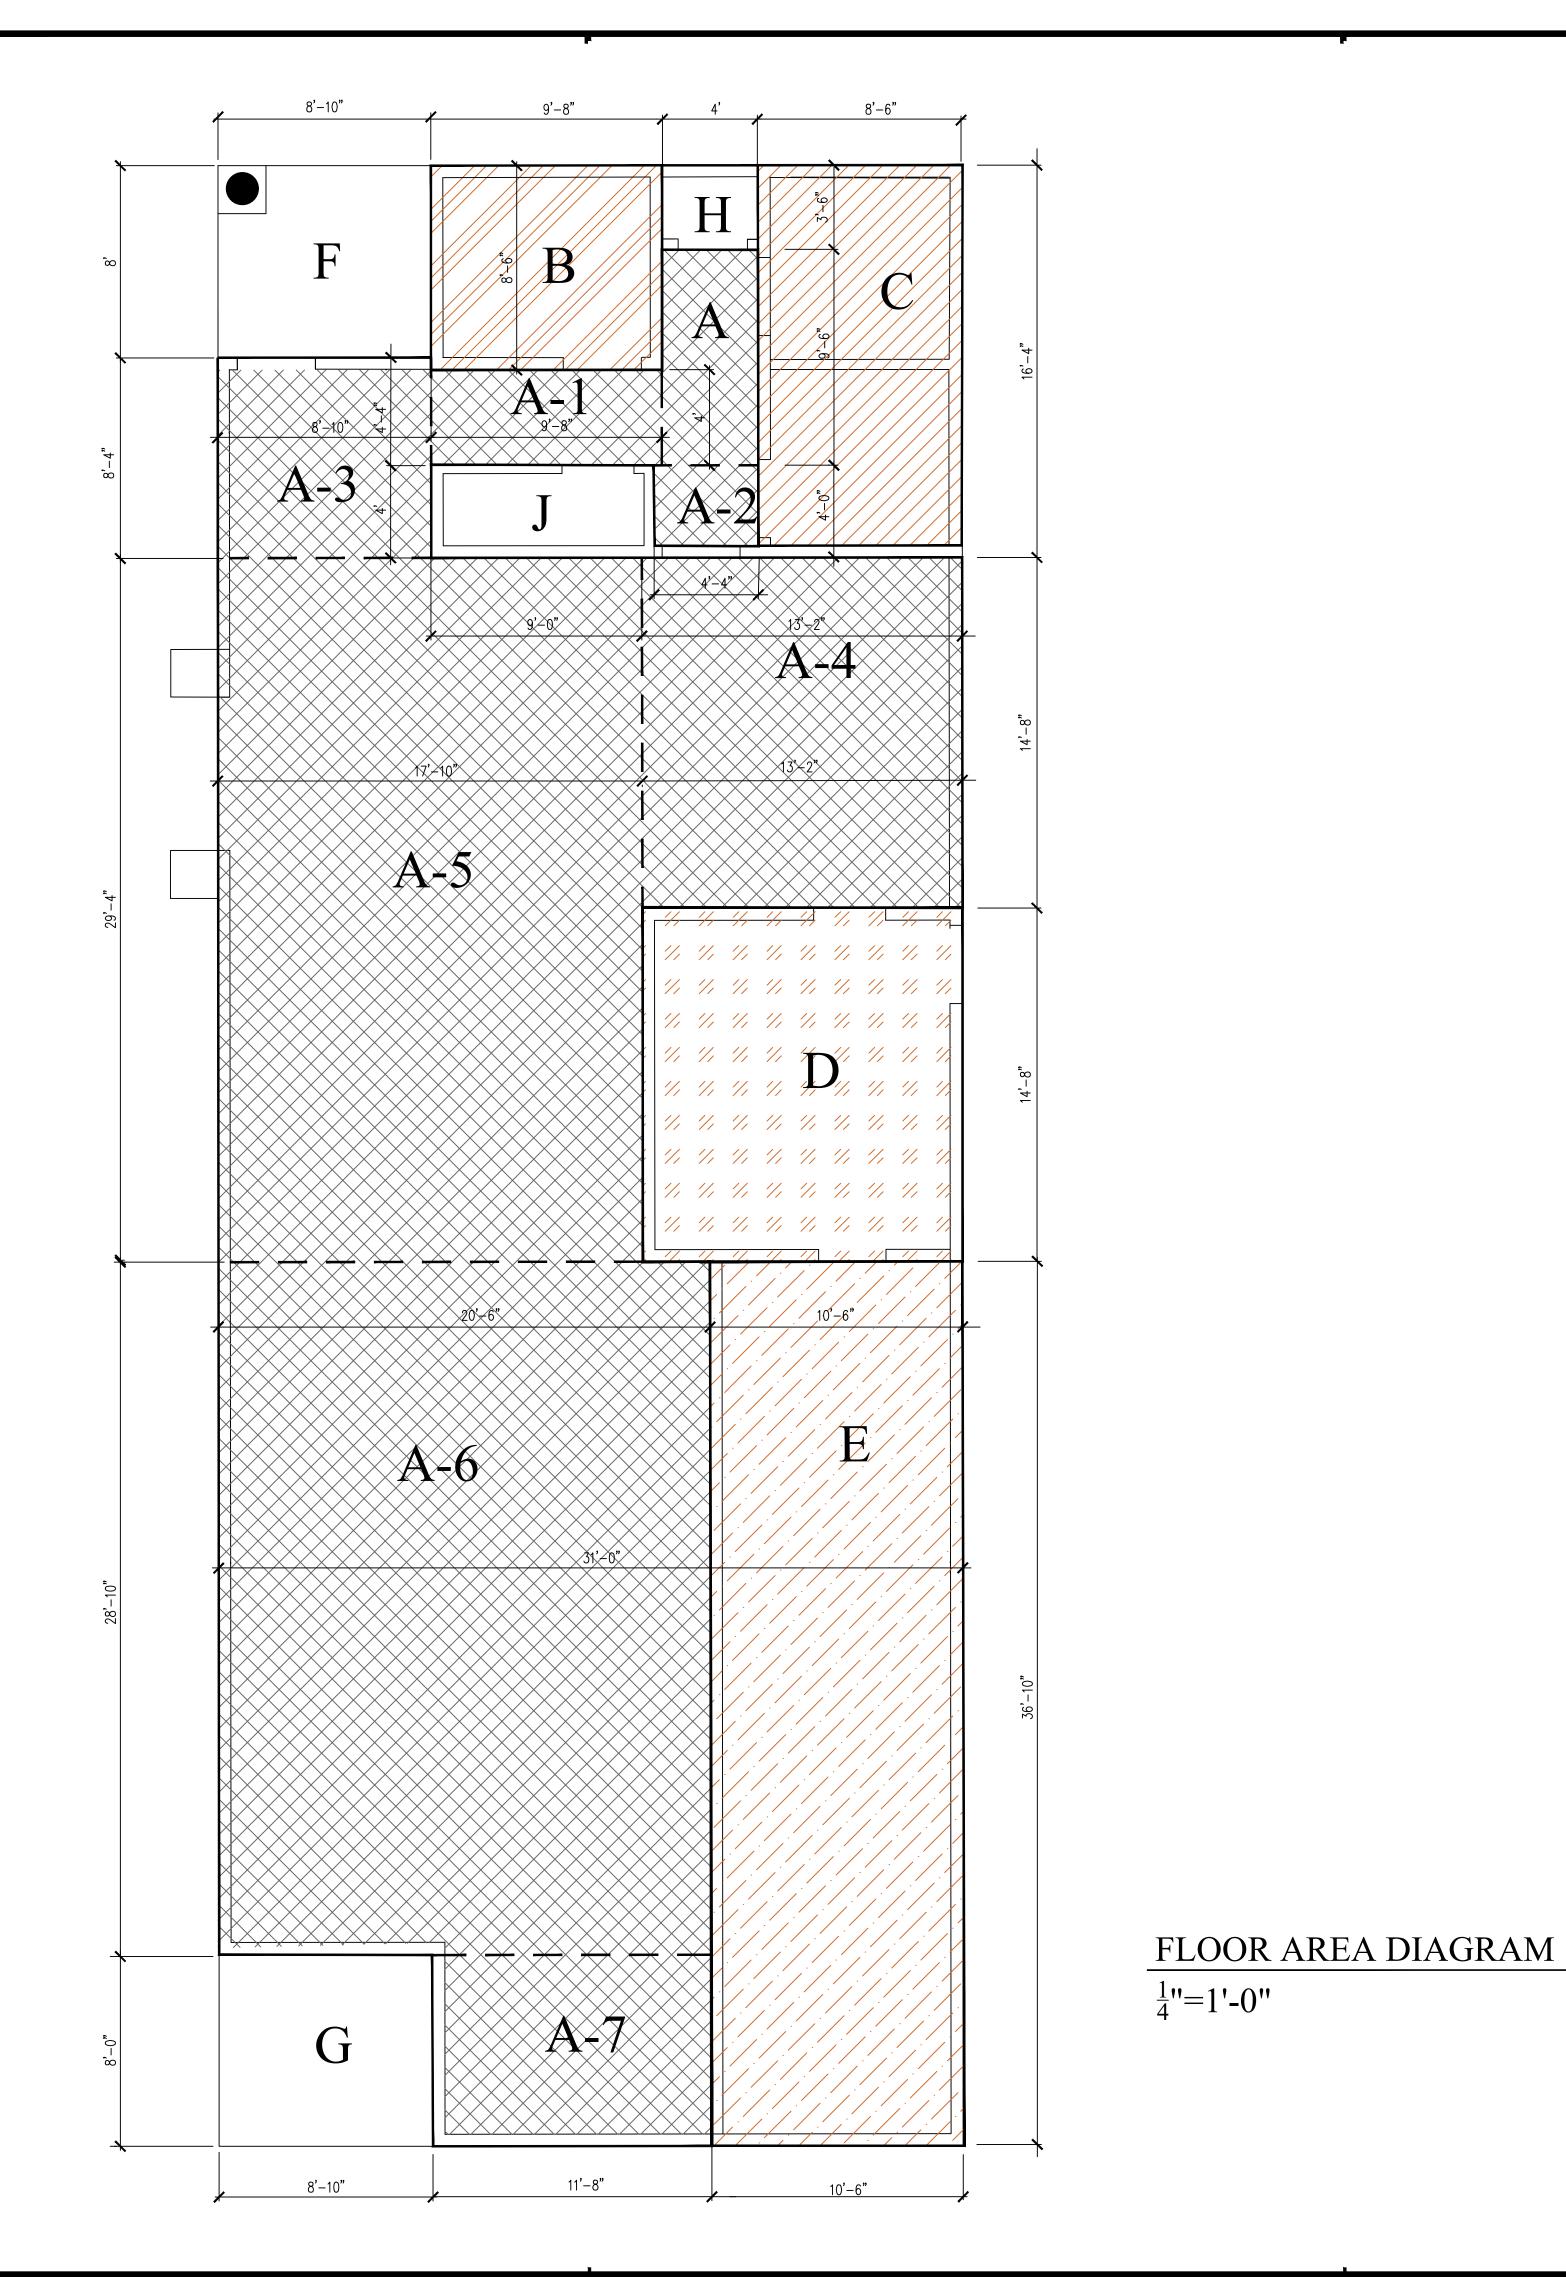


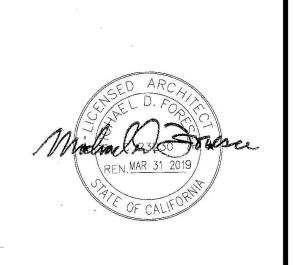

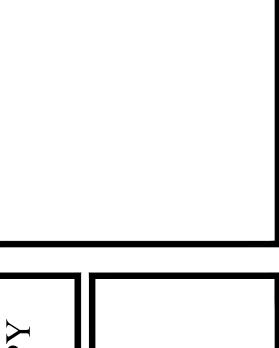NO. ITEM 12/11/17

3/7/18

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- 1. FIELD VERIFY ALL DIMENSIONS AND EXISTING EQUIPMENT, EXISTING ELECTRICAL & MECHANICAL UTILITIES, ROOF ELEMENTS, PIPING, CONDUIT AND CONDITION OF THE SPACE BEFORE CONSTRUCTION COMMENCES.
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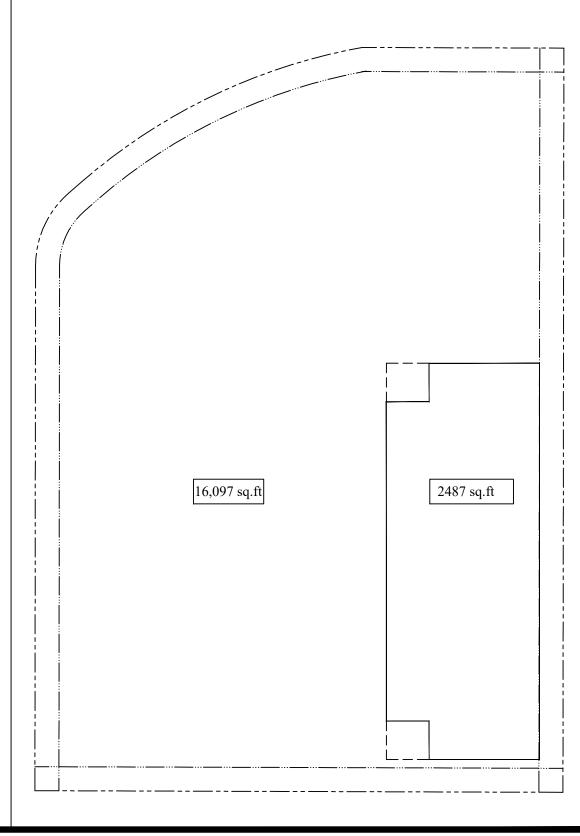
### KEY NOTES

- A:  $(4' \times 9'-6'') = 38 \text{ Sq. Ft.}$
- $A-1:(4' \times 9'-8'') = 38.66 \text{ Sq. Ft.}$
- A-2:(4'-4" x 4'-0") =17.33 Sq. Ft.
- A-3: $(8'-10" \times 8'-4") = 73.61 \text{ Sq. Ft.}$ A-4:(13'-2 "x 14'-8") = 193.11 Sq. Ft.
- A-5: $(17'-10'' \times 29'-4'') = 523.11 \text{ Sq. Ft.}$
- $A-6:(20'-6" \times 28'-10") = 591.08 \text{ Sq. Ft.}$ A-7: $(11'-8" \times 8'-0") = 93.33 \text{ Sq. Ft.}$
- B:  $(8'-6" \times 9'-8") = 82.16$ Sq. Ft.
- C:  $(16"-4" \times 8'-6") = 138.83 \text{ Sq. Ft.}$
- D:  $(13'-2" \times 14'-8") = 193.11 \text{ Sq. Ft.}$
- E:  $(36'-10'' \times 10'-6'') = 386.75 \text{ Sq. Ft.}$
- F:  $(8'-10" \times 8'-0") = 70.66 \text{ Sq. Ft. (OPEN SPACE)}$
- G:  $(8'-10" \times 8'-0") = 70.66 \text{ Sq. Ft. (OPEN SPACE)}$
- H:  $(3' 6'' \times 4' 0'') = 14 \text{ Sq. Ft.}$
- J:  $(4'-0" \times 9'-0") = 36 \text{ Sq. Ft.}$

TOTAL FLOOR AREA SQ. FT.: 2419.08

TOTAL BUILDING SQ. FT.: 2487.00

# DIAGRAM







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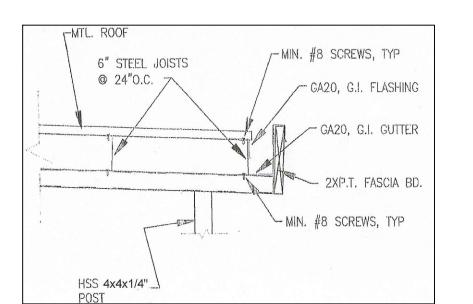
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- DOCUMENTS WHICH ARE REQUIRED BY AGENCIES FOR PLAN CHECK AND BUILDING PERMIT PROCESS.


### KEY NOTES

- 1 FLAT ROOF
- 2 MECHANICAL EQUIPMENT LOCATION
- (3) METAL PANEL SCREEN
- (4) FLAT OVERHANG BELOW, SEE ELEVATION FOR LOCATION
- 5 NEW LOCATION OF (E) SIGN

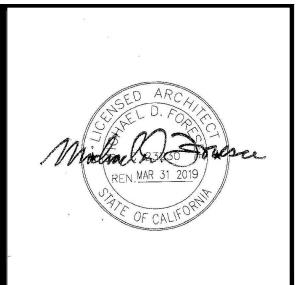


**ENLARGED SECTION** 

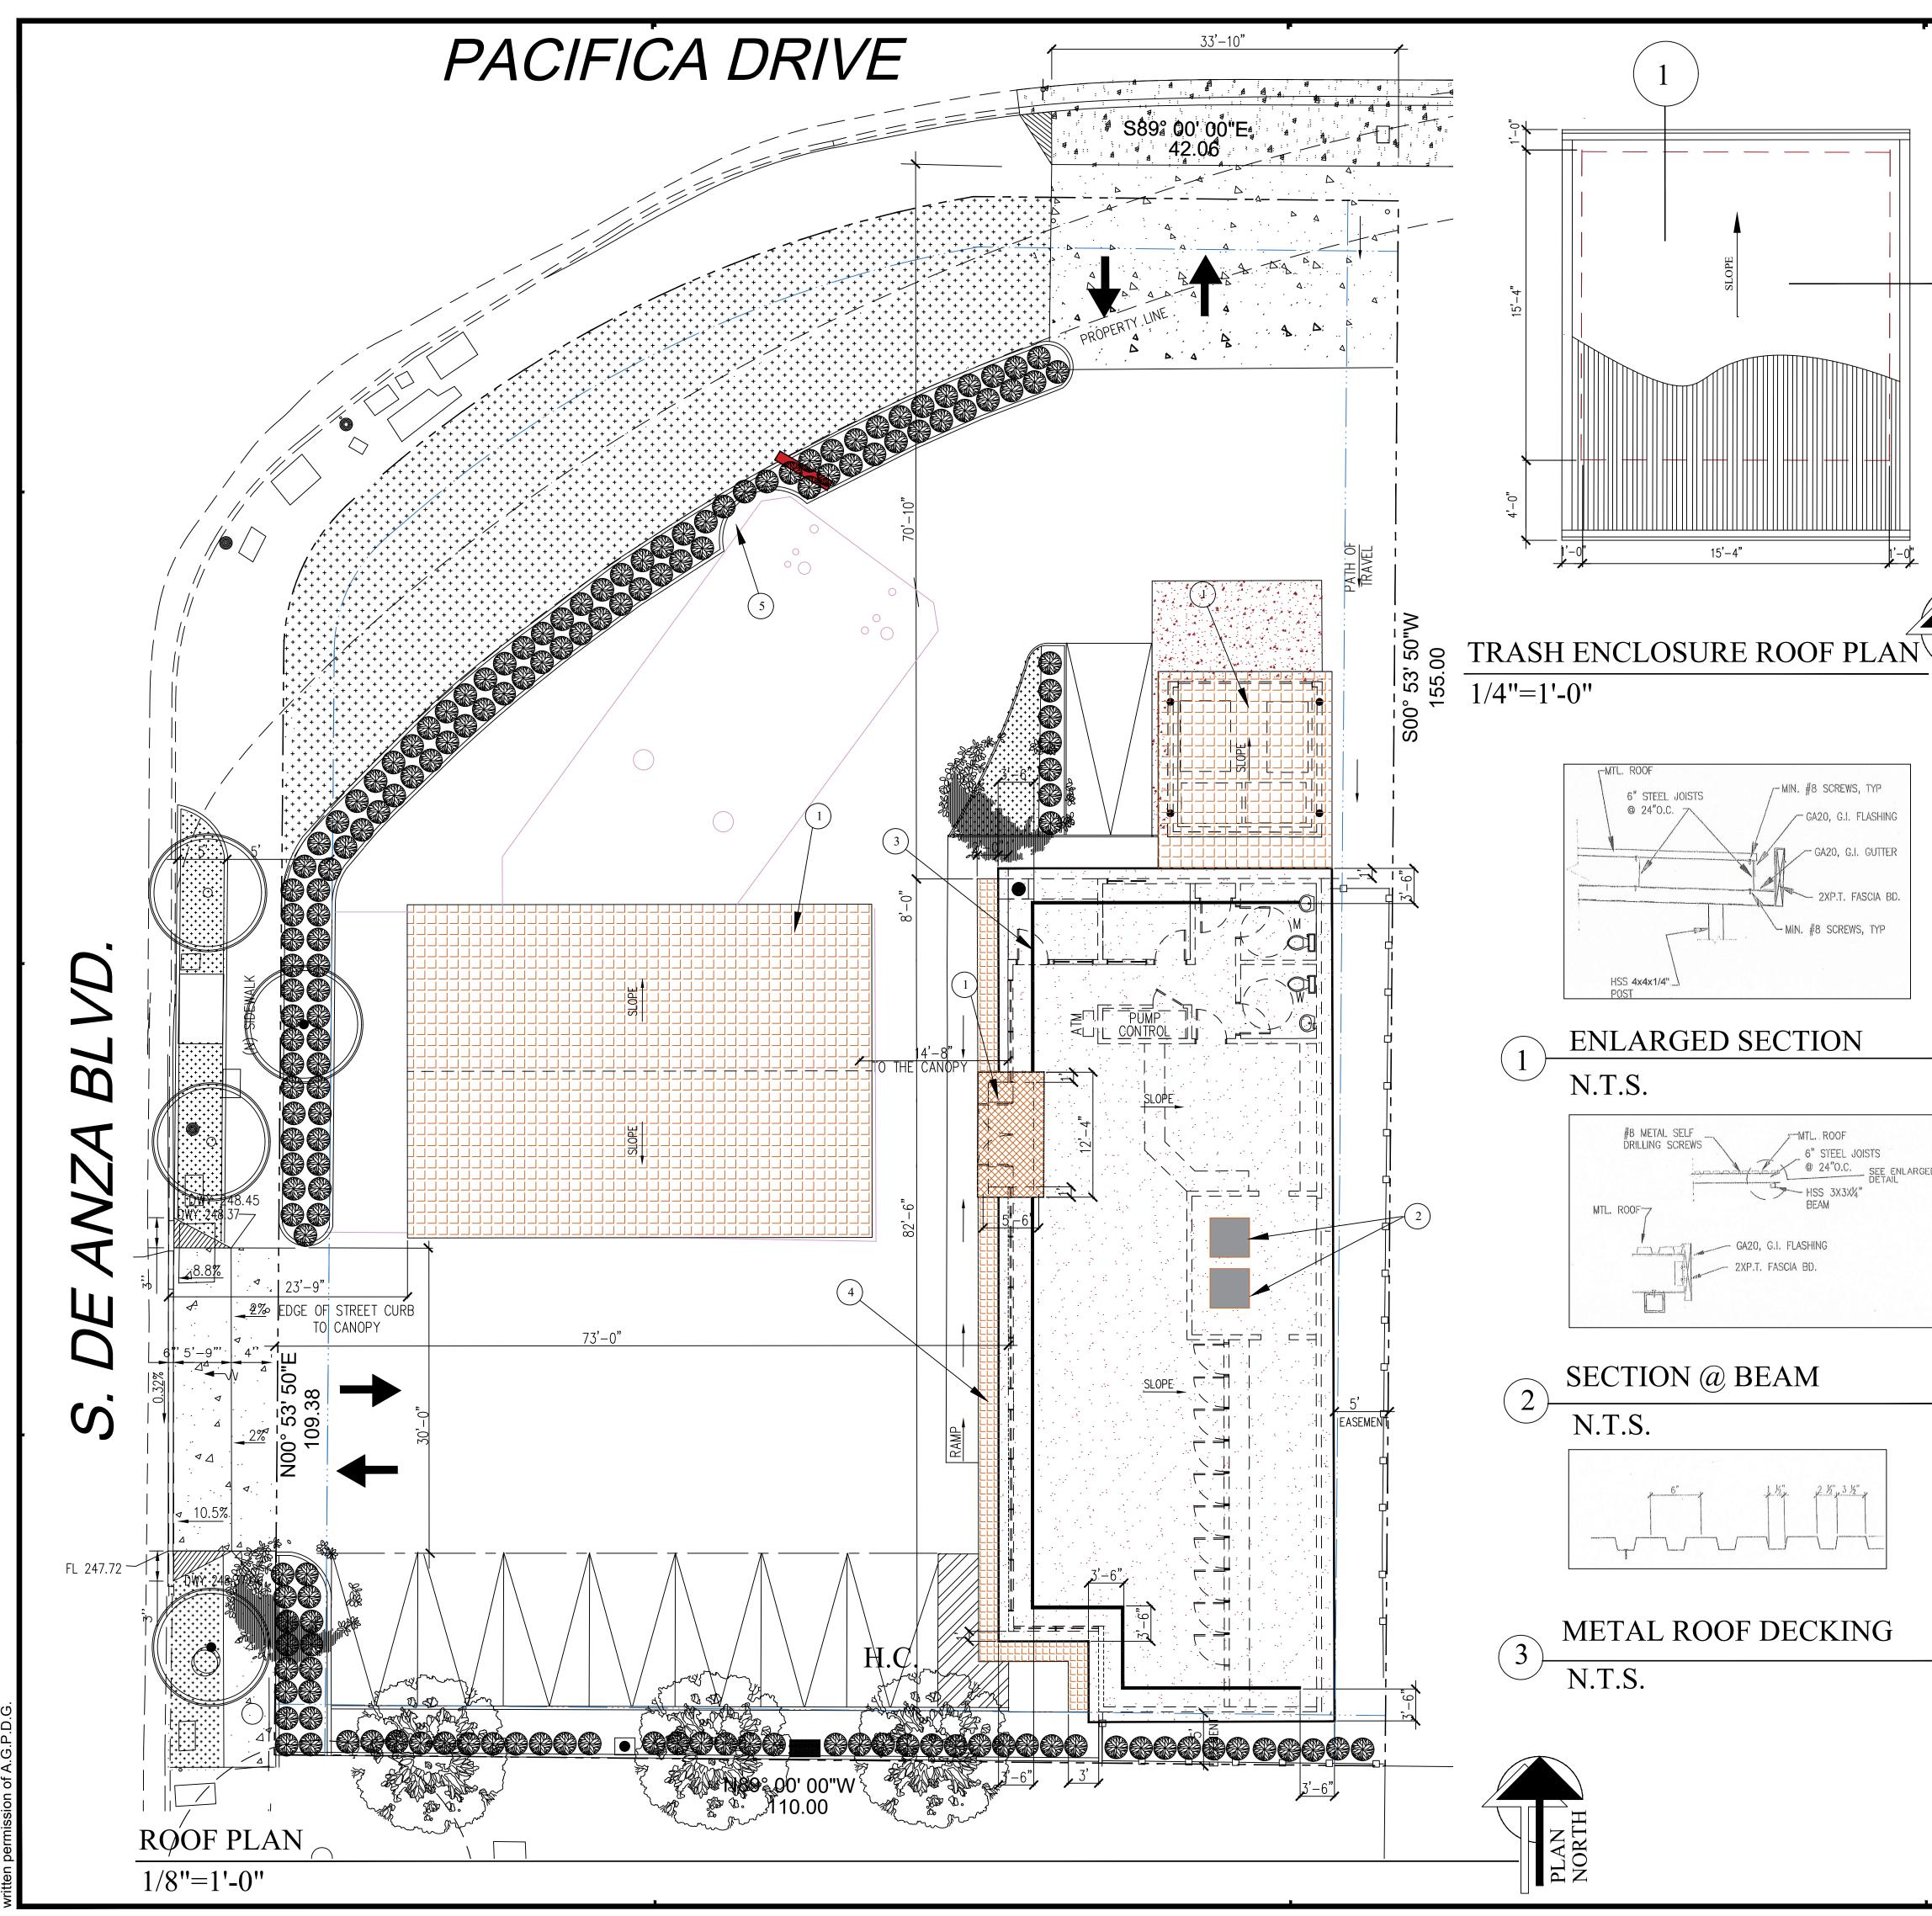N.T.S.

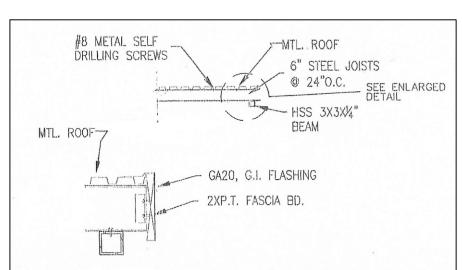


SECTION @ BEAM

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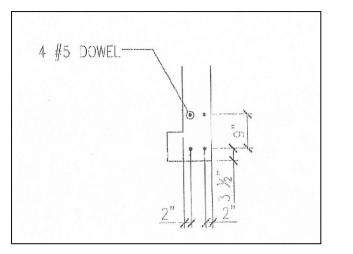


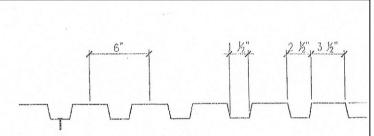METAL ROOF DECKING


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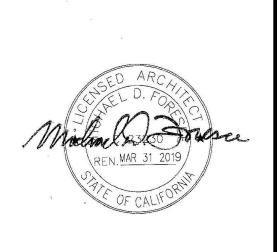
ROOF SUPPORT DETAIL N.T.S.

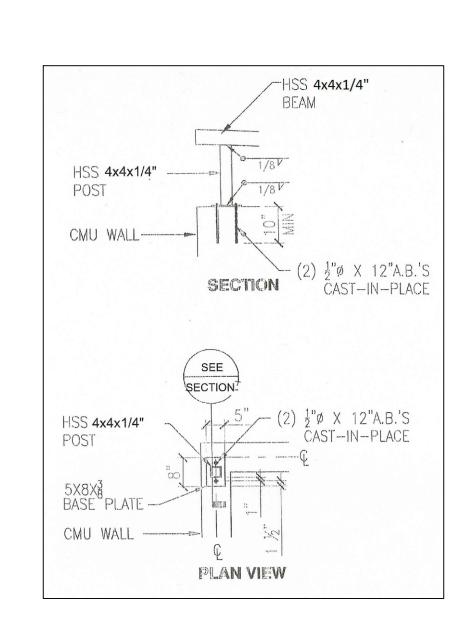


CMU DOWELS DETAIL N.T.S.



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REVISIONS NO. ITEM Planning Submittal Planning Reviewl Planning Submittal

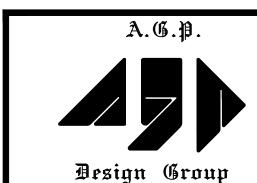
3/7/18

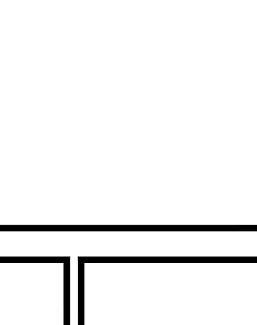Planning Comments

Planning Submittal

DRAWN BY: CHECKED BY: PROJECT NO: SCALE: AS SHOWN


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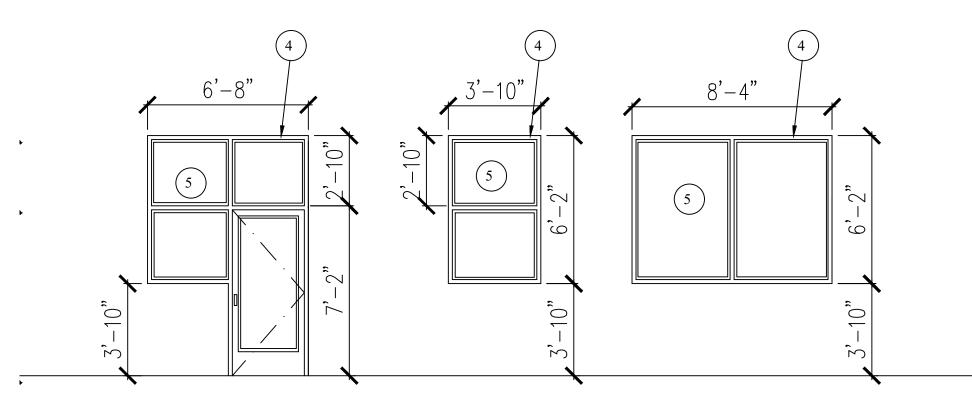


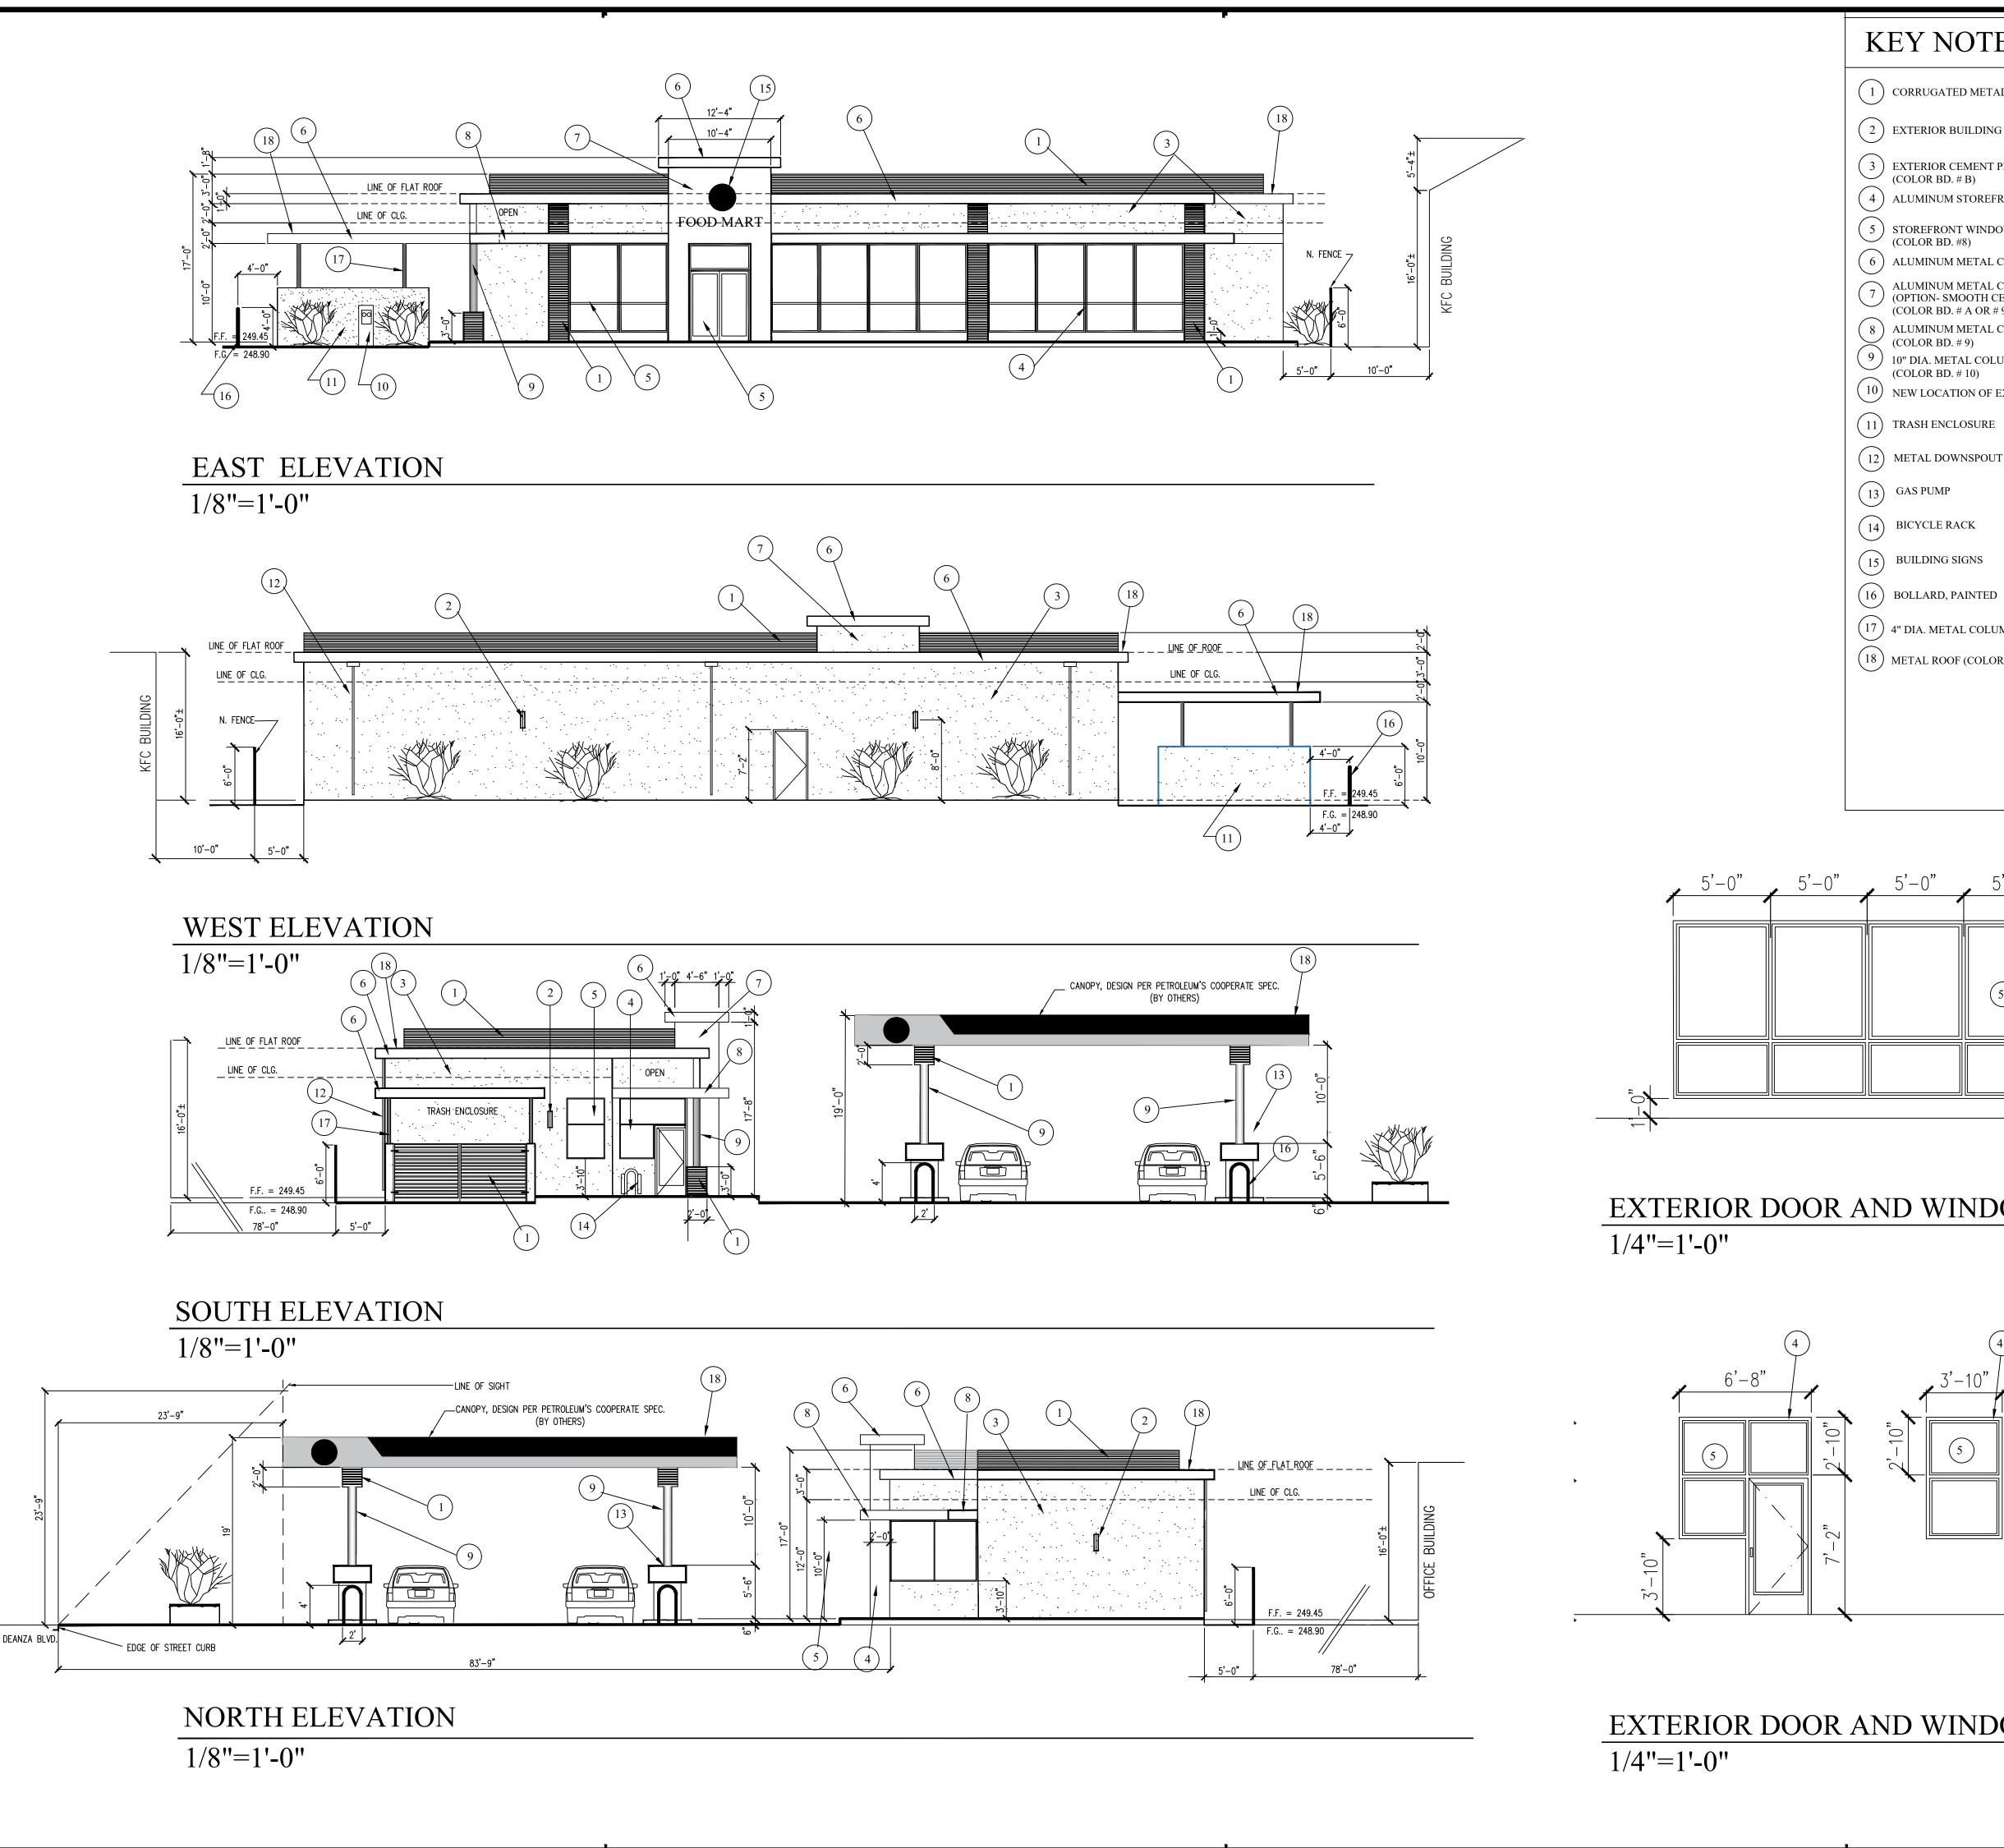- 1 ) CORRUGATED METAL PANEL, SILVER SMITH SR1:51 (COLOR BD. #1)
- 2 ) EXTERIOR BUILDING LIGHT, TEX 30"L x 12"W x 4"D (COLOR BD. #3)
- 3 ) EXTERIOR CEMENT PLASTER- SMOOTH FINISH, KELLY MOORE -KM 237-L BLUE HARMONY"
- 4 ) ALUMINUM STOREFRONT DOOR & FRAME, LT601-70 BLACK 3P (COLOR BD. #7)
- 5 ) STOREFRONT WINDOWS, AA 250/ 425 THERMAL WINDOWS ENTRANCED & STOREFRONTS
- 6 ) ALUMINUM METAL COMPOSITE PANELS, BTR-RED ALPOLIC MFG. OR EQUAL (COLOR BD. # 9)
- ALUMINUM METAL COMPOSITE PANELS, BPS-PEARL ALPOLIC MFG. OR EQUAL
- 8 ALUMINUM METAL COMPOSITE PANELS, BSM SLATE BLACK MATTE ALPOLIC MFG. OR EQUAL
- (9) 10" DIA. METAL COLUMN WARPED WITH BRUSHED ALUMINUM
- (10) NEW LOCATION OF EXISTING AIR AND WATER PUMP

- (16) BOLLARD, PAINTED
- (17) 4" DIA. METAL COLUMN WARPED WITH BRUSHED ALUMINUM (COLOR BD. # 10)
- (18) METAL ROOF (COLOR BD. #2)



# EXTERIOR DOOR AND WINDOW ELEVATION

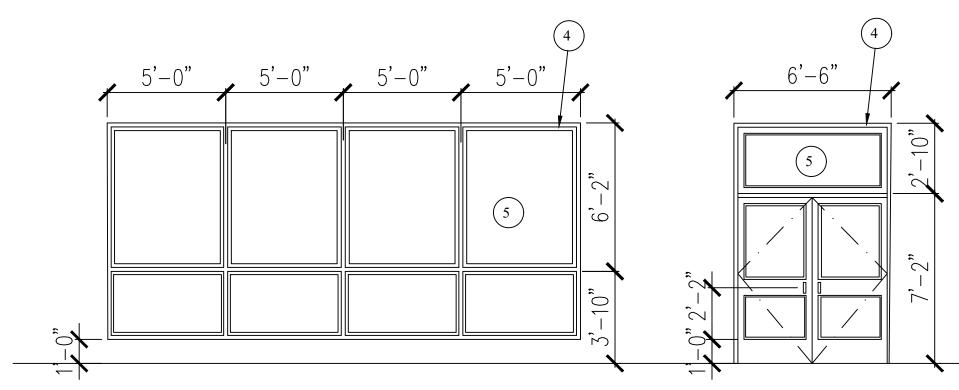


EXTERIOR DOOR AND WINDOW ELEVATION




Campbell, CA 95008

Tel:(408) 316.6168

E-Mail:agp@pacbell.net

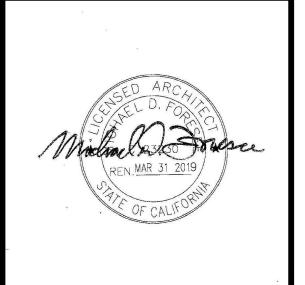


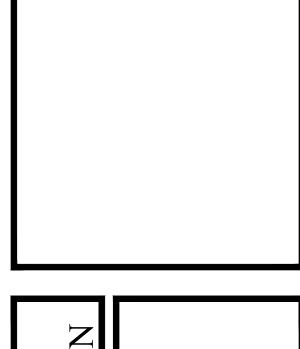

10490 S. DE ANZ CUPERTINO,


REVISIONS NO. ITEM Planning Submittal PLANNING REVIEW Planning Submittal 2/21/18

DRAWN BY: CHECKED BY: PROJECT NO: SCALE: AS SHOWN

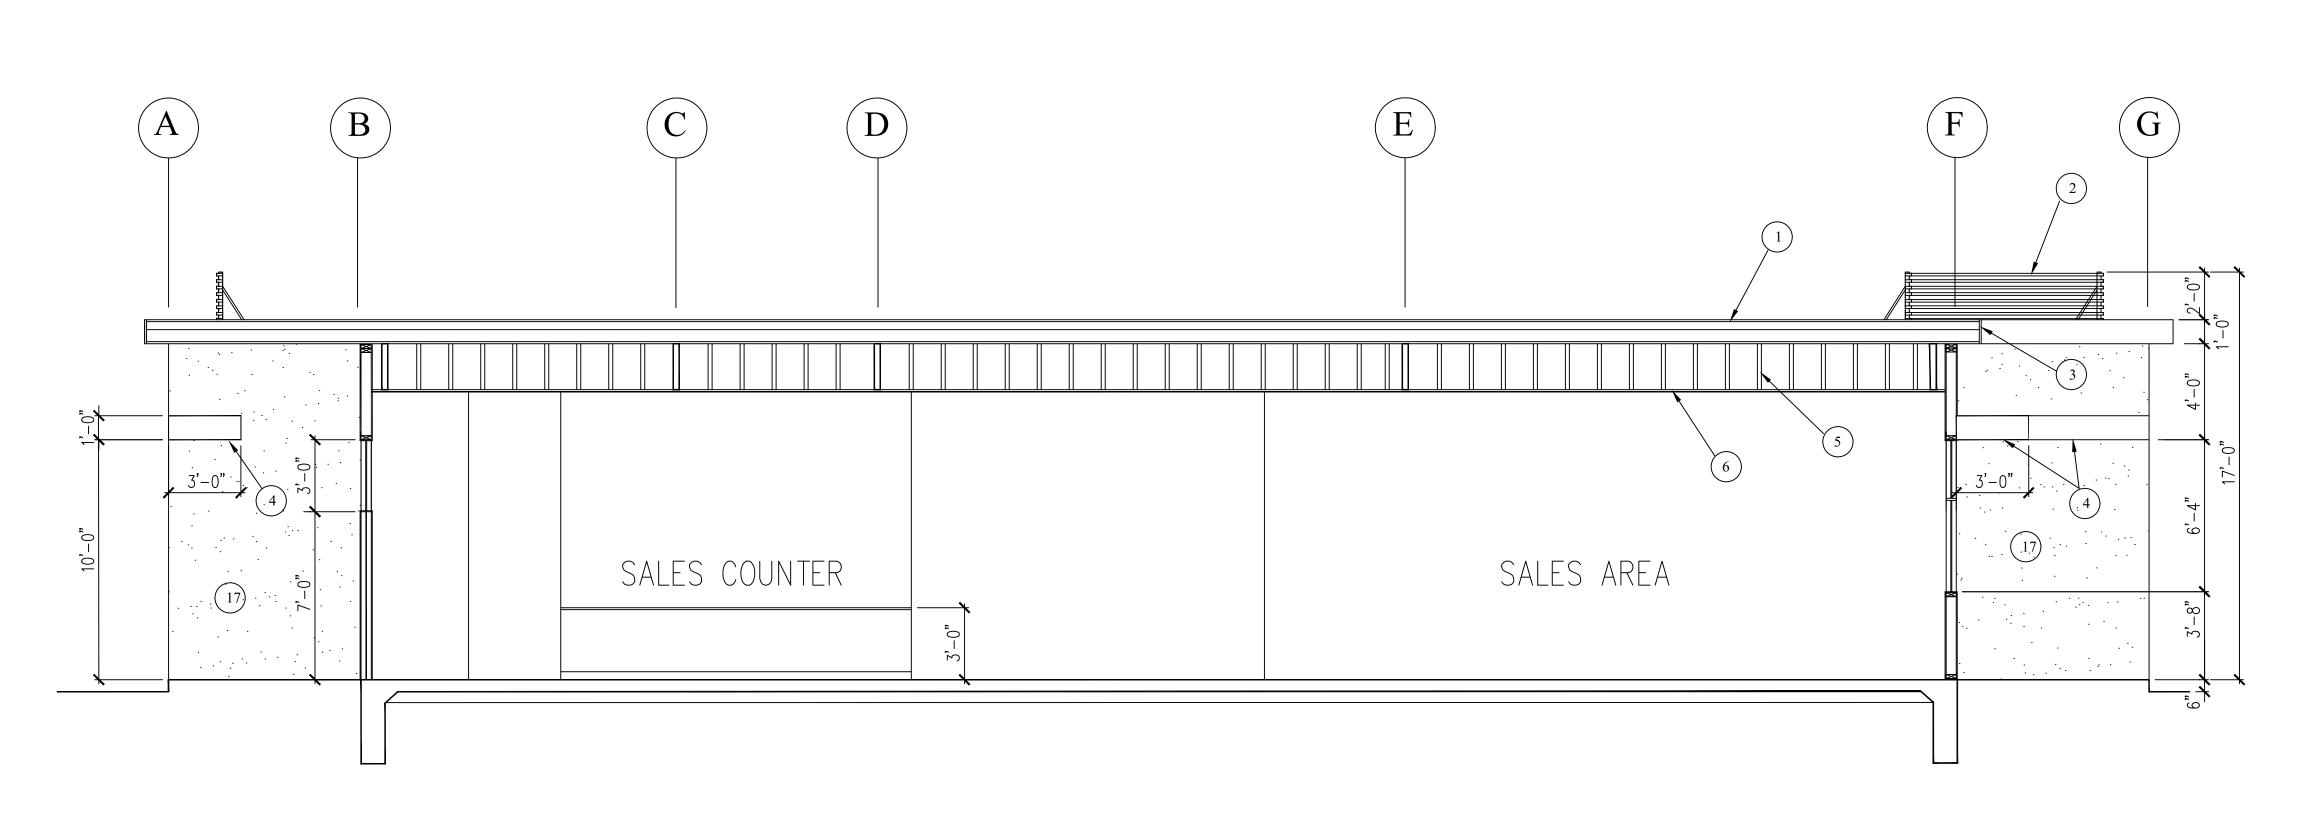


### **BUILDING SECTION A-A**

1/4"=1'-0"

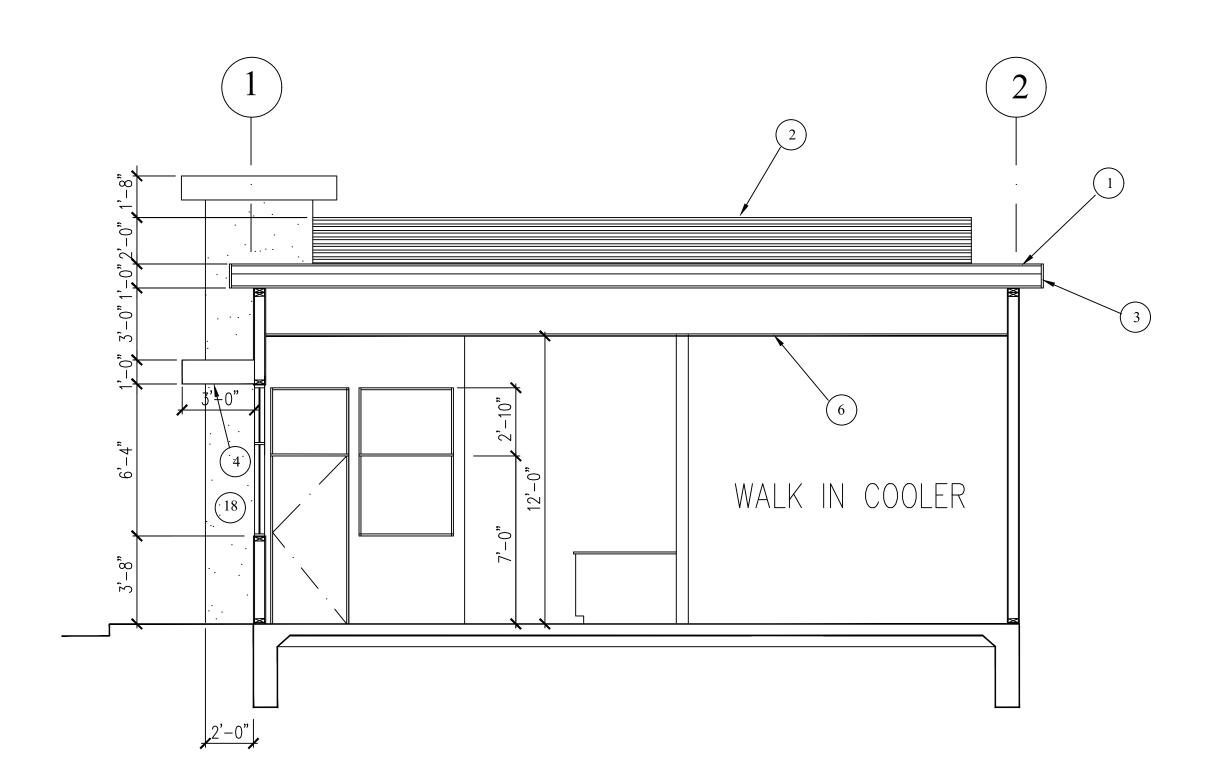

BUILDING SECTION B-B

1/4"=1'-0"

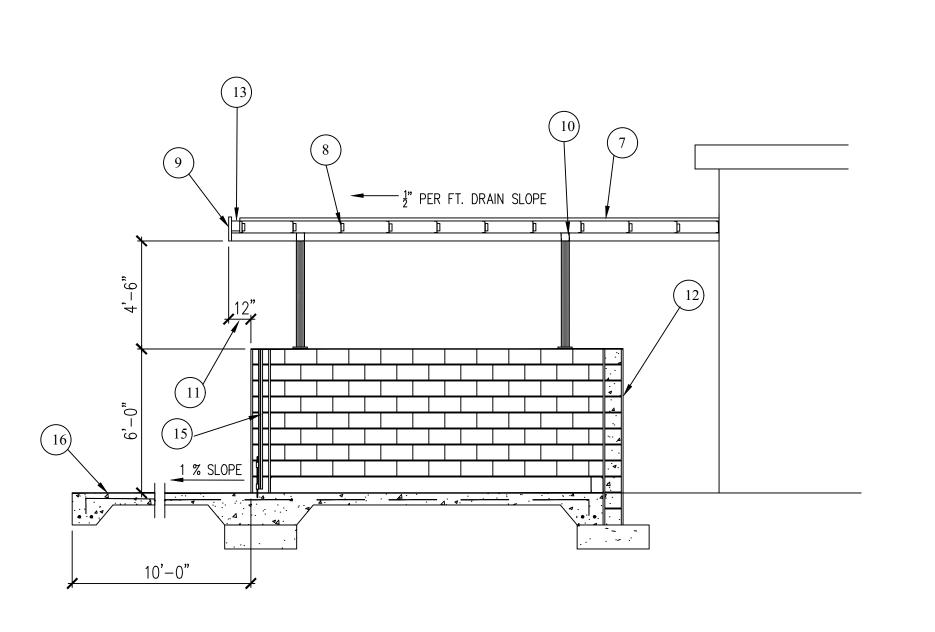

TRASH ENCLOSURE SECTION A-A

1/4"=1'-0"

GENERAL NOTES

- 1. FIELD VERIFY ALL DIMENSIONS AND EXISTING EQUIPMENT, EXISTING ELECTRICAL & MECHANICAL UTILITIES, ROOF ELEMENTS, PIPING, CONDUIT AND CONDITION OF THE SPACE BEFORE CONSTRUCTION COMMENCES.
- 2. NOTIFY ARCHITECT OF ANY CONFLICTS BETWEEN CONSTRUCTION DOCUMENTS AND EXISTING CONDITIONS.
- 3. CONTRACTOR IS RESPONSIBLE FOR ALL ELECTRICAL WORK, SUCH AS OUTLETS, SWITCHES, WIRING AND ALL DOCUMENTS WHICH ARE REQUIRED BY ALL AGENCIES FOR PLAN CHECK AND BUILDING PERMIT PROCESS.
- 4. CONTRACTOR IS RESPONSIBLE FOR ALL MECHANICAL, HVAC WORK, AND ALL DOCUMENTS WHICH ARE REQUIRED BY AGENCIES FOR PLAN CHECK AND BUILDING PERMIT PROCESS.

### KEY NOTES

1 FLAT ROOF (COLOR BD. # 2)

2 METAL PANEL SCREEN (COLOR BD. # 1)

3 METAL FASCIA (COLOR BD. # 9)

FLAT OVERHANG BELOW, SEE ELEVATION FOR LOCATION (COLOR BD. # 6)

5 STRUCTURAL JOIST

6 SUSPENDED CEILING

CORR. METAL ROOFING, COATED WITH RUST INHIBITED PAINT (COLOR BD. # 2)

8 WELD ANGLE STL. 1 1/2" x 6"x 3/8" PLATE TO STL JOIST, USE #8 SCREWS TO

FASCIA BD.

9 GA 20,G.I EDGE FLASHING

(10) 4 x 4 x 1/4" HSS PERPEN. TO BEAM

11) 12" ROOF OVERHANG TYP.

12) 8" CMU WALL

(13) GA 20, G.I. GUTTER

(14) GATE HINGES INTO MTL. BOLLARD

15) MTL. GATE

16) DRIVEWAY LEVEL (CONC. APRON)

(COLOR BD. # B)


(COLOR BD. # B)

CEMENT PLASTER FINISH "KELLY MORE 45 WHITE SHADOW"


(COLOR BD. # A OR # 9))

A.G.P.

Design Group

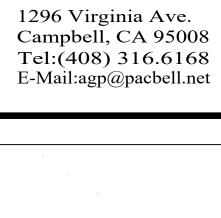



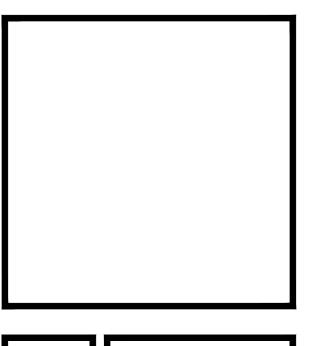

10490 S. DE ANZA BLVD.

REVISIONS
NO. ITEM DATE

Planning Submittal 9/6/16

Planning Submittal 12/11/17

Planning Submittal 3/7/18

PLOT SCALE: 12"=1'-0"

DRAWN BY: AK

CHECKED BY: MF

PROJECT NO: DATE:

SCALE: AS SHOWN 07-6-16

A.8.0


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DE ANZA BLVD. - EXISTING EAST VIEW


N.T.S

DE ANZA BLVD. - PROPOSED EAST VIEW N.T.S



PACIFICA STRET - EXISTING SOUTH VIEW

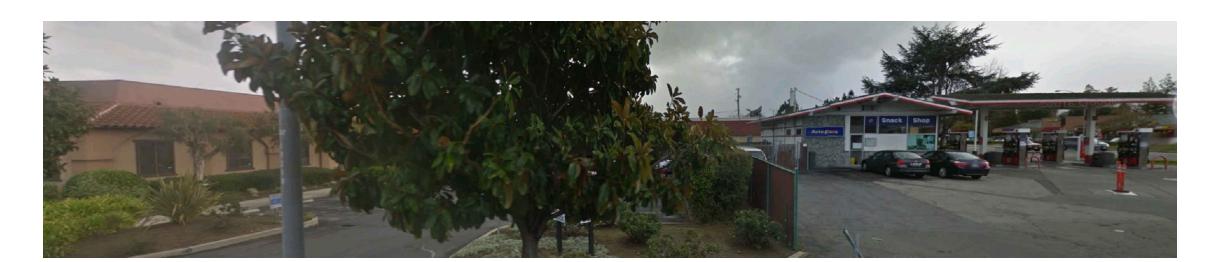
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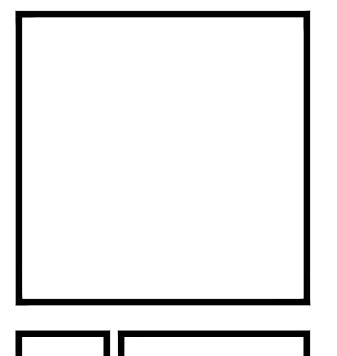


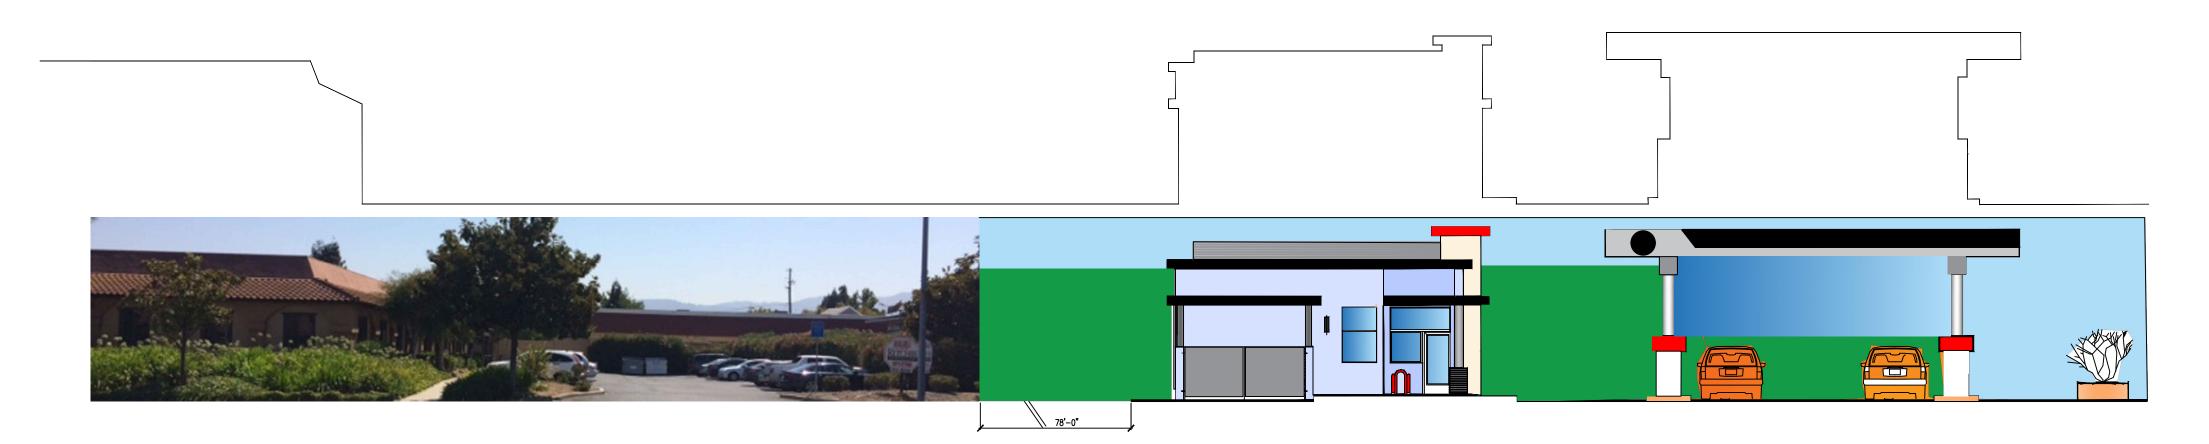PACIFICA STRET - PROPOSED SOUTH VIEW

N.T.S





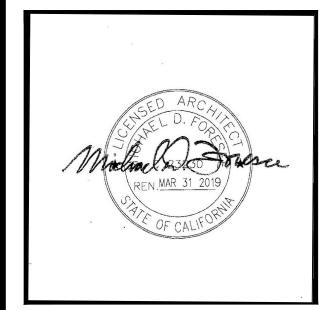

REVISIO	NS	
NO.	ITEM	DAT
Planning S	Submittal	12/11/
Planning (	Comments	2/21/
D1	Submittal	3/7/

DRAWN BY:	AK
CHECKED BY:	MF
PROJECT NO:	DATE:
SCALE: AS SHOWN	07-6-16

# MATERIALS & COLORS LEGEND

COLORS BY KELY- MOORE OR EQUIVALENT

A. KELLY- MOORE- #45 WHITE SHADOW
EXTERIOR- SMOOTH CEMENT PLASTER COLOR
(OPTION FOR ALUMINUM METAL COMPOSITE PANELS - BPS PEARL)

B. KELLY- MOOR- KM237-L BLUE HARMONY EXTERIOR- SMOOTH CEMENT PLASTER COLOR

### MATERIALS:

- 1. CORRUGATED METAL PANEL SILVER SMITH SR1: 51, BY ATAS INTERNATIONAL, INC.
- 2. METAL ROOF GALVANIZED SILVER, BY AEP SPAN.
- 3. EXTERIOR BUILDING LIGHT (WALL MOUNTED)
  "TEX" 30"L x 12"W x 4"D, BY ALVA LIGHT.
- 4. CANOPY LIGHT RECESSED "E CP2 SERIES" LED SQUARE SILVER, BY E-CONOLIGHT.
- 5. EXTERIOR LIGHT POST PROGRESS LIGHTING MODEL P5493 BLACK
- 6. METAL CANOPY CEILING/ SOFFIT SR1, 51, BY ATAS INTERNATIONAL, INC.
- 7. ALUMINUM STOREFRONT DOOR & FRAME "LT601-70 BLACK 3P", BY TUBELITE.
- 8. STOREFRONT WINDOWS
  "AA 250/ 425 THERMAL WINDOWS ENTRANCED & STOREFRONTS",
  BY KAWNEER WINDOW.
- 9. ALUMINUM METAL COMPOSITE PANELS
  "BTR- RED, BPS- PEARL, BSM SLATE BLACK MATTE", BY ALPOLIC.
- 10. BRUSHED ALUMINUM COLUMN COVER.

10490 S. DE ANZA BLVD.

CUPERTINO, CA


B 10


COLORS & MATERIAL BOARD

11. 25. 2017





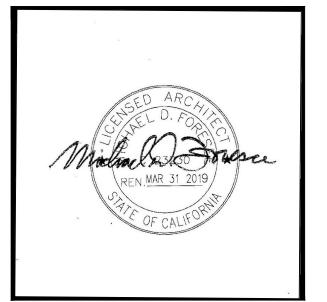

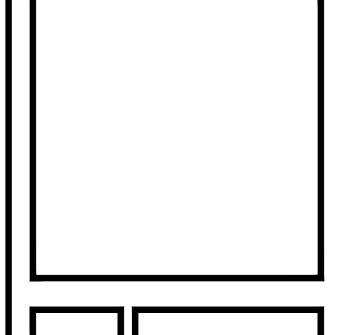

10490 S. DE ANZA BLVD.

REVISIONS
NO. ITEM DATE

Planning Submittal 12/11/17

Planning Comments 2/21/18

Planning Submittal 3/7/18

PLOT SCALE: 12"=1'-0"

DRAWN BY: AK

CHECKED BY: MF


PROJECT NO: DATE:

SCALE: AS SHOWN 07-6-16

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RENDERING-3D

REVIS	IONS	
NO.	ITEM	DATE
Planning Submittal		12/11/17
Planni	ng Comments	2/21/18
Plannir	ng Submittal	3/7/18

PLOT SCALE:	12"=1'-0'
DRAWN BY:	AK
CHECKED BY:	MF
PROJECT NO:	DATE:
SCALE: AS SHOWN	07-6-16

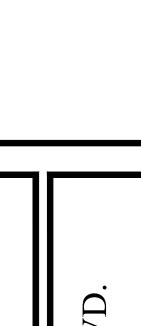A.11.0

	ABBRE		TIONS
	DESCRIPTION		DESCRIPTION
AB A A B B B B C € C C C D D D EL E E E E E F F F F F G G H D IN J B G L S B B B C € C C C D D D EL E E E E E E E E E E E E E E E	CENTERLINE SWALE CLEANOUT CHANNEL DRAIN DRIVEWAY DROP INLET DETAIL ELECTRIC EDGE OF PAVEMENT ELEVATION EUCALYPTUS TREE	L/N(N) G.R.B GV/L P P P P P R R S S S S S S S S T F F G S P T Y V W W W W W W W W W W W W W W W W W W	PROPERTY LINE POWER POLE PLASTIC PERFORATED PIPE PUBLIC SERVICE EASEMENT POLYVINYL CHLORIDE RIGHT OF WAY REINFORCED CONCRETE PIPE STORM DRAIN

EXISTING	PROPOSED	DESCRIPTION
		PROPERTY LINE
F	F	FILL AREA LIMIT
C	C	CUT AREA LIMIT
		CONTOUR
	W	WATER LINE
SD	———SD— <b>—</b>	STORM DRAIN PIPE (SOLID)
SS	SS	SANITARY SEWER PIPE
SUD -	———SUD— <del>►</del>	SUBDRAIN PIPE (PERFORATE
OH e,T,TV	OH e,T,TV	OVERHEAD UTILITIES WITH P
G	——— G ———	GAS LINE
— Е —	—— Е ——	ELECTRIC LINE (UNDERGROU
JT	JT	JOINT TRENCH (UNDERGROU
SLV	⊠ SLV	STREET LIGHT VAULT
○ SSCO	● SSCO	SANITARY SEWER CLEANOUT
	•	SANITARY SEWER MANHOLE
$\odot$	•	STORM DRAIN MANHOLE
		SURVEY CITY MONUMENT
		ELECTROLIER
WM	<b>⋈</b> wм	WATER METER
		TREE WITH TRUNK
- x	xx	6' WOODEN FENCE
×102.23	102.23	SPOT ELEVATION
-00	TREE PROTECTION 5' TALL CHAIN LI	
— <b>- &gt;</b> -	— EARTHSWALE	
<b></b>	_ CONCRETE SWALE	<u>-</u>
	AREA DRAIN/ INL	ET
$\Rightarrow$	OVERLAND RELEASE	PATH
		2% MIN. AWAY FROM HOUSE PROPERTY LINE TO SWALE
	(E) TREE TO BE	REMOVE
8	DOWN-SPOUT	
0	POP-UP EMITTER	
~	D00E D000	

ROOF DOWN-SPOUT, CONNECTED TO STORM

DRAIN SYSTEM

# GRADING AND DRAINAGE PLANS GAS STATION PHASE ONE 10490 S. DE ANZA BLVD., CUPERTINO, CA

SANITARY SEWER NOTES

with all current local, state and federal requirements.

as per State of California Standard Specifications.

the City of Cupertino Building Department.

Sanitary District and other affected agencies.

A. Underground Service Alert 800-227-2600

C. Sanitary Sewers Cupertino Sanitary District

B. Storm Drains City of Cupertino

UPON COMPLETION OF INSPECTION.

modifications or departure is to be done.

CUPERTINO SANITARY DISTRICT

District Engineer

Approved \_\_\_\_\_, 20\_\_\_\_,

Engineer.

associated with this project.

by District Engineer.

be obtained and a copy shall be on the job during construction.

the Cupertino Sanitary District.

1. All work performed shall be installed to manufacturers specifications and all work shall comply

2. All work shall be constructed in accordance with these plans and the Standard Specifications of

requirements of the Engineer of the public agency having jurisdiction. Encroachment Permits shall

4. Fill material shall be compacted to a minimum of two and one half (2.5) feet above the top of

slurry mix. Fill material must attain a minimum of ninety five percent (95%) relative compaction,

5. The District Engineer shall be notified two (2) working days in advance of starting construction on this project, 20065 Stevens Creek Boulevard, Building C, Cupertino, CA 95014 (408) 253-7071.

At that time, traffic plans, encroachment permits and the sewer diversion plans shall be given to

6. One (1) sanitary sewer lateral shall be installed for each lot or building. Location of lateral and

property corners to be staked in field at the same time the sewer main is staked for construction. Laterals shall not be laid on less than two percent (2%) grade and shall have a minimum cover of

four and one half (4.5) feet at property line or edge of sanitary sewer easement. Laterals shall be

deeper than four and one half (4.5) feet when directed by District Engineer. Laterals shall not be

extended beyond the street right—of—way line or sanitary sewer easement line until the main has

been tested. Lateral sewers constructed outside of the public street or Cupertino Sanitary District

Easement shall be constructed in accordance with the requirements of, and shall be inspected by

improvements including existing sanitary sewer facilities that are to remain and if damaged during

construction of the proposed improvements, shall be repaired to the satisfaction of the Cupertino

covers, placed in the manholes and manhole castings shall be adjusted to final grade in accordance

9. Channels of all District manholes within the construction area shall be protected by plywood

with the Standard Specifications of the Cupertino Sanitary District or as directed by the District

10. The Developer and General Contractor shall be responsible for the prevention of construction

11. The Developer and General Contractor shall be responsible for the prevention of a sewage spill

associated the Contractors activities on this project and the Developer and Contractor shall pay all

costs associated with the release of sewage into surface drainage system and downstream surface

13. All Sanitary Sewer Pipes shall be PVC-SDR26 or approved equal, unless otherwise specified by

14. Access for pedestrians and vehicles shall be provided at all times unless approved in writing

DISTRICT INSPECTOR. DISTRICT TO PROVIDE BUILDING DEPARTMENT WHIT WRITTEN NOTIFICATION

Approval of these plans by Cupertino Sanitary District does not relieve the installer of the

responsibility for the correction of mistakes, errors, or omissions. If, during the course of

authority to require such modifications or departure and to specify the manner in which the

construction of the sanitary sewers the public interest requires a modification of, or a departure

from the District Specifications or these improvement plans, the District Engineer shall have the

construction debris into the existing sanitary sewer system due to the construction activities

12. Utility Notification (Contractor shall locate all utilities prior to start of excavation):

debris entering the existing sanitary sewer system due to the construction activities associated with this project and the Developer and Contractor shall pay all costs associated with the release of

7. The Contractor performing work on the sanitary sewers shall be required to register with the District and provide insurance as specified in Sections 1.39 and 1.40 of the District's Standard

8. The Developer and General Contractor shall be responsible for protection of all existing

the District Engineer. Sewer diversion plans shall include sewage bypass and emergency plans.


Work shall not begin until the District Engineer has provided written acceptance of these plans.

3. All excavation and backfilling within street right—of—way shall be done in accordance with the

pipe elevation by methods that will not damage the pipe or substituted with gravel or one (1)

### GENERAL NOTES

- 1. All work shall be in accordance with the State of California Department of Transportation Standard Specifications (dated July 1992), Standard Plans (dated July 1992), and City of Cupertino Standard Details. The Contractor shall perform the work described in the specification, and as shown on the drawings, and to the satisfaction of the City Engineer
- 2. The Contractor is required to notify the Public Works Inspector two (2) working days prior to requiring an inspection. Two (2) working days prior to installing permanent striping, the Contractor shall call for review and approval of the proposed striping by the City Traffic Engineer. The City shall have the right to make changes in the locations of the alignment of lane stripes and pavement markings.
- 3. All underground utilities shall be installed and adequately backfilled before placement of the base material and surface structures. If utilities are to be installed subsequently, a written notification from the affected utility company indicating its commitment to bore or tunnel shall be submitted to the City Engineer before proceeding with the work. Underground utilities, except storm and sanitary sewer, will not be permitted in pavement area, with the exception of street crossings, otherwise specifically approved and authorized by the City Engineer.
- 4. The Contractor shall have all of the utilities, underground mains and services that may conflict with the project, located in the field. The Contractor shall contact Underground Service Alert (USA) two (2) working days in advance of any work, for location of the underground facilities, at (800) 642-2444.
- 5. All trench backfill, fill areas, and base material shall attain a minimum 95 % compaction as per Standard Specifications. For typical trench sections, refer to the City Standard Details, with the
- 6. All trees, roots and foreign matter in existing or proposed Right of Way shall be removed to a depth of two (2) feet below subgrade and disposed of.
- 7. All existing pavement removed or damaged shall be replaced as required by the City
- 8. All concrete used for all structures must be Class "A" (6 sacks per cubic yard) as per Standard Specifications and shall attain a strength of 3,000 p.s.i. in 28 days. Sidewalks, curbs and gutters shall be Class "B" (5 sacks per cubic yard) as per Standard Specification and shall attain a strength of 3,000 p.s.i. in 28 days.
- 9. Drop inlets installed shall be City of Cupertino Standard unless otherwise noted on the plans. The boxes shall be installed at the same time the P.C.C. curb and gutter is installed. Class "A" P.C.C. shall be used.
- 10. A minimum thickness of six (6) inches of P.C.C. shall be required for commercial driveway approaches and five (5) inches for residential. Locations shall be determined prior to the installation of curbs.
- The driveway shall be installed at the same time as the curb.
- 11. All street curbs shall be vertical P.C.C. curbs.
- 12. Install City of Cupertino street name signs, four (4) blades each per assembly as shown on
- 13. Install City of Cupertino standard monument box (es) and monument(s) as shown on the
- 14. All grade stakes and laths required by the City Engineer shall be installed by the OUND) Subdivider's Engineer as directed. Minimum off—sets for cut stakes shall be five (5) feet.
  - 15. Prior to commencing work, the Contractor shall have cut sheets approved by the City Engineer. Notify the City Engineer two (2) working days prior to requiring inspection.
  - 16. The Contractor shall submit a written request for final inspection.
  - 17. One pound of dispersing black shall be mixed with each cubic yard of concrete at the batch
  - 18. Grading of lots outside of R/W as per typical section and for cross—section, shall be completed and approved by the City Engineer before proceeding with preparation of the subgrade and placement of surface structures on lots. All lots shall be graded to the street elevation, or as shown on the plans, or as determined by the City Engineer.
  - 19. Notify the City Engineer (two) 2 working days in advance of requiring services for checking field staking. At this time, three (3) copies of the cut sheets will be furnished.
  - 20. All standard street monuments, lot corner pipes, and other permanent monuments disturbed during construction shall be replaced before acceptance of the improvements by the City of Cupertino.
  - 21. Manhole frames and covers shall be brought to finish grade before final paving.
  - 22. The Developer shall pay all costs for moisture—density curves (Calif. Test No. 216E) and any other tests required by the City Engineer during street construction.
  - 23. Approval of these plans does not release the Contractor of the responsibility for the corrections of mistakes, errors, or omissions contained therein. If, during the course of construction of improvements, public interest requires a modification of/or a departure from the City of Cupertino specification or these improvement plans, the City Engineer shall have the authority to require such modification or departure and to specify the manner in which the same is to be completed.
  - 24. Septic tanks shall be pumped and backfilled to the satisfaction of Santa Clara County Health Department prior to construction.
  - 25. For all five (5) foot monolithic sidewalks, all fire hydrants and electroliers shall be installed behind the sidewalk.
  - 26. Each sheet of the construction/modification plans shall be initialed by the City Engineer to be considered approved final plans. It shall be the responsibility of the Contractor, and all Subcontractors to insure they are furnished with approved plans or the latest revised plans.
  - 27. All water lines, valves, hydrants, and appurtenances thereto installed within the City of Cupertino Municipal Water Utility's services area, shall be the property of said water utility.
  - 28. Construction signing shall be installed prior to the beginning of work.
  - 29. Any and all storm lines installed as part of the work on these plans shall be cleaned of all excess material, debris and obstructions. Storm lines shall be flushed as directed by the City

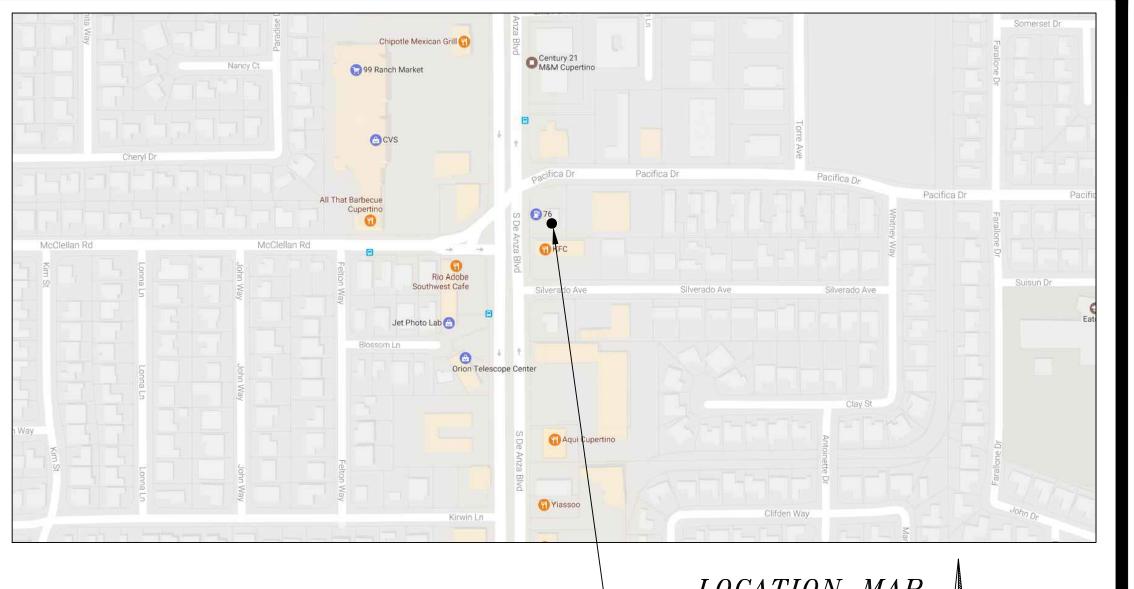

PROJECT SITE -

SHEET INDEX:

LOCATION MAP

COVER SHEET, NOTES, DETAIL GRADING AND DRAINAGE PLAN

DETAILS

STORMWATER CONTROL PLAN

STORMWATER CONTROL MEASURES / DETAILS

EROSION CONTROL PLAN

### BASIS OF BEARINGS:

THE BEARING S 89°00'00" E OF CENTERLINE OF PACIFIC DR., AS SHOWN ON THAT CERTAIN RECORD MAP, RECORDED IN BOOK 154 OF MAPS, AT PAGE 4, SANTA CLARA COUNTY RECORDS. WAS USED AS THE BASIS OF BEARINGS SHOWN ON THIS MAP.

### SITE BENCHMARK: ◆

SURVEY CONTROL SET MAG NAIL ELEVATION=248.00'

### PROJECT BENCHMARK:

SANTA CLARA VALLEY WATER DISTRICT BM #57 (NAVD 88 DATUM)

### CUPERTINO SANITARY SEWER DISTRICT NOTE:

- CUPERTINO SANITARY SEWER DISTRICT CONNECTION PERMIT IS REQUIRED PRIOR TO ISSUE OF ANY BUILDING PERMIT.
- -SFF SANITARY SEWER NOTES ON SHEET C-2 FOR REQUIREMENTS AND RECOMMENDATIONS.

### NOTE:

"THE GEOTECHNICAL ASPECTS OF THE CONSTRUCTION, INCLUDING SITE GRADING, BASEMENT EXCAVATION, PIER DRILLING, FOOTING EXCAVATIONS, PREPARATION OF SUBGRADE AND PLACEMENT OF NON-EXPANSIVE FILL BENEATH THE BASEMENT SLAB AND SLABS-ON-GRADE, PAVEMENTS, RETAINING WALL BACKFILL, AND INSTALLATION OF SURFACE AND SUBSURFACE DRAINAGE SHOULD BE PERFORMED IN ACCORDANCE WITH THE RECOMMENDATIONS OF THE GEOTECHNICAL REPORT PREPARED BY MURRAY ENGINEERS, INC., DATED JANUARY 10, 2013. MURRAY ENGINEERS, INC. SHOULD BE PROVIDED AT LEAST 48 HOURS ADVANCE NOTIFICATION (650-559-9980) OF ANY EARTHWORK OPERATIONS AND SHOULD BE PRESENT TO OBSERVE AND TEST, AS NECESSARY, THE EARTHWORK, FOUNDATION, AND DRAINAGE INSTALLATION PHASES OF THE PROJECT."

- 15. VIDEOTAPE INSPECTION OF THE EXISTING/ (N) PROPERTY LINE CLEANOUT, POINT OF CONNECTION AND STREET LATERAL IS REQUIRED PRIOR TO PASSING THE CITY OF CUPERTINO FINAL Swales, gutters, storm drain inlets and drainage systems.
  - 2. All roof downspouts shall discharge to concrete splash pads draining away from the foundation. See architectural plans for roof downspout locations.
  - 3. On site storm drain lines shall consist of solid PVC—SCH 40 OR PVC SDR—35 minimum or better. Use PVC SCH80 OR PVC SDR-26 for pipes running under driveway.
  - 4. Storm drain inlets shall be precast concrete, Christy U23 type or equivalent. Use traffic grade cover for inlets in driveways and stalls.

### CITY ENGINEER'S SIGNATURE

APPROVED BY: TIMM D. BORDEN RCE 45512 DIRECTOR OF PUBLIC WORKS EXP. 12/31/14

**SMP** CIVIL ENGINEERS LAND SURVEYORS

1534 CAROB LANE LOS ALTOS, CA 94024 TEL: (650) 941-8055 FAX: (650) 941-8755

OWNER / DEVELOPER:

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GAS STAT 10490 S. CUP GRADING AN


02/06/2017 AS SHOWN


PREPARED BY: S.P. CHECKED BY:

S.R.


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Sheet 1 OF 6



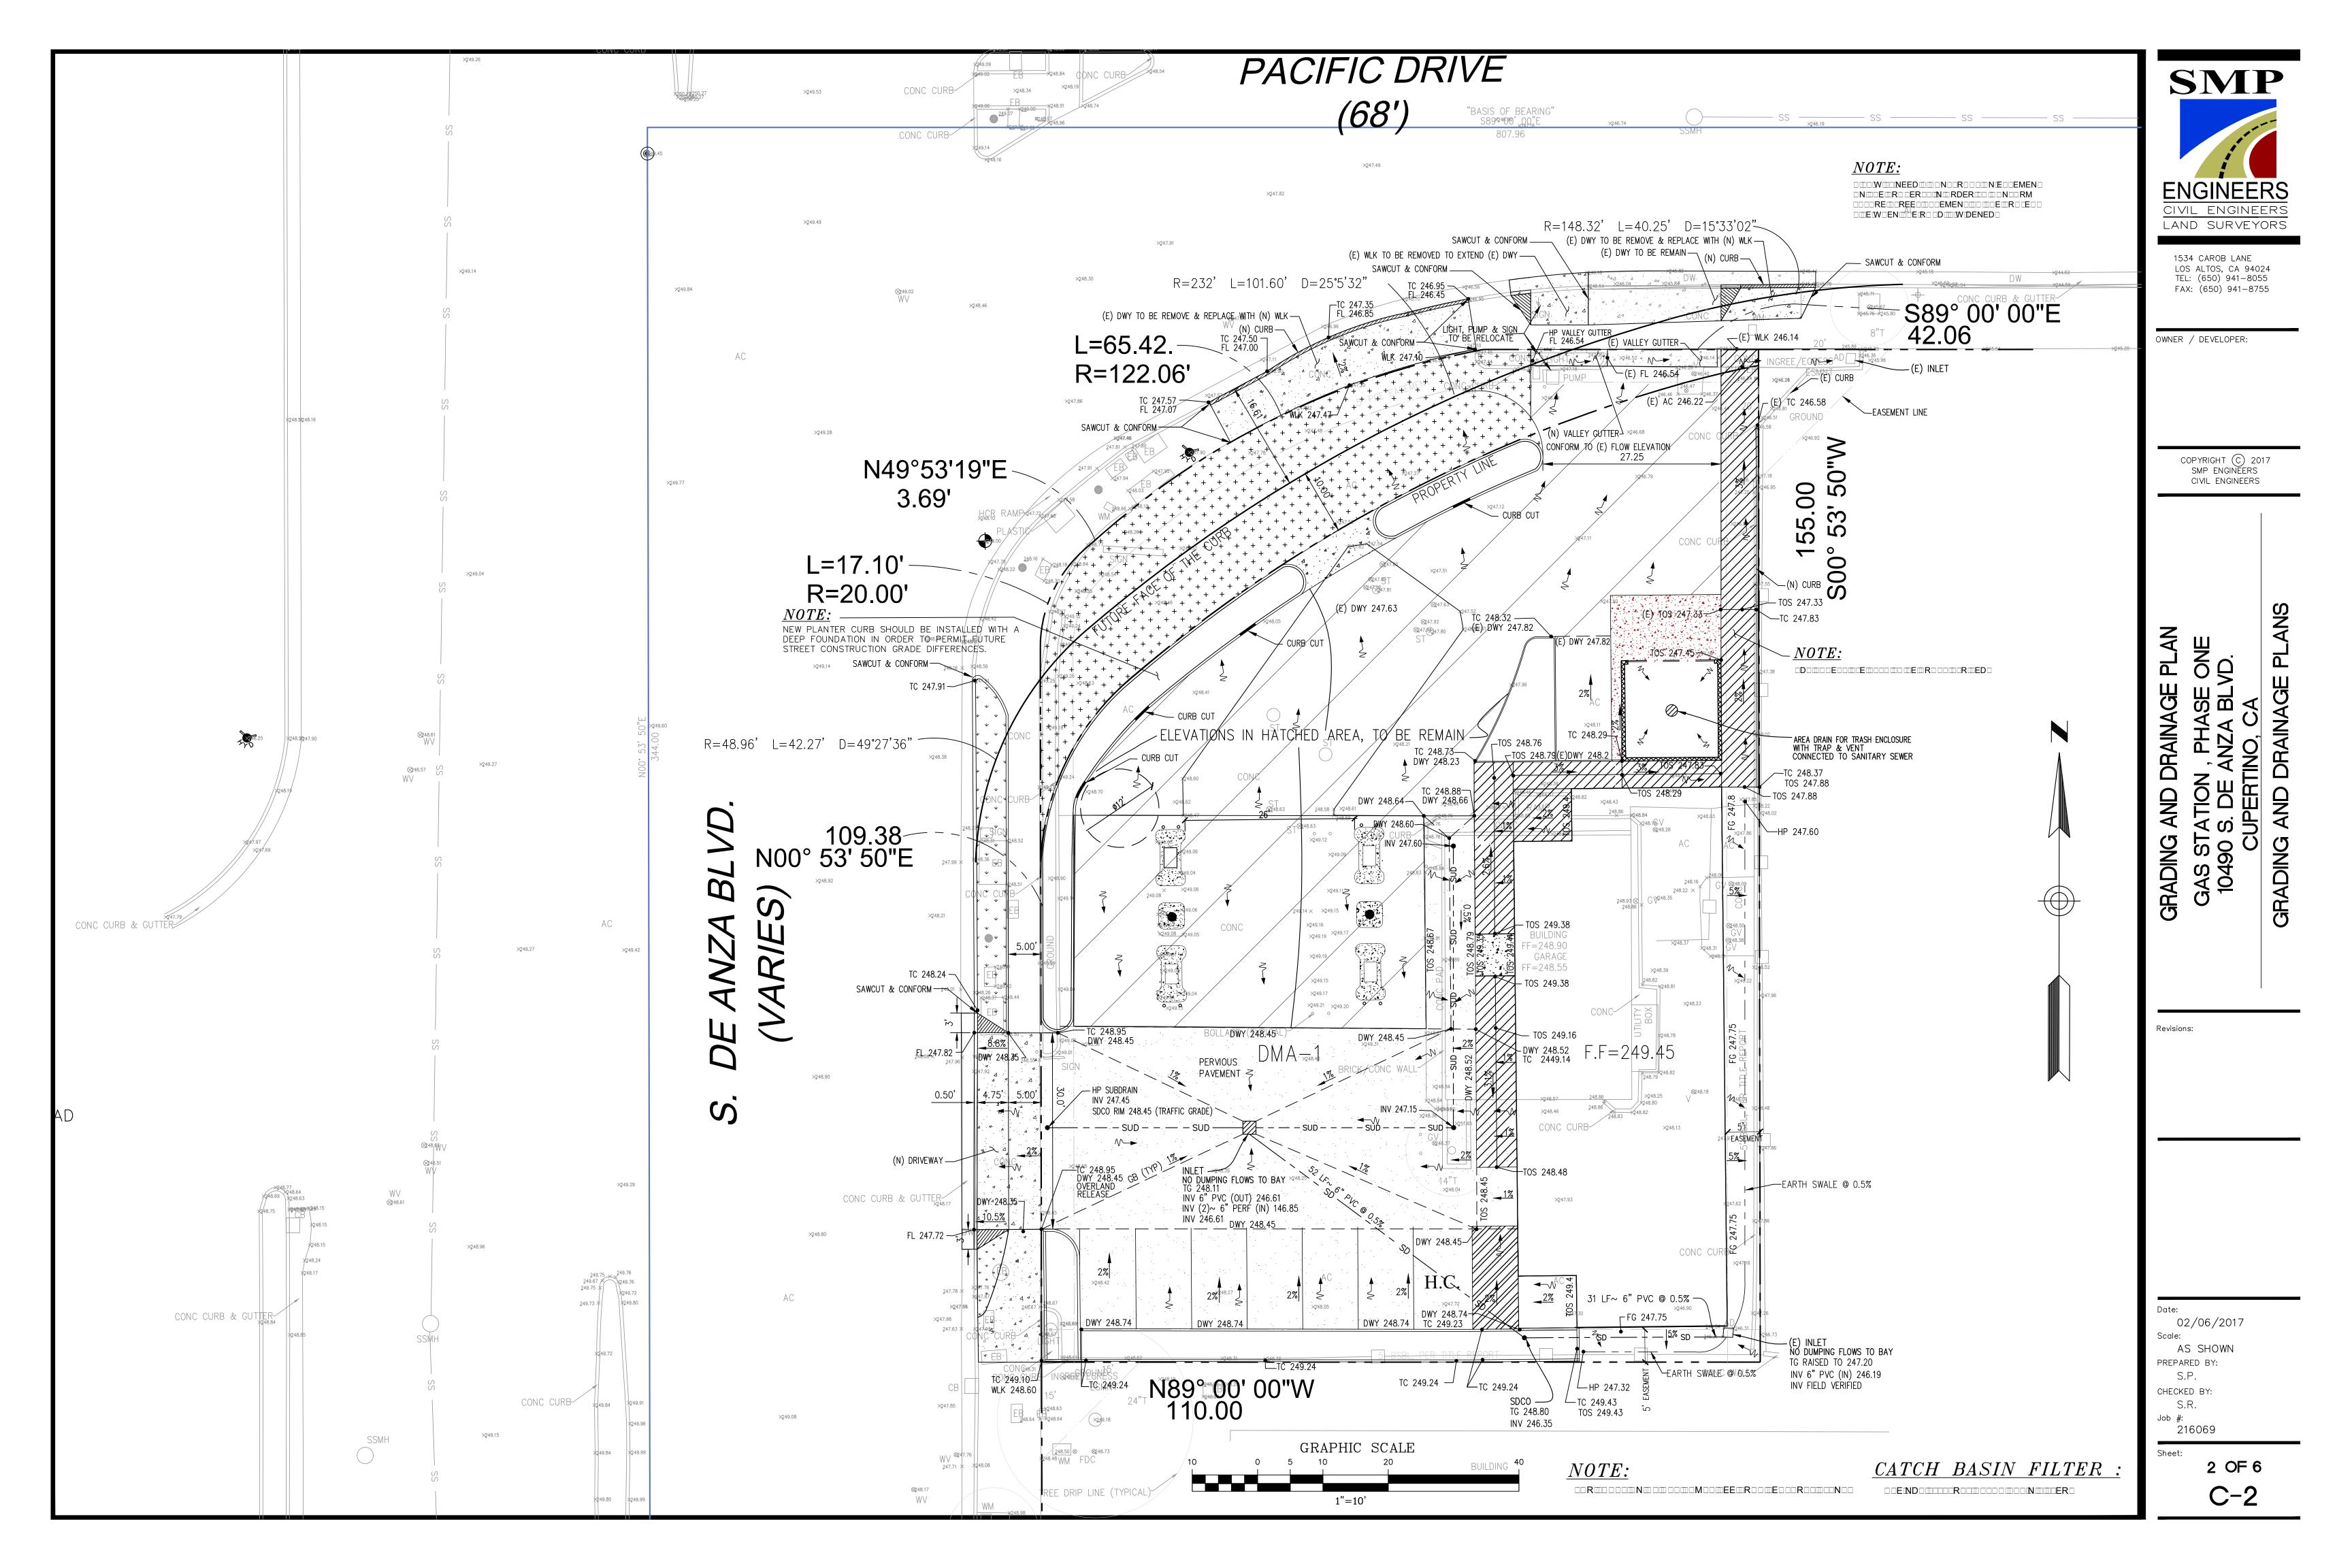


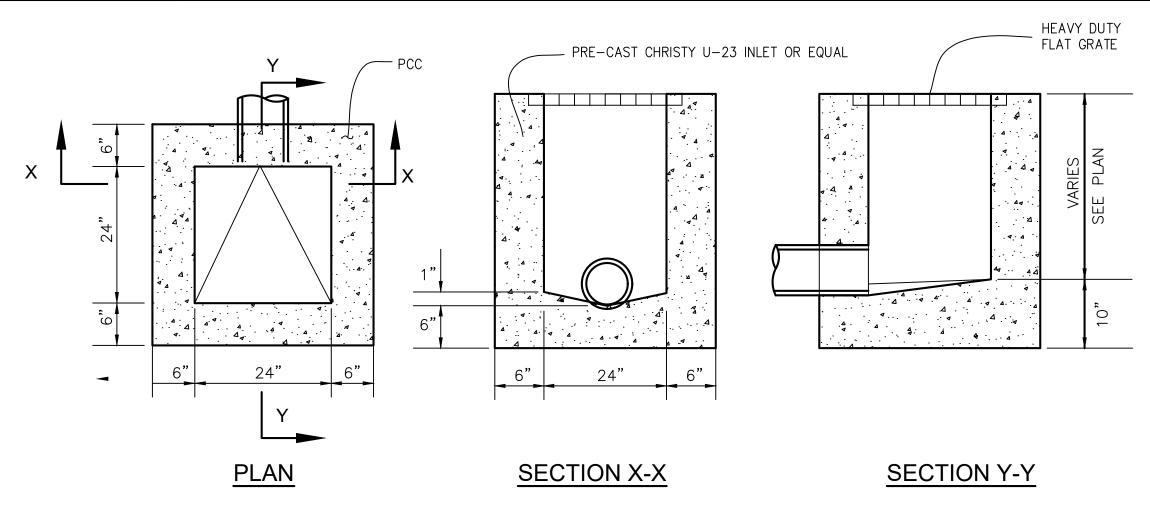STORM DRAIN INLET N.T.S.

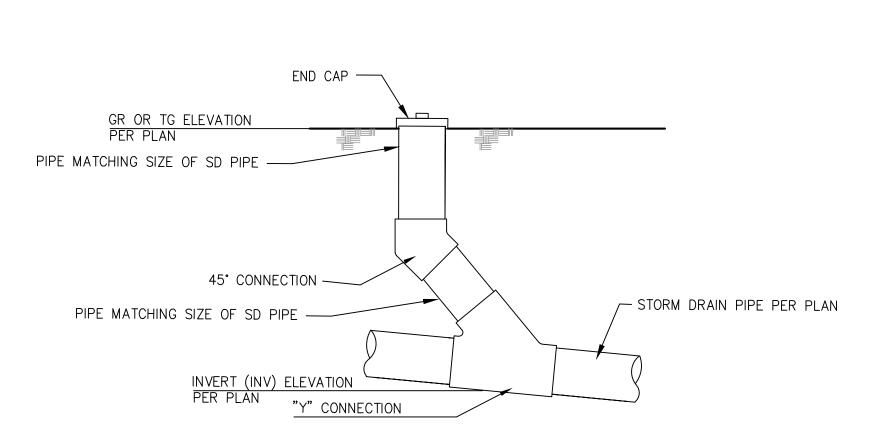


**ELEVATION VIEW** 


STORM DRAIN CLEANOUT DETAIL
N.T.S

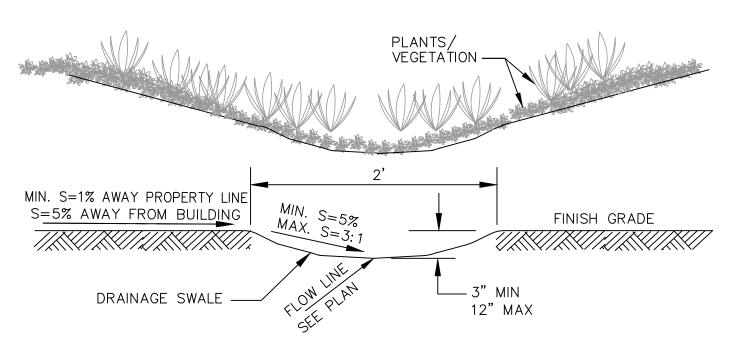

EARTH-SWALE DETAIL

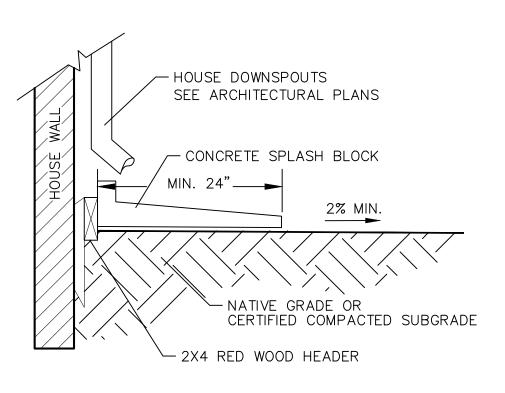

SPLASH BLOCK N.T.S.

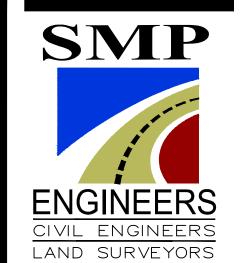

1534 CAROB LANE LOS ALTOS, CA 94024 TEL: (650) 941–8055 FAX: (650) 941–8755

OWNER / DEVELOPER:


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02/06/2017

S.P.

CHECKED BY:

3 OF 6

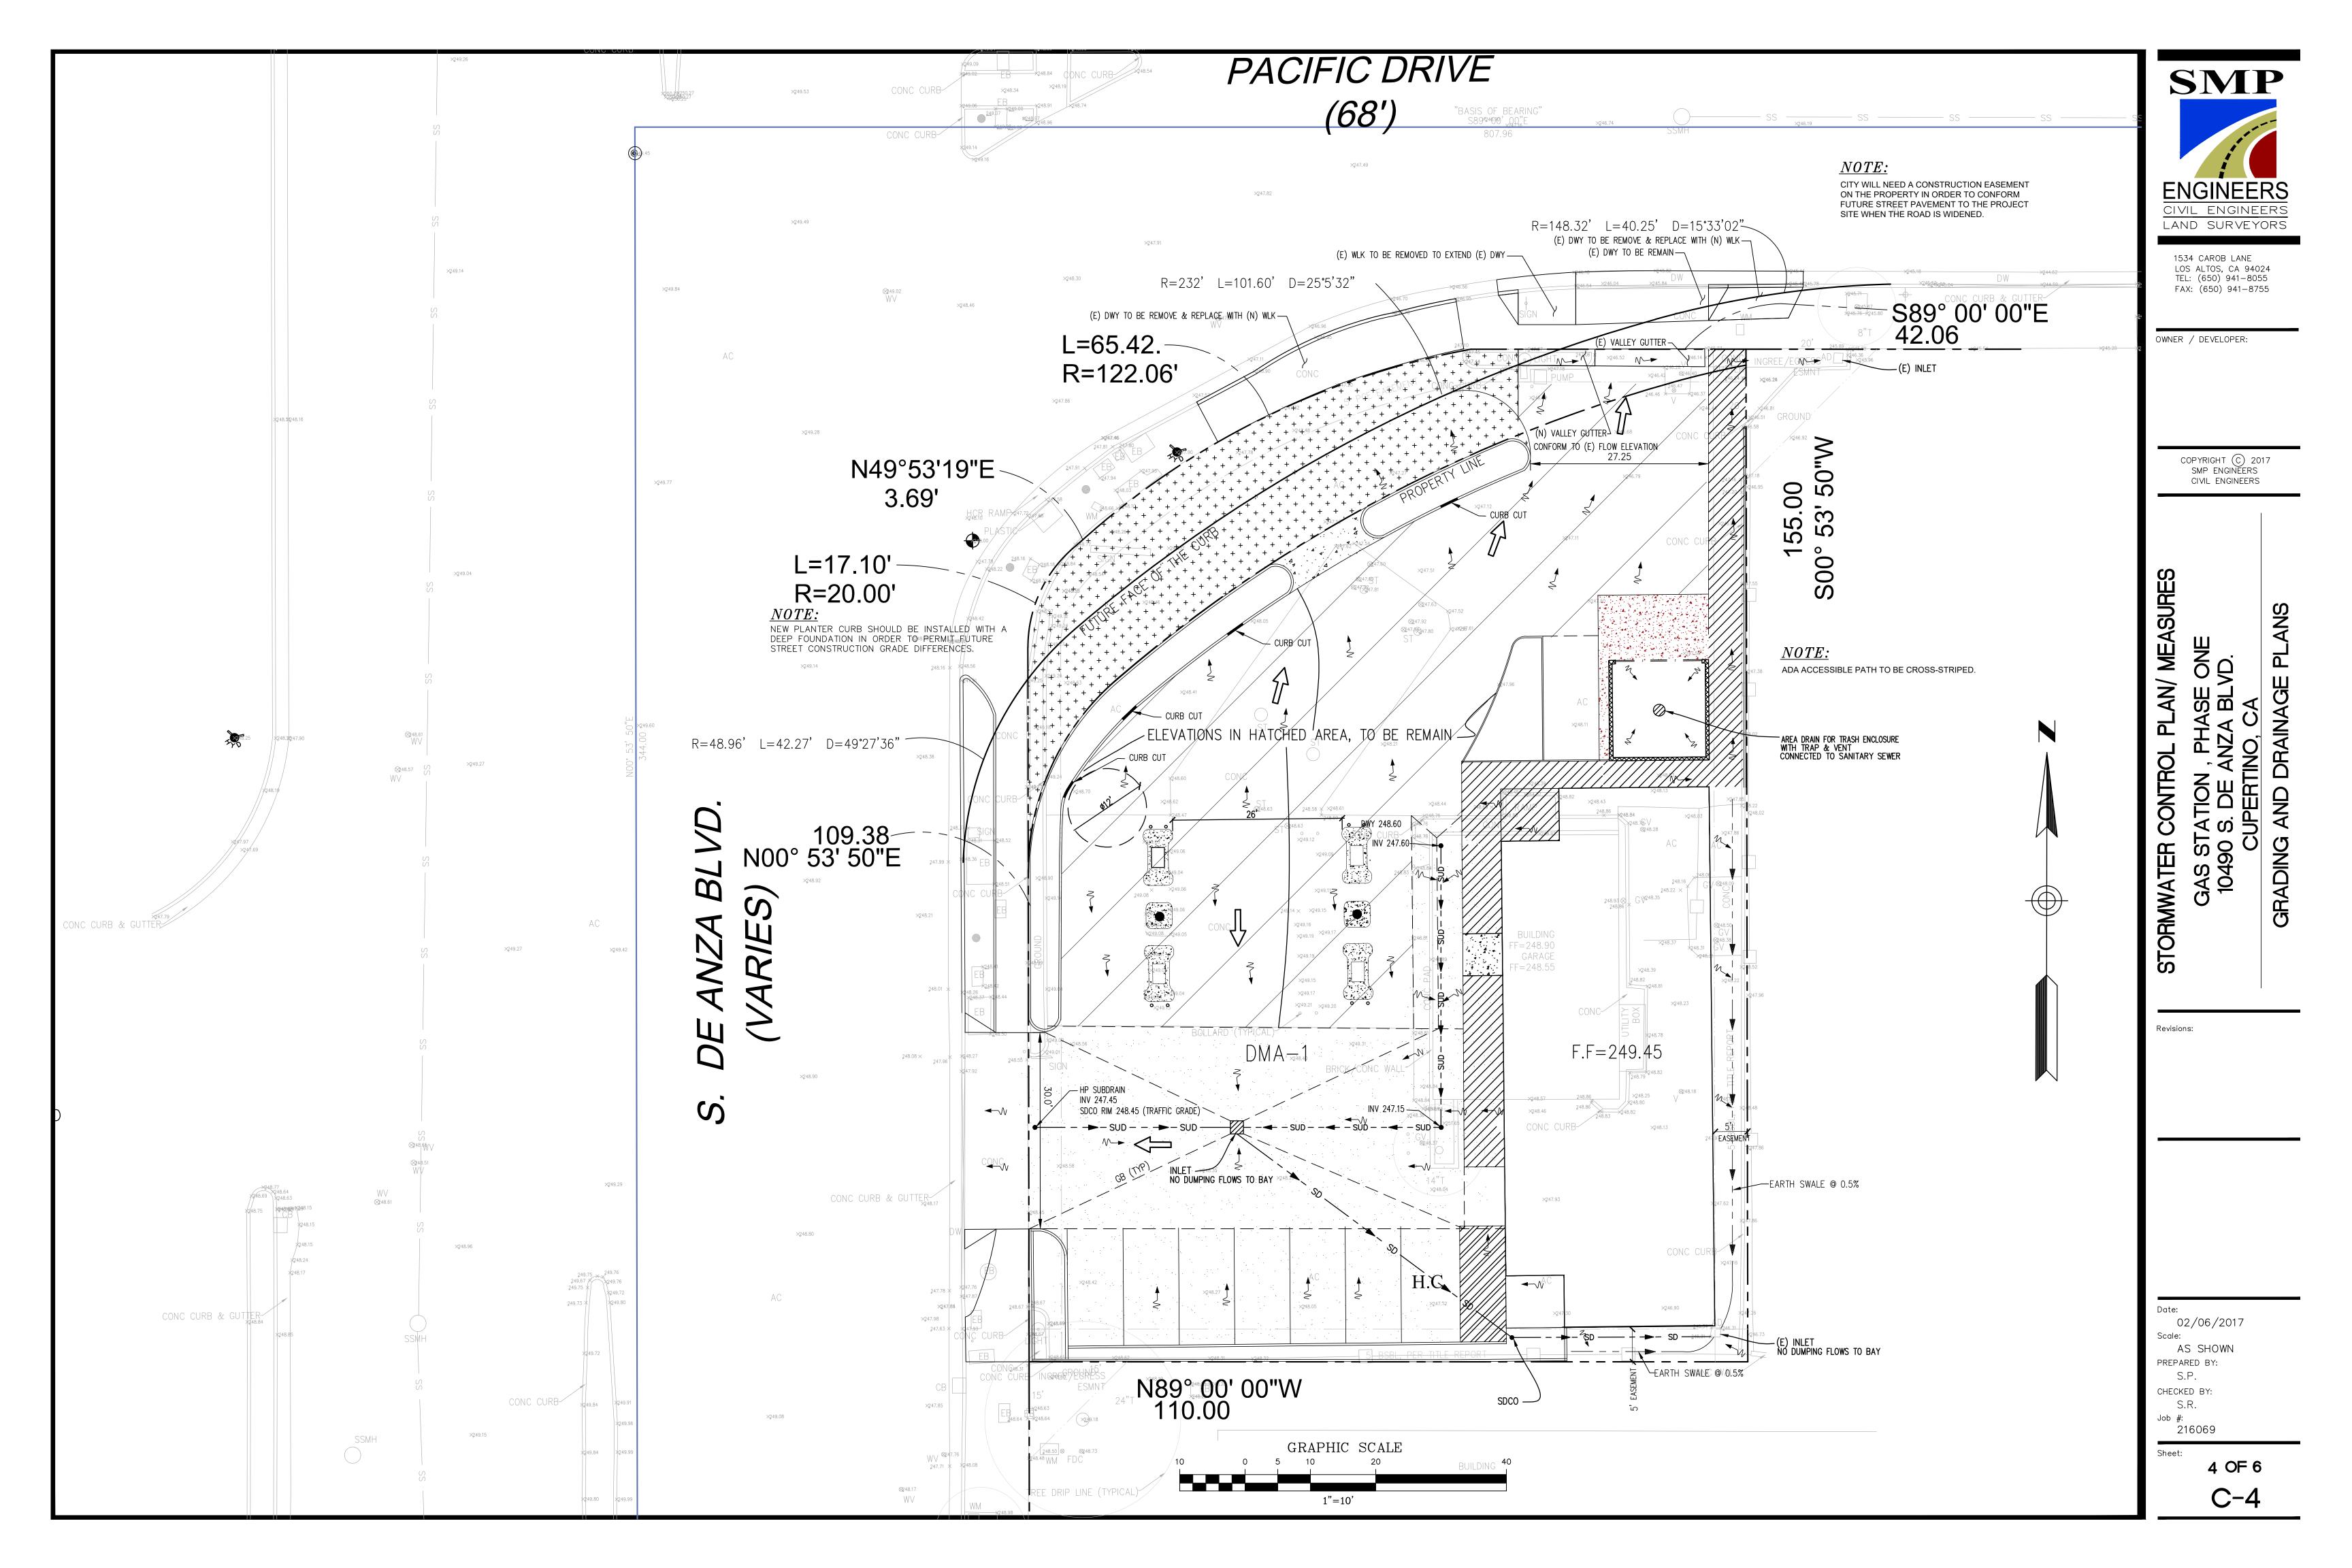

### Compliance with NPDES Permit Provision C.3:

The San Francisco Bay Regional Water Quality Control Board (SFRWQCB) incorporated updated requirements into Santa Clara County's National Pollution Discharge Elimination System (NPDES) Permit in August 06. These updated stormwater quality control requirements are predominantly in the category of new development discharge controls. The Permit requires that permanent, post-construction stormwater quality control measures be implemented as part of development projects.

- Updated stormwater quality control measures include:
- Source Control Measures Site Design Measures
- Treatment Control Measures

Beginning August 15, 2006, all projects creating or replacing 10,000 sq. ft. or more of impervious surface area must design and install a permanent post-construction stormwater treatment facility on the site. The system must be design and installed according to numeric sizing criteria.

All projects, regardless of size that create or replace impervious surface may be required to install stormwater quality controls to the maximum extent practicable.

This project proposes to implement appropriate source control and site design measures. The project creates/replaces LESS THAN 10,000 SQFT of impervious surface area, therefore, it is not required to provide stormwater treatment facilities based on numeric sizing criteria. However, the project proposes to implement stormwater treatment measures to maximize the removal of pollutants to the maximum extent practicable.

### <u>CONCRETE PAVEMENT MAINTENANCE :</u>

- 1. SWEEP THE PAVEMENT EVERY SIX MONTHS.
- 2. PRESSURE WASH WITH WATER AFTER SWEEPING EVERY SIX

### Source Control Measures:

— Covered material storage and Garage.

### Site Design Measures:

- Pervious Concrete driveway with underdrain, Maximized landscaping areas to promote on—site
- infiltration as much as possible. • Disconnected Roof downspouts & splash blocks that deflect the water away from the building and flow to on—site landscaped areas and
- Stormwater Treatment Measures:


NOT APPLICABLE


Earthswales.

### 


- Design shall be reviewed and approved by a licensed Geotechnical Engineer and the more conservative design shall govern.
- ii) Design for pervious concrete pavement shall be reviewed by the concrete manufacturer and the National Ready Mixed Concrete Association (NRMCA). A report of the suitability of the design shall be given to the Project Engineer prior to placement of the concrete.
- iii) Installation of pervious concrete shall only be done by contractors with celiification from NRMCA and such contractor shall have at least one foreman with this certification on the job site at all times.
- vi) All new pervious pavement shall have an infiltration rate of 100 in/hr when tested in accordance with ASTM Cl 701.
- viii) Protect excavated area from excessive compaction due to construction traffic and protect the finished pavement from construction traffic.


PRE-CONSTRUCTION VS. POST-CONSTRUCTION IM	PERVIOUS AREA	COMPARISO	N	
TOTAL GROSS SITE AREA (BEFORE DEDICATION)	16,097	SQFT		
TOTAL NET SITE AREA (AFTER DEDICATION)	14,173	SQFT		
PRE-CONSTRUCTION IMPERVIOUS AREA CALCULATION				
DESCRIPTION	AREA (SQFT.)	AREA (ACRES)	PERCENTAGE	MATERIAL
BUILDINGS	1,154			ROOFING
DRIVEWAY / WALKWAY	12,747	0.293	89.9%	AC/ CONCRETE
TOTAL PROJECT IMPERVIOUS AREA	13,901	0.319	98.1%	IMPERVIOUS
TOTAL PROJECT PERVIOUS AREA	272	0.006	1.9%	PERVIOUS
TOTAL SITE AREA	14,173	0.325	100.0%	
POST-CONSTRUCTION IMPERVIOUS AREA CALCULATION				
DESCRIPTION	AREA (SQFT.)	AREA (ACRES)	PERCENTAGE	MATERIAL
BUILDINGS	2,490	0.057	17.6%	ROOFING
COVERED PORCH	142	0.003	1.0%	ROOFING
TRASH PAD	235	0.005	1.7%	ROOFING
DRIVEWAY	5,446	0.125	38.4%	CONCRETE
WALKWAY, CURB	875	0.020	6.2%	CONCRETE
TOTAL PROJECT IMPERVIOUS AREA	9,188	0.211	64.8%	IMPERVIOUS
PERVIOUS DRIVEWAY	3,142	0.072	22.2%	PERVIOUS CONCRETI
LANDSCAPE	1,843	0.042	13.0%	PERVIOUS
TOTAL PROJECT PERVIOUS AREA	4,985	0.114	35.2%	PERVIOUS
TOTAL SITE AREA	14,173			
PRE VS. POST COMPARISON	AREA (SQFT.)	AREA (ACRES)	PERCENTAGE	
PROJECT IMPERVIOUS AREA REDUCTION	4,713	0.108	33.3%	

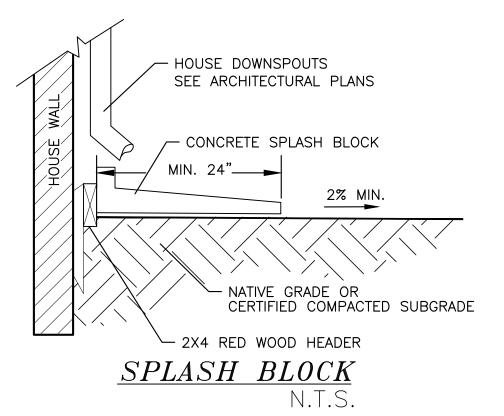


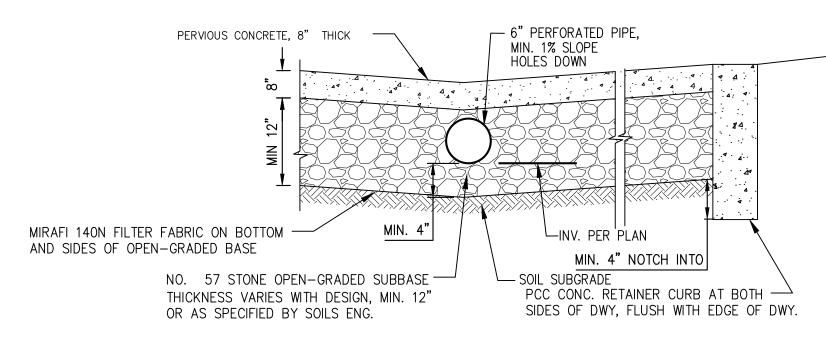


PERVIOUS CONCRETE PAVEMENT DETAIL

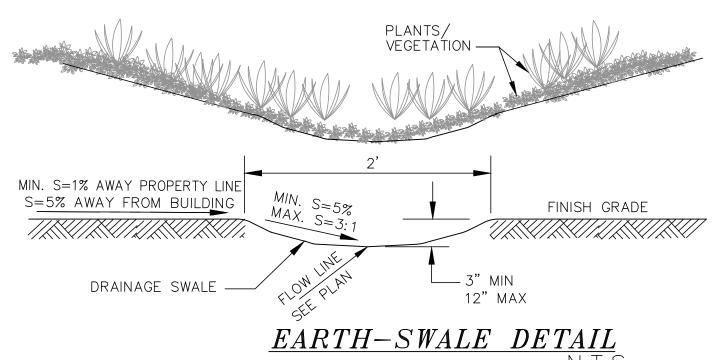

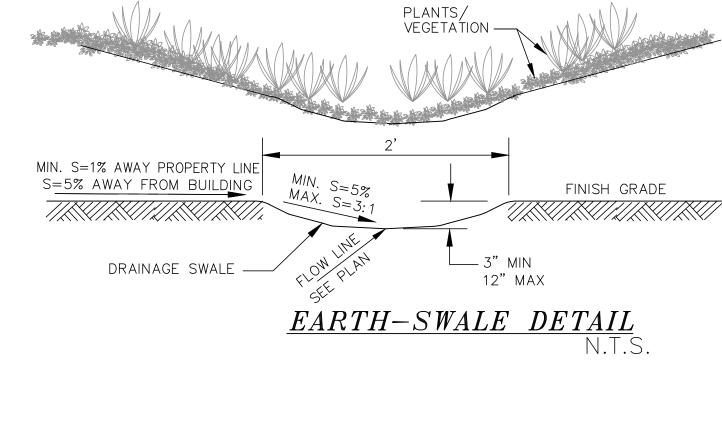

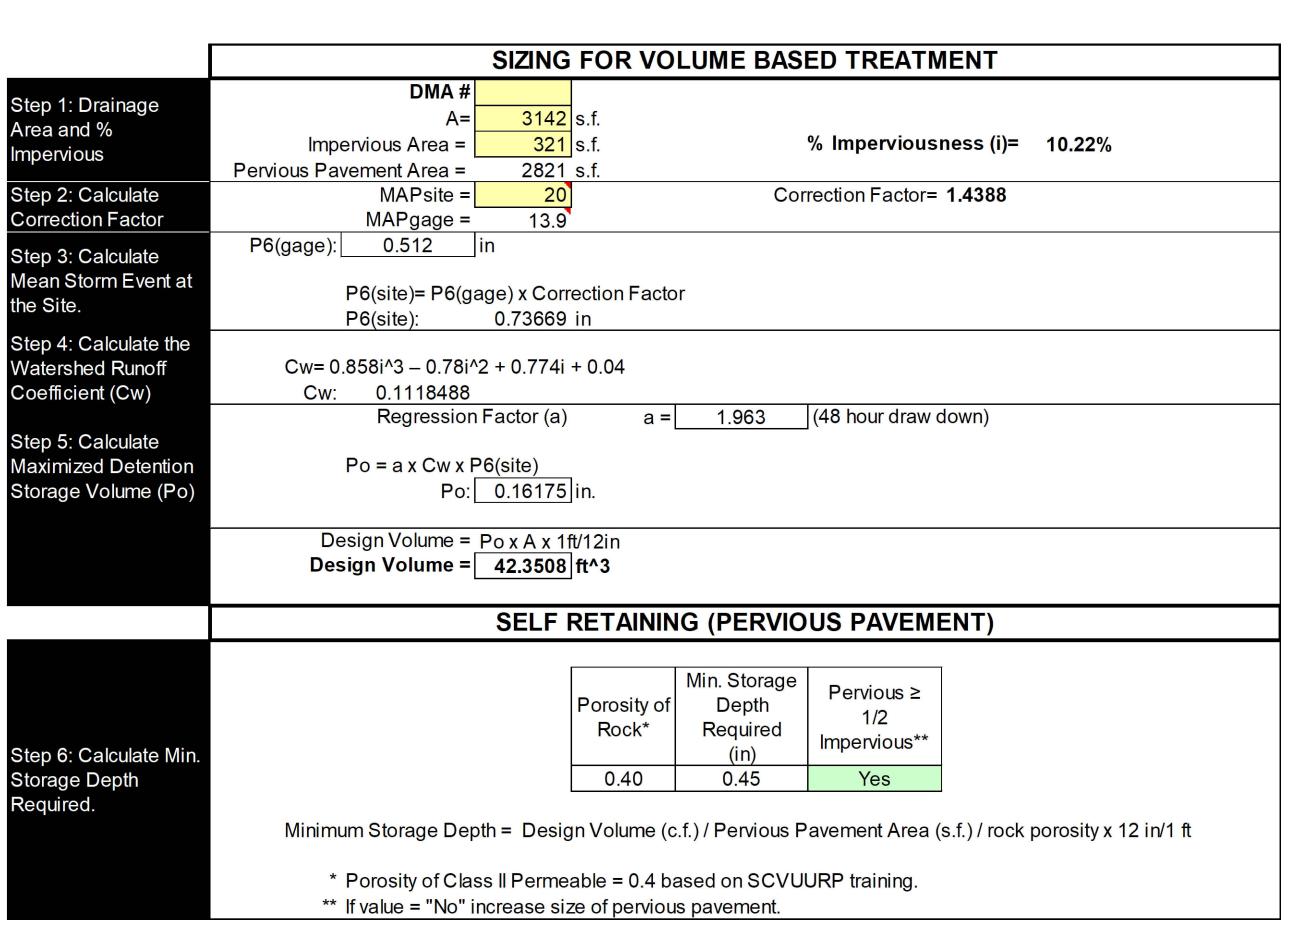

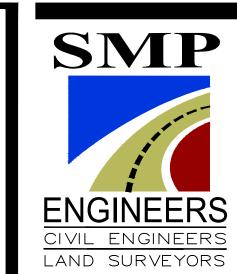

1534 CAROB LANE LOS ALTOS, CA 94024 TEL: (650) 941-8055 FAX: (650) 941-8755

OWNER / DEVELOPER:

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CIVIL ENGINEERS

GAS STAT 10490 S. CUP GRADING AN


STORMWATER


02/06/2017 AS SHOWN

PREPARED BY: S.P. CHECKED BY: S.R.

216069

Sheet: 5 OF 6

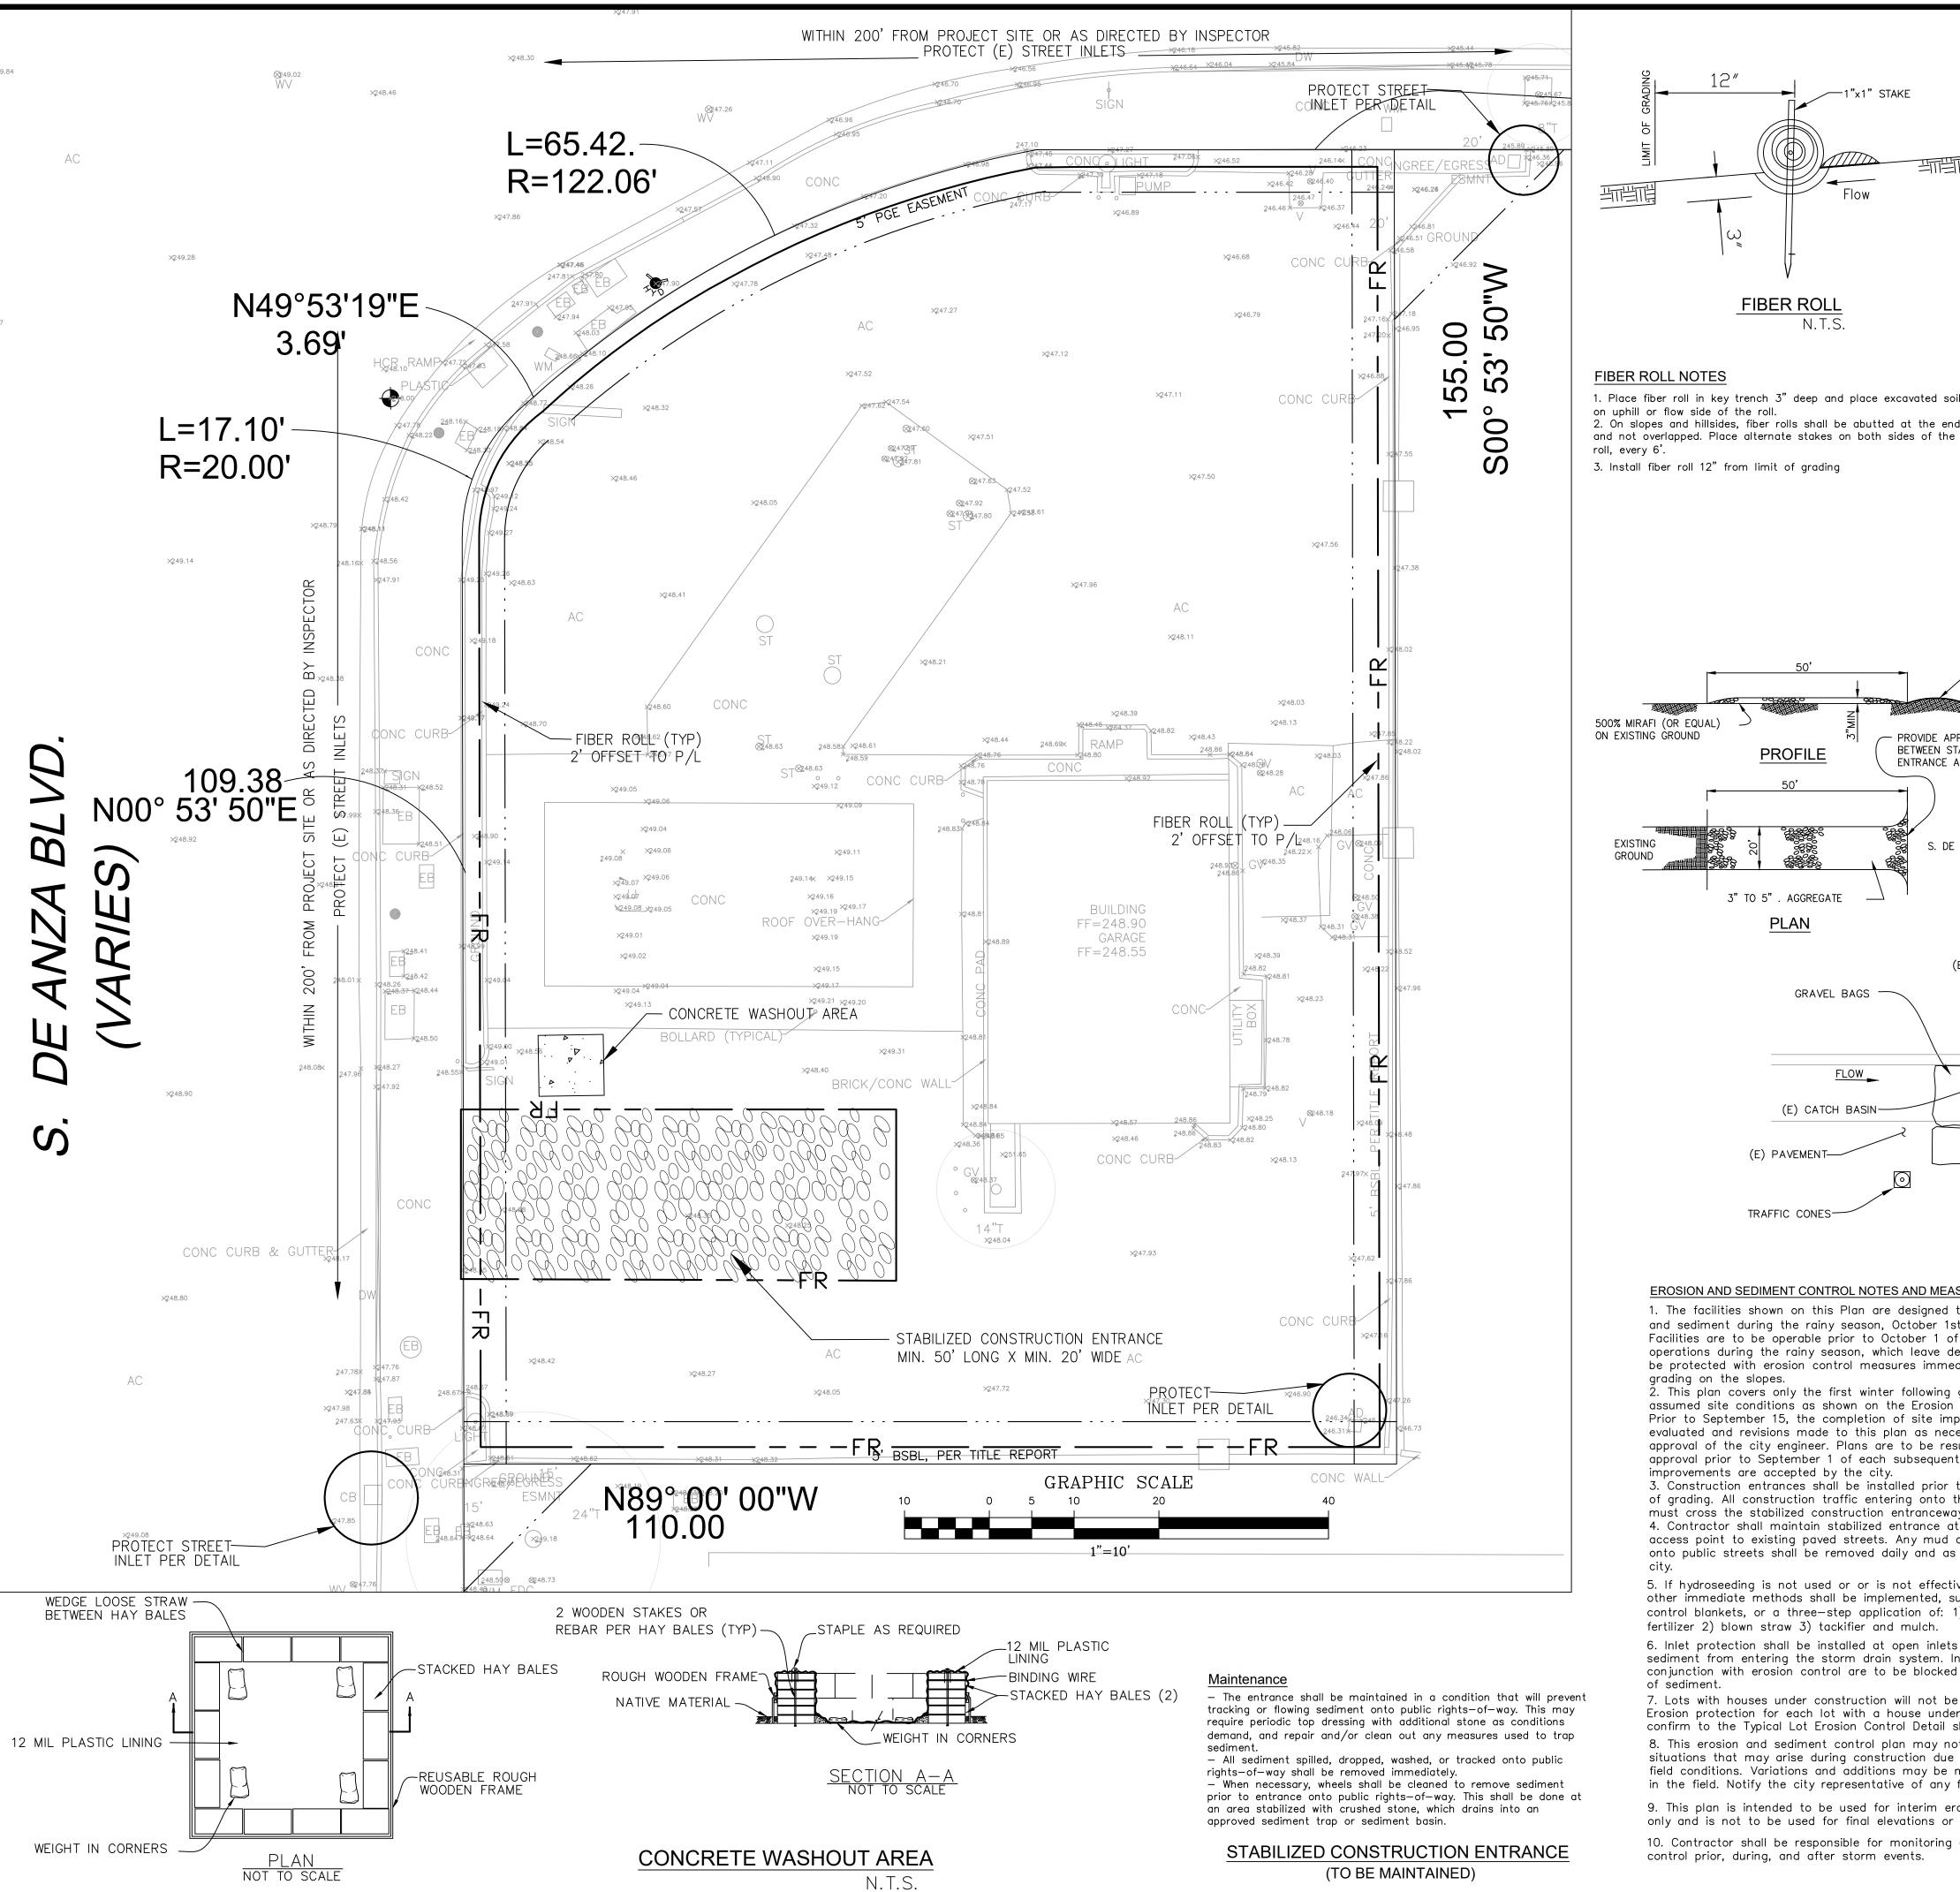


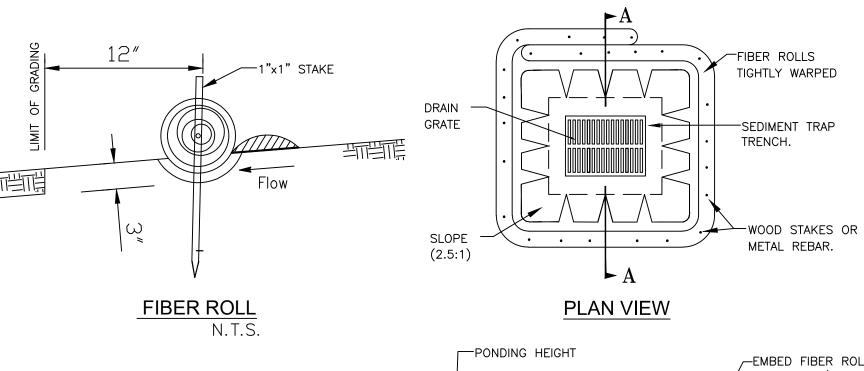

### FIBER ROLL NOTES

1. Place fiber roll in key trench 3" deep and place excavated soil on uphill or flow side of the roll. 2. On slopes and hillsides, fiber rolls shall be abutted at the ends

3. Install fiber roll 12" from limit of grading

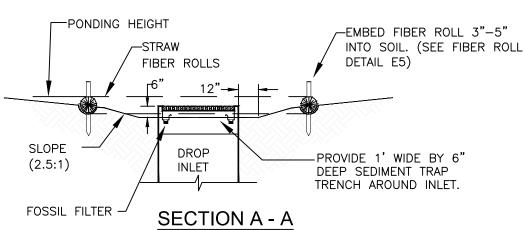

1. PLACE FIBER ROLLS AROUND THE INLET CONSISTENT WITH BASIN SEDIMENT BARRIER DETAIL ON THIS SHEET. FIBER ROLLS ARE TUBES MADE FROM STRAW BOUND W/ PLASTIC NETTING. THEY ARE APPROX. 8" DIA. AND 20 -16 FT. LONG


2. FIBER ROLL INSTALLATION REQUIRES THE PLACEMENT AND SECURE STAKING OF THE FIBER ROLL IN A TRENCH, 3" DEEP DUG ON CONTOUR. RUNOFF MUST NOT BE ALLOWED TO RUN UNDER OR AROUND FIBER ROLL.


3. THE TOP OF THE STRUCTURE (PONDING HEIGHT) MUST BE WELL BELOW THE GROUND ELEVATION DOWNSLOPE TO PREVENT RUNOFF FROM BY-PASSING 1 INLET. EXCAVATION OF A BASIN ADJACENT TO THE DROP INLET OR A TEMPORARY DIKE ON THE DOWNSLOPE OF THE STRUCTURE MAY BE NECESSARY.

4. FOSSIL FILTERS SHALL BE INCORPORATED IN ALL CATCH BASINS AND FIELD INLETS 24" AND LARGER AND SHALI BE INSTALLED PER MANUFACTURER SPECIFICATIONS. FOSSIL FILTERS ARE AVAILABLE FROM KRISTAR ENTERPRISES INC., 422 LARKFIELD CENTER, SUITE 271 SANTA ROSA, CA 95403, PHONE (800) 579-8819.

### STORM INLET SEDIMENT TRAP-FIBER ROLLS

N.T.S.

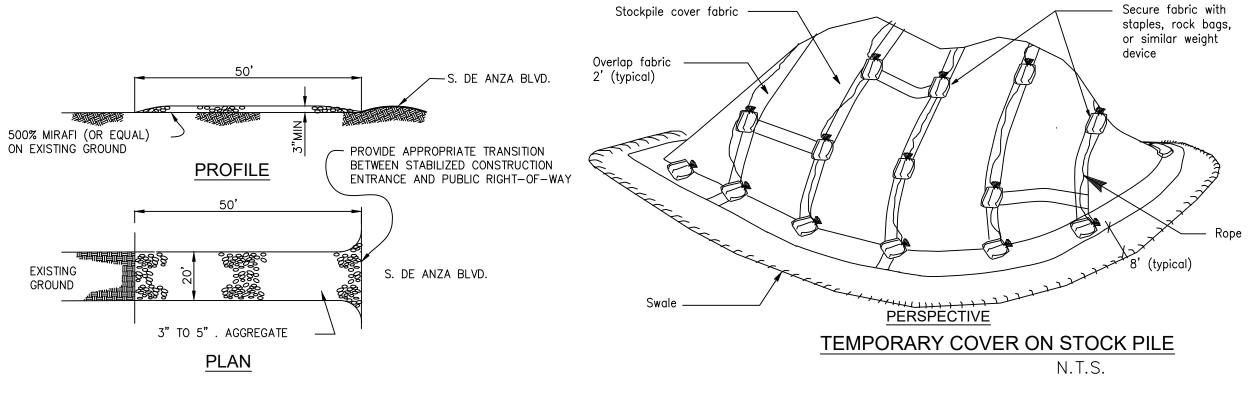

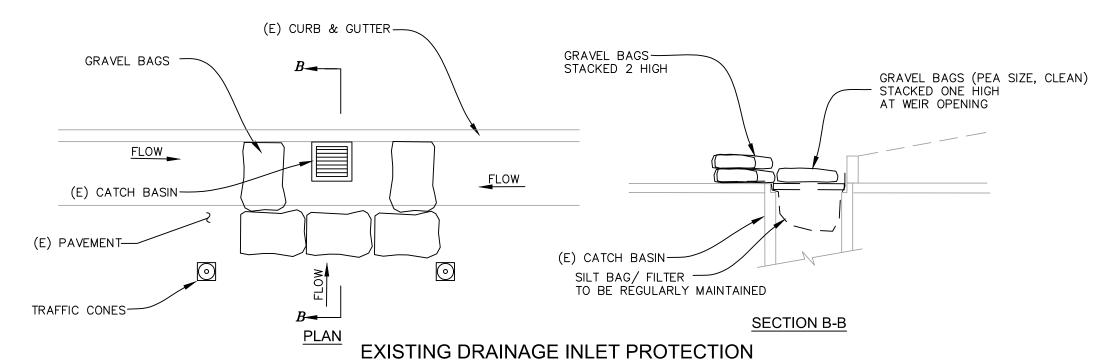

### EROSION AND SEDIMENT CONTROL NOTES AND MEASURES

1. The facilities shown on this Plan are designed to control Erosion and sediment during the rainy season, October 1st to April 30. Facilities are to be operable prior to October 1 of any year. Grading operations during the rainy season, which leave denuded slopes shall be protected with erosion control measures immediately following grading on the slopes.

2. This plan covers only the first winter following grading with assumed site conditions as shown on the Erosion Control Plan. Prior to September 15, the completion of site improvement shall be evaluated and revisions made to this plan as necessary with the approval of the city engineer. Plans are to be resubmitted for city approval prior to September 1 of each subsequent year until site improvements are accepted by the city. 3. Construction entrances shall be installed prior to commencement

of grading. All construction traffic entering onto the paved roads must cross the stabilized construction entranceways. 4. Contractor shall maintain stabilized entrance at each vehicle access point to existing paved streets. Any mud or debris tracked onto public streets shall be removed daily and as required by the

5. If hydroseeding is not used or or is not effectively 10/10, then other immediate methods shall be implemented, such as Erosion control blankets, or a three—step application of: 1) seed, mulch, fertilizer 2) blown straw 3) tackifier and mulch.

6. Inlet protection shall be installed at open inlets to prevent sediment from entering the storm drain system. Inlets not used in conjunction with erosion control are to be blocked to prevent entry of sediment.

7. Lots with houses under construction will not be hydroseeded Erosion protection for each lot with a house under construction shall confirm to the Typical Lot Erosion Control Detail shown on this sheet. 8. This erosion and sediment control plan may not cover all the situations that may arise during construction due to unanticipated field conditions. Variations and additions may be made to this plan in the field. Notify the city representative of any field changes.

9. This plan is intended to be used for interim erosion and sediment control

only and is not to be used for final elevations or permanent improvements. 10. Contractor shall be responsible for monitoring erosion and sediment control prior, during, and after storm events.

11. Reasonable care shall be taken when hauling any earth, sand, gravel, stone, debris, paper or any other substance over any public street, alley or other public place. Should any blow, spill, or track over and upon said public or adjacent private property, immediately remedy shall occur.

12. Sanitary facilities shall be maintained on the site.

N.T.S.

10. During the rainy season, all paved areas shall be kept clear of earth material and debris. The site shall be maintained so as to minimize sediment laden runoff to any storm drainage systems, including existing drainage swales and

13. Construction operations shall be carried out in such a manner that erosion and water pollution will be minimized. State and local laws concerning pollution abatement shall be complied with.

14. Contractors shall provide dust control as required by the appropriate federal,

state, and local agency requirements. 13. With the approval of the city inspector, erosion and sediment controls maybe removed after areas above them have been stabilized.

1. Maintenance is to be performed as follows:

A. Repair damages caused by soil erosion or construction at the end of each working day.

B. Swales shall be inspected periodically and maintained as needed. C. Sediment traps, berms, and swales are to be inspected after each storm and repairs made as needed.

D. Sediment shall be removed and sediment traps restored to its original dimensions when sediment has accumulated to a depth of

E. Sediment removed from trap shall be deposited in a suitable area and in such a manner that it will not erode.

F. Rills and gullies must be repaired. 2. All existing drainage inlets on St. George Lane within the limit of the project , shall be protected with sand bags during construction. See detail. Sand bag inlet protection shall be cleaned out whenever sediment depth is one half the height of one sand bag.

3. Existing concrete ditch sediment trap shall be cleaned out routinely during construction.

**SMP** CIVIL ENGINEERS LAND SURVEYORS

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OWNER / DEVELOPER:

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CIVIL ENGINEERS

02/06/2017


AS SHOWN

PREPARED BY: S.P.

CHECKED BY: S.R.

216069

Sheet: 6 OF 6

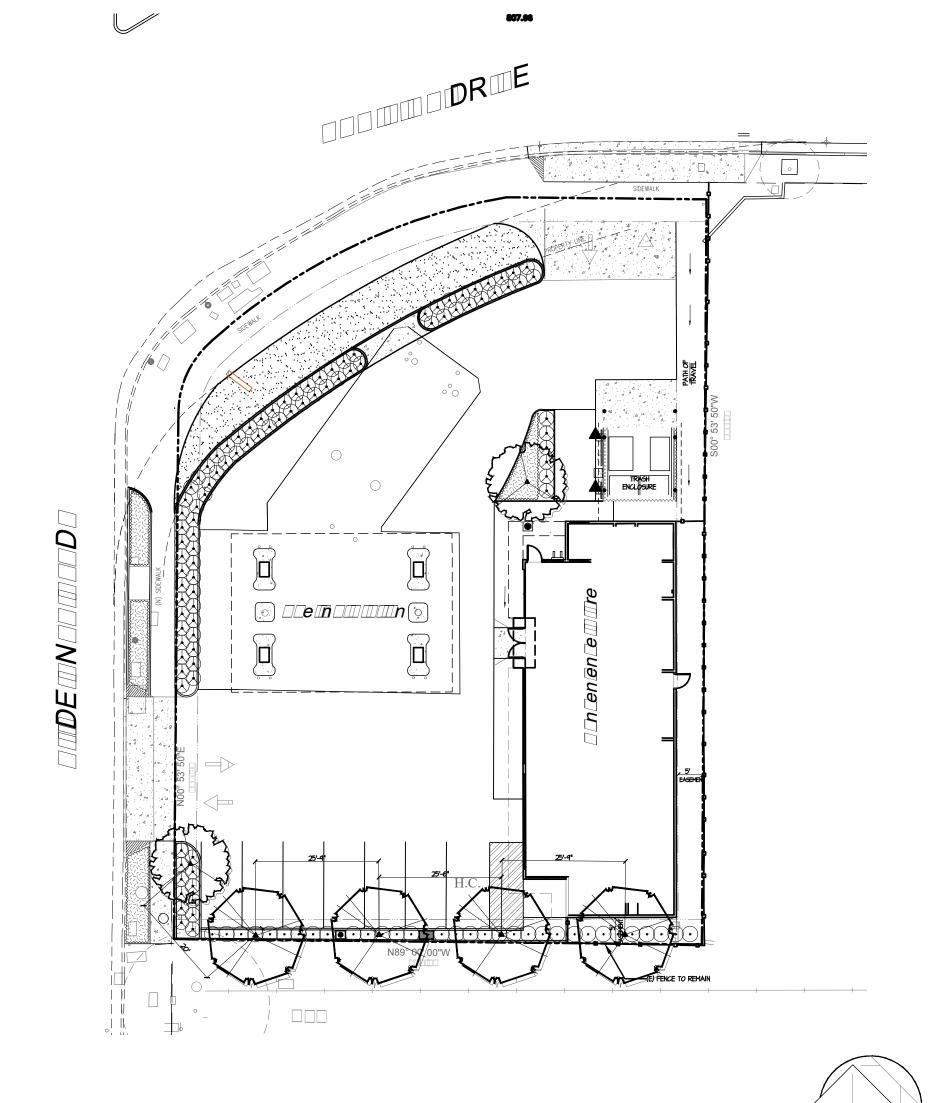







Dodonaea viscosa 'Purpurea'



Bouteloua gracilis

Blonde Ambition

Tilia tomentosa 'Sterling'



Lagerstroemia indica

PLANT IMAGES

Parthenocissus tricuspidata Boston Ivy (autumn/summer)

# LANDSCAPE PLAN - PHASE I

0.62 28.086

1"=20'-0"

Maxim	UIII F	Applied Ma	ter Allowar	106		-,0	Proposed L	_andscape	mater nee	
Eto	×	.45 X	Pltg 5 X	Gal./SF	MANA		Plant Type	H20 Use	Pitg SF	Gallons
45.3	3	0.45	2,101	0.62	26,554		Low	0.30	2,101	100.0%
							Medium	0.50	0	0.0%
							High	0.90	0	0.0%
								Totals	2,101	100%
Estima	ated	Total Mate	er Use							
Eto		Conv	Eto X	HA	PF	Irr	PF X HA	PF x HA	ETMU	
LLO	2	CONV	.62	105		11 1	II ALIA	/ IRR		
45	5.3	0.62	28.086	0	0.9	0.81	0	0	0	


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630 118 21,855


630 Total 21,855

0 0.5 0.81

0.62 28.086 2,101 0.3 0.81 Sub Total 2,101

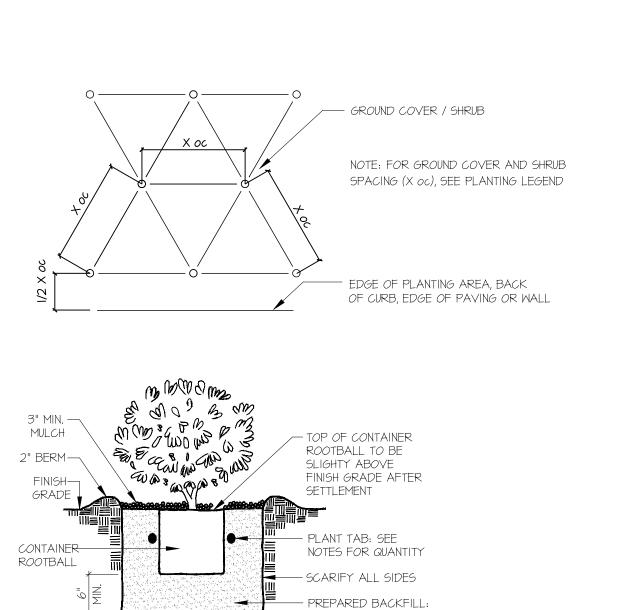

SEE NOTES

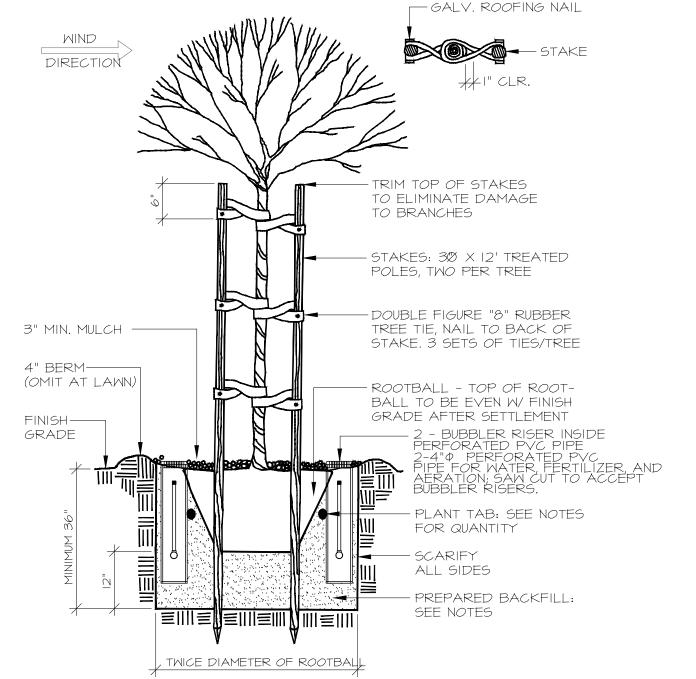




Ciardella	640 Menlo Ave, Suite Menlo Park, CA 940
	Tel 650 326 61
Landscape Architecture	F 650 285 45
Urban Design	ca@ciardella-assoc.co

### PLANTING LEGEND

BOTANICAL NAME COMMON NAME H20 SIZE

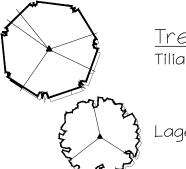

Symbol

Tilia tomentosa 'Sterling' Sterling Silver Linden) L 15 Gallon

Boston Ivy

L | Gallon

Lagerstroemia indica 'Tuscarora Tuscarora L 15 Gallon

Shrubs and Vines

▲ Parthenocissus tricuspidata

O Dodonaea viscosa 'Purpurea' - Purple-leafed Hop-bush L 5 Gallon ⊕ Bouteloua gracilis Blonde Ambition L 5 Gallon

Ground Cover ROS Rosemarinus offic. 'Hunt.Car.' Huntington L | Gallon @ 30" oc Delta Native Bentgrass L Sod GRA Agrostis pallens

ROS

### PLANTING NOTES

- I. All trees are to be staked as shown in the staking diagram per city requirement.
- 2. Plant locations are to be adjusted as necessary to screen utilities but not block windows or
- 3. All ground cover and shrub areas shall be top-dressed with a 3" layer of bark mulch. 4. All ground cover planting will be placed no farther than 6" from edge of pavement, edge of header or back of curb. Spacing shall ensure full coverage in one year.
- 5. There shall be no storing of material or equipment, permitting of any burning or operating or parking of equipment under branches of any existing plants to remain. If existing plants to remain are damaged during construction, the plants shall be replaced with the same species an size as
- 6. All plant material shall be nursery grown stock. All plant materials shall be tagged at the nursery at least I month prior to planting for the Landscape Architects review.
- 7. Review layout of all landscape elements with the Landscape Architect prior to installation Field modifications may be necessary. Final layout to be reviewed by the Landscape Architect. 8. Written dimensions supersede scaled dimension Measurements are from the wall face, back of curb. edge of walk, buil'ding wall, property line or center line as graphically indicated. 9. All layout corners are at 90 degrees right angles unless otherwise indicated. All curves shown
- are seqments of circles with noted radii or diameter if noted. Circles can be scaled and be connected by freeform curves.
- 10. HERBICIDE APPLICATION: Herbicide shall not be used until all plant material has been planted a minimum of 20-days. All planting areas shall be kept weed-free by non-herbicide method's during this time period. Herbicide shall not be applied to any areas which are or have been seeded. Contractor must be licensed by the State and County for fertilizer application, and must have current registration on file with the County.
- II. Landscáping shall be maintained in a mánner to prevent landscaping from growing above 3' in height in the areas indicated in the plans as being located within a safety visibility triangle area. 12. CERTIFICATION: Prior to occupancy, the Landscape Architect shall certify in writing in a manner acceptable to the Building inspection Division, that the landscaping has been installed in
- accordance with all aspects of the approved landscape plans. 13. A minimum of 8" of non-mechanically compacted soil shall be available for water absorption and root growth in planted areas.
- 14. Incorporate compost or natural fertilizer into the soil to a minimum depth of 8" at a minimum rate of 6 cubic yards per 1000 square feet.

  15. All Plantings shall be automatically irrigated utilizing state of the art system, components and
- installation techniques and drip irrigation where appropriate and a weather based controller. 16. All planting and irrigation shall comply with the city of City of Cupertino Water Efficient
- Landscape Requirements for larger landscapes. 17. All details shall comply with city standard details.

LAI	10490	
REVISIONS		
ITEN	Ю.	DATE


S. DE ANZ CUPERTINO, 6

A.G.p.

Design Group

Campbell, CA 95008 Tel:(408) 316.6168 E-Mail:agp@pacbell.net

PLOT SCALE:	12"=1'-
DRAWN BY:	R
CHECKED BY:	R
PROJECT NO:	DAT
SCALE: AS SHOWN	11-15-

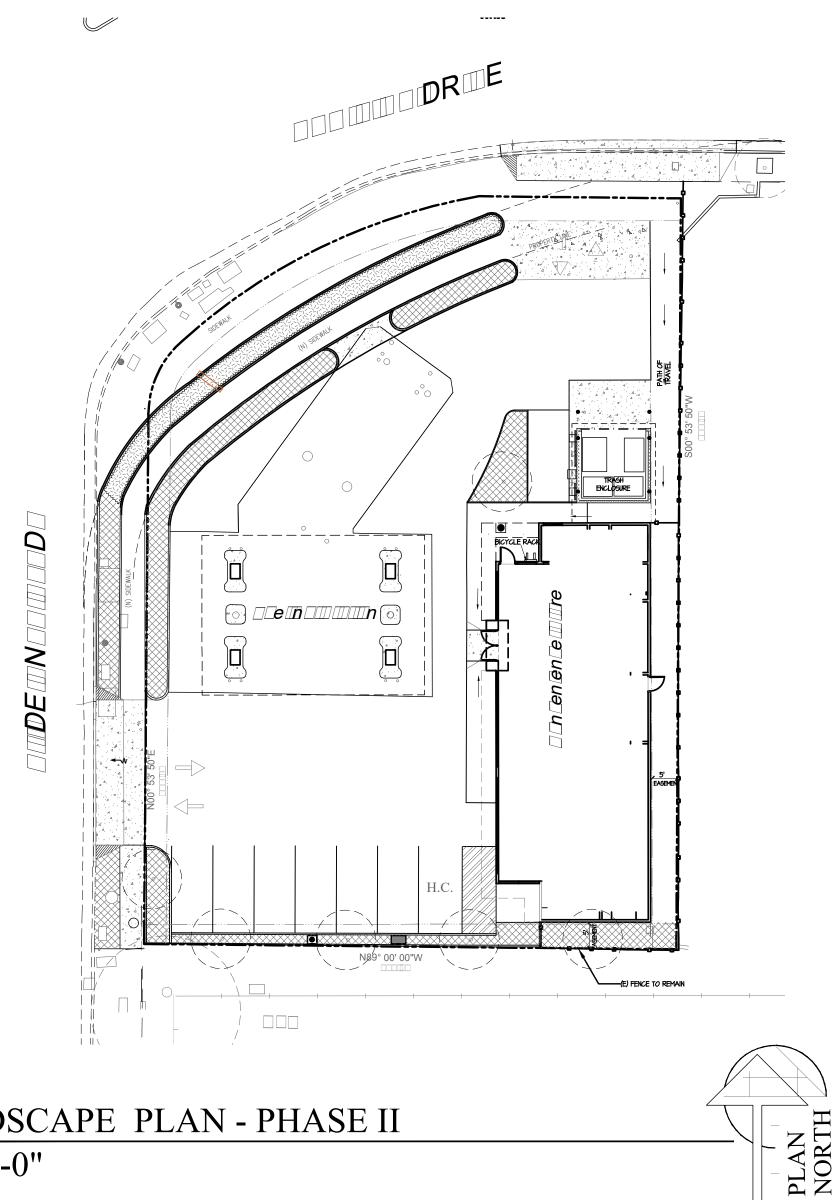

Proposed Landscape Water Use

Rosemarinus offic.


## PLANT IMAGES


## LANDSCAPE PLAN - PHASE II

1"=20'-0"

Maximum Applied Mater Allowance

Eto	×	.45 X	Pltg 5 X	Gal./SF	MANA	r .	Plant Type	H20 Use	Pitg SF	Gallons
45.3	3	0.45	435	0.62	5,498	(	Low	0.30	435	100.0%
							Medium	0.50	0	0.0%
							High	0.90	0	0.0%
								Totals	435	100%
Estim	ated	Total Mate	r Use							
Eta		Conv	Eto X	HA	PF	Irr	PF X HA	PF x HA	ETMU	
			.62							
4	5.3	0.62	.62 28.086	0	0.9	0.81	0	0	0	
1000	5.3 5.3	COMMONSTAL 148	20018/ASPERO	0	0.9 0.5	0.81 0.81	0	92 3510071800	0	
4		0.62	28.086	West .		1570	V/-	0	20.0	
4	5.3	0.62 0.62 0.62	28.086 28.086	0	0.5	0.81	0	0	0	

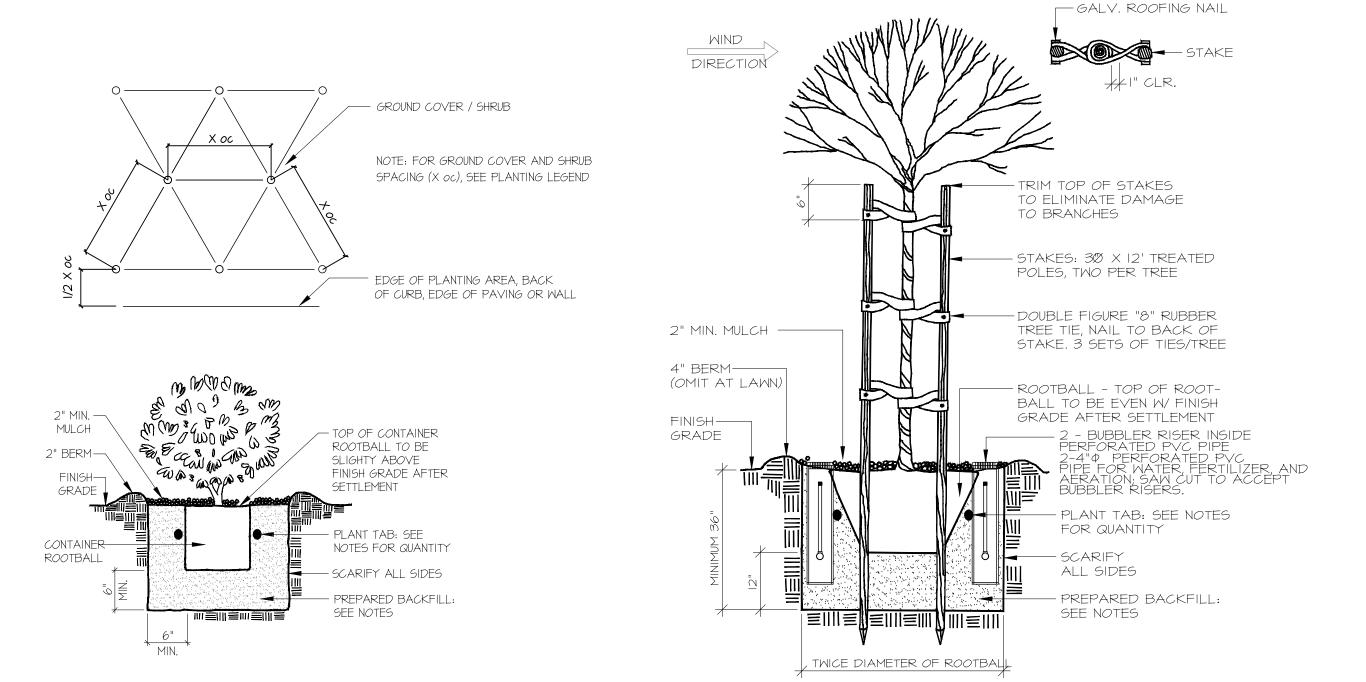

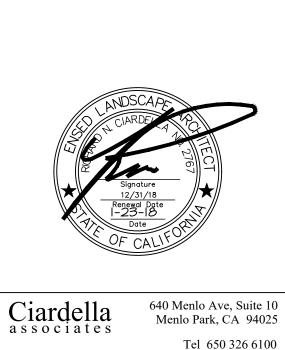

F 650 285 4537

ca@ciardella-assoc.com

Landscape Architecture

Urban Design

## PLANTING LEGEND

Symbol

BOTANICAL NAME COMMON NAME H20 SIZE





Existing Tree to remain

Ground Cover

ROS Rosemarinus offic. 'Hunt.Car.' Huntington L | Gallon @ 30" oc

ROS

Existing Landscape to Remain

### PLANTING NOTES

- I. All trees are to be staked as shown in the staking diagram per city requirement. 2. Plant locations are to be adjusted as necessary to screen utilities but not block windows or impede access.
- 3. All ground cover and shrub areas shall be top-dressed with a 3" layer of bark mulch. 4. All ground cover planting will be placed no farther than 6" from edge of pavement, edge of header or back of curb. Spacing shall ensure full coverage in one year.
- 5. There shall be no storing of material or equipment, permitting of any burning or operating or parking of equipment under branches of any existing plants to remain. If existing plants to remain are damaged during construction, the plants shall be replaced with the same species an size as those damaged.
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- Landscape Requirements for larger landscapes. 17. All details shall comply with city standard details.



CUPERTINO, DE 0490

REVISIONS ITEMO. DATE

PLOT SCALE: 12"=1'-0" DRAWN BY: CHECKED BY: DATE: PROJECT NO: SCALE: AS SHOWN 11-15-17








SOUTH








SOUTH

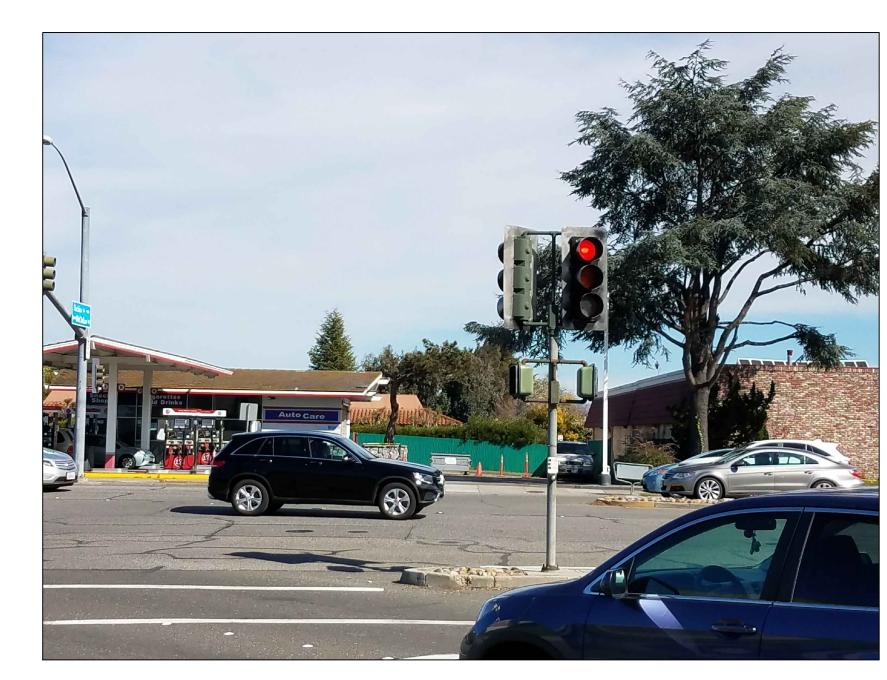

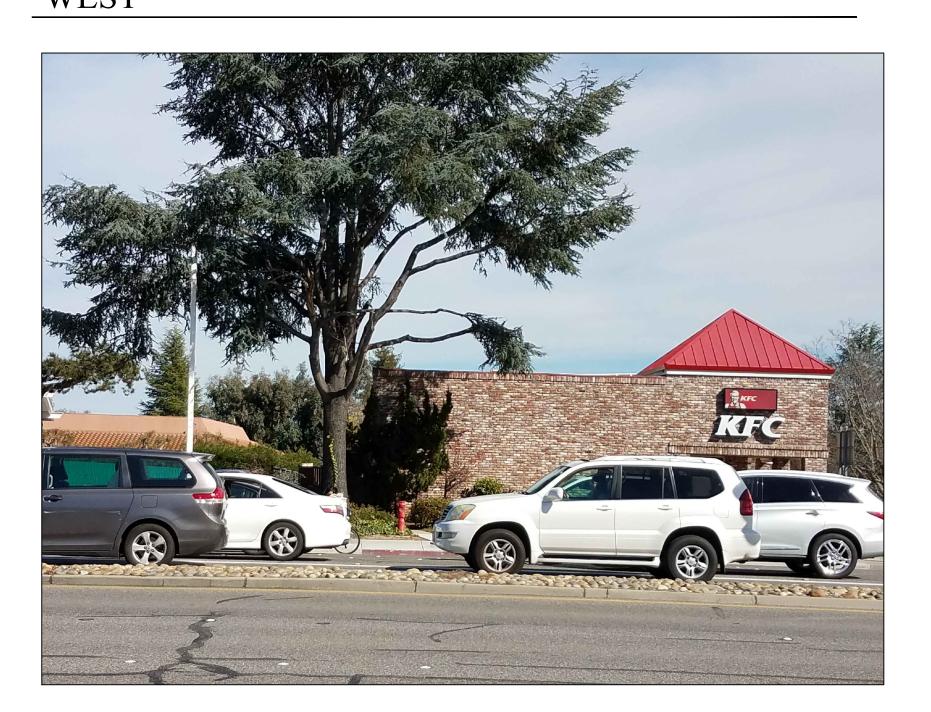



EAST

PLOT SCALE: 12"=1'-0"

DRAWN BY: AK

CHECKED BY: MF

PROJECT NO: DATE:

SCALE: AS SHOWN 07-6-16

NO. ITEM

PH.0

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PACIFIC ST./ DE ANZA BLVD.- NORTH



PACIFIC ST.- SOUTH

A.G.p.	
Besign Group	1296 Virginia ave. Campbell, CA 95008 Tel:(408) 316.6168 E-Mail:agp@pacbell.net

PROJECT NAME:	PROJECT NO.:
РНОТО	
SCALE:	DATE:

8/28/2016

N.T.S

PROJECT TITLE:

76 Gas Stations 10490 S. De Anza Blvd. CUPERTINO. CA SHEETNO.:



PACIFIC ST.- WEST



PACIFIC ST.- EAST

A.G.p.	
45)	1296 Virginia ave. Campbell, CA 95008 Tel:(408) 316.6168 E-Mail:agp@pacbell.net
Design Croup	

PROJECT NAME:	PROJECT NO.:
РНОТО	
SCALE:	DATE:
N.T.S	8/28/2016

PROJECT TITLE:

76 Gas Stations 10490 S. De Anza Blvd. CUPERTINO. CA SHEETNO.:



DE ANZA BLVD.- SOUTH



DE ANZA BLVD.- NORTH

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Besign Group	

PROJECT NAME: PHOTO	PROJECT NO.:
SCALE:	DATE:
NTS	8/28/2016

PROJECT TITLE:

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DE ANZA BLVD.- WEST



DE ANZA BLVD.- EAST

A.G.p.	
45>	1296 Virginia ave. Campbell, CA 95008 Tel:(408) 316.6168 E-Mail:agp@pacbell.net
Desion Group	

PROJECT NAME:	PROJECT NO.:
РНОТО	
SCALE:	DATE:

N.T.S

8/28/2016

PROJECT TITLE:

76 Gas Stations 10490 S. De Anza Blvd. CUPERTINO. CA SHEETNO.:

