





Hirano–Mahoney Residence

11406 LINDY PLACE  
Cupertino, California 94025  
A.P.N. 356-024-011  
TRACT: 3354 LOT: 35 189 MAPS 55

REVISION REFLECTS REDUCED SCOPE OF WORK & LOWER FLOOR AREA FOR PROPOSED POOL HOUSE.



REVISIONS	BY
06-7-17	A.Ort

CHARLES  
HOLMAN

DESIGN

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SAN GREGORIO  
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650.747.0769  
charlie.holman@highland.net

11406 Lindy Place  
Cupertino, California 94025

A.P.N. 356-024-011

PROJECT TEAM

DESIGN:  
CHARLES HOLMAN DESIGN  
P.O. BOX 63  
SAN GREGORIO, CA 94074  
TEL. (650) 747-0769

OWNER:  
BERNADETTE MAHONEY & KELLY HIRANO  
11406 LINDY PLACE  
CUPERTINO, CA. 94025

CIVIL ENGINEER:  
LEA & BRAZE ENGINEERING, INC  
2405 INDUSTRIAL PKWY WEST  
HAYWARD, CA. 94545  
TEL. (510) 887-4086  
FAX. (510) 887-3019

PROJECT DATA

LOT AREA: .53 ACRES (23,086.8 SQ.FT.)  
(22,930-10,000 / 1,000) 59.59

13,086.8 X 59.59 = 779.84 SQ.FT.  
779.84 + 4,500 = 5,279.84 SQ.FT.  
AVERAGE SLOPE = 35.5% (30% REDUCTION FACTOR)  
5,279.84 X .30 = 1,583.952  
5,279.84 - 1,583.952 = 3,695.888 (ALLOWED F.A.L.)  
(E) HOUSE (MAIN FLOOR) : 2,475.5 SQ.FT.  
(E) HOUSE (LOWER FLOOR) : 807.5 SQ.FT.  
TOTAL FOR (E) HOUSE : 3,283.00 SQ.FT.  
(N) PROPOSED POOL HOUSE : 412.00 SQ.FT.  
TOTAL PROPOSED : 3,695.00 < 3,695.888

• 310 SQ.FT. BASEMENT BELOW GRADE NOT INCLUDED.

SHEET INDEX

1. COVER SHEET
  2. PROPOSED FULL SITE PLAN
  3. PROPOSED PARTIAL SITE PLAN
  - 3.1 SURVEY
  4. EXISTING SITE PLAN
  5. PROPOSED POOL HOUSE FLOOR PLAN
  6. PROPOSED POOL HOUSE ELEVATIONS
  7. PROPOSED POOL HOUSE ROOF PLAN
  8. PROPOSED SECTIONS A,B,& C
  9. EXISTING MAIN (UPPER) LEVEL AREA CALC'S
  10. EXISTING LOWER LEVEL, BASEMENT & POOL HOUSE AREA CALC'S
- C-1 TITLE SHEET  
C-2 GRADING & DRAINAGE PLAN  
C-3 SECTION PROFILE

SCOPE OF WORK:

- 1-CONSTRUCTION OF A NEW SINGLE STORY POOL HOUSE AND POOL.
- 2-FILL EXISTING POOL AND EXPAND EXISTING PATIO.
- 3-NEW POOL HOUSE TO FEATURE AN OUTDOOR COVERED DINING AREA AND ROOF DECK CONNECTED TO EXISTING MAIN HOUSE.

PROJECT INFORMATION

LOT SIZE 22,930.0 SQ. FT. (.53 ACRES)  
A.P.N. 010-165-036-000  
LEGAL DESCRIPTION LOT: 35 TRK: 3355  
ZONING RHS-21  
OCCUPANCY GROUP R-3  
BUILDING TYPE V-B  
STORIES 1  
FIRE SPRINKLERS NO  
SETBACKS (MIN. ALLOWED) FRONT: 20' SIDE: 10' REAR: N/A  
HEIGHT (MAX. ALLOWED) 20'

VICINITY MAP

NOT TO SCALE



JOB NO.  
01-16

ISSUE DATE  
04-28-16

DRAWN BY  
Alejandro J. Ort

COVER SHEET

SCALE 1/4"=1'

1.0









PICTURE - 1



PICTURE - 2



PICTURE - 3



PICTURE - 4



PICTURE - 5



PICTURE - 6



PICTURE - 7



PICTURE - 8



PICTURE - 9



PICTURE - 10



PICTURE - 11



PICTURE - 12



PICTURE - 13



PICTURE - 14

REVISIONS

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11496 Lindy Place  
Agoura, California 91301

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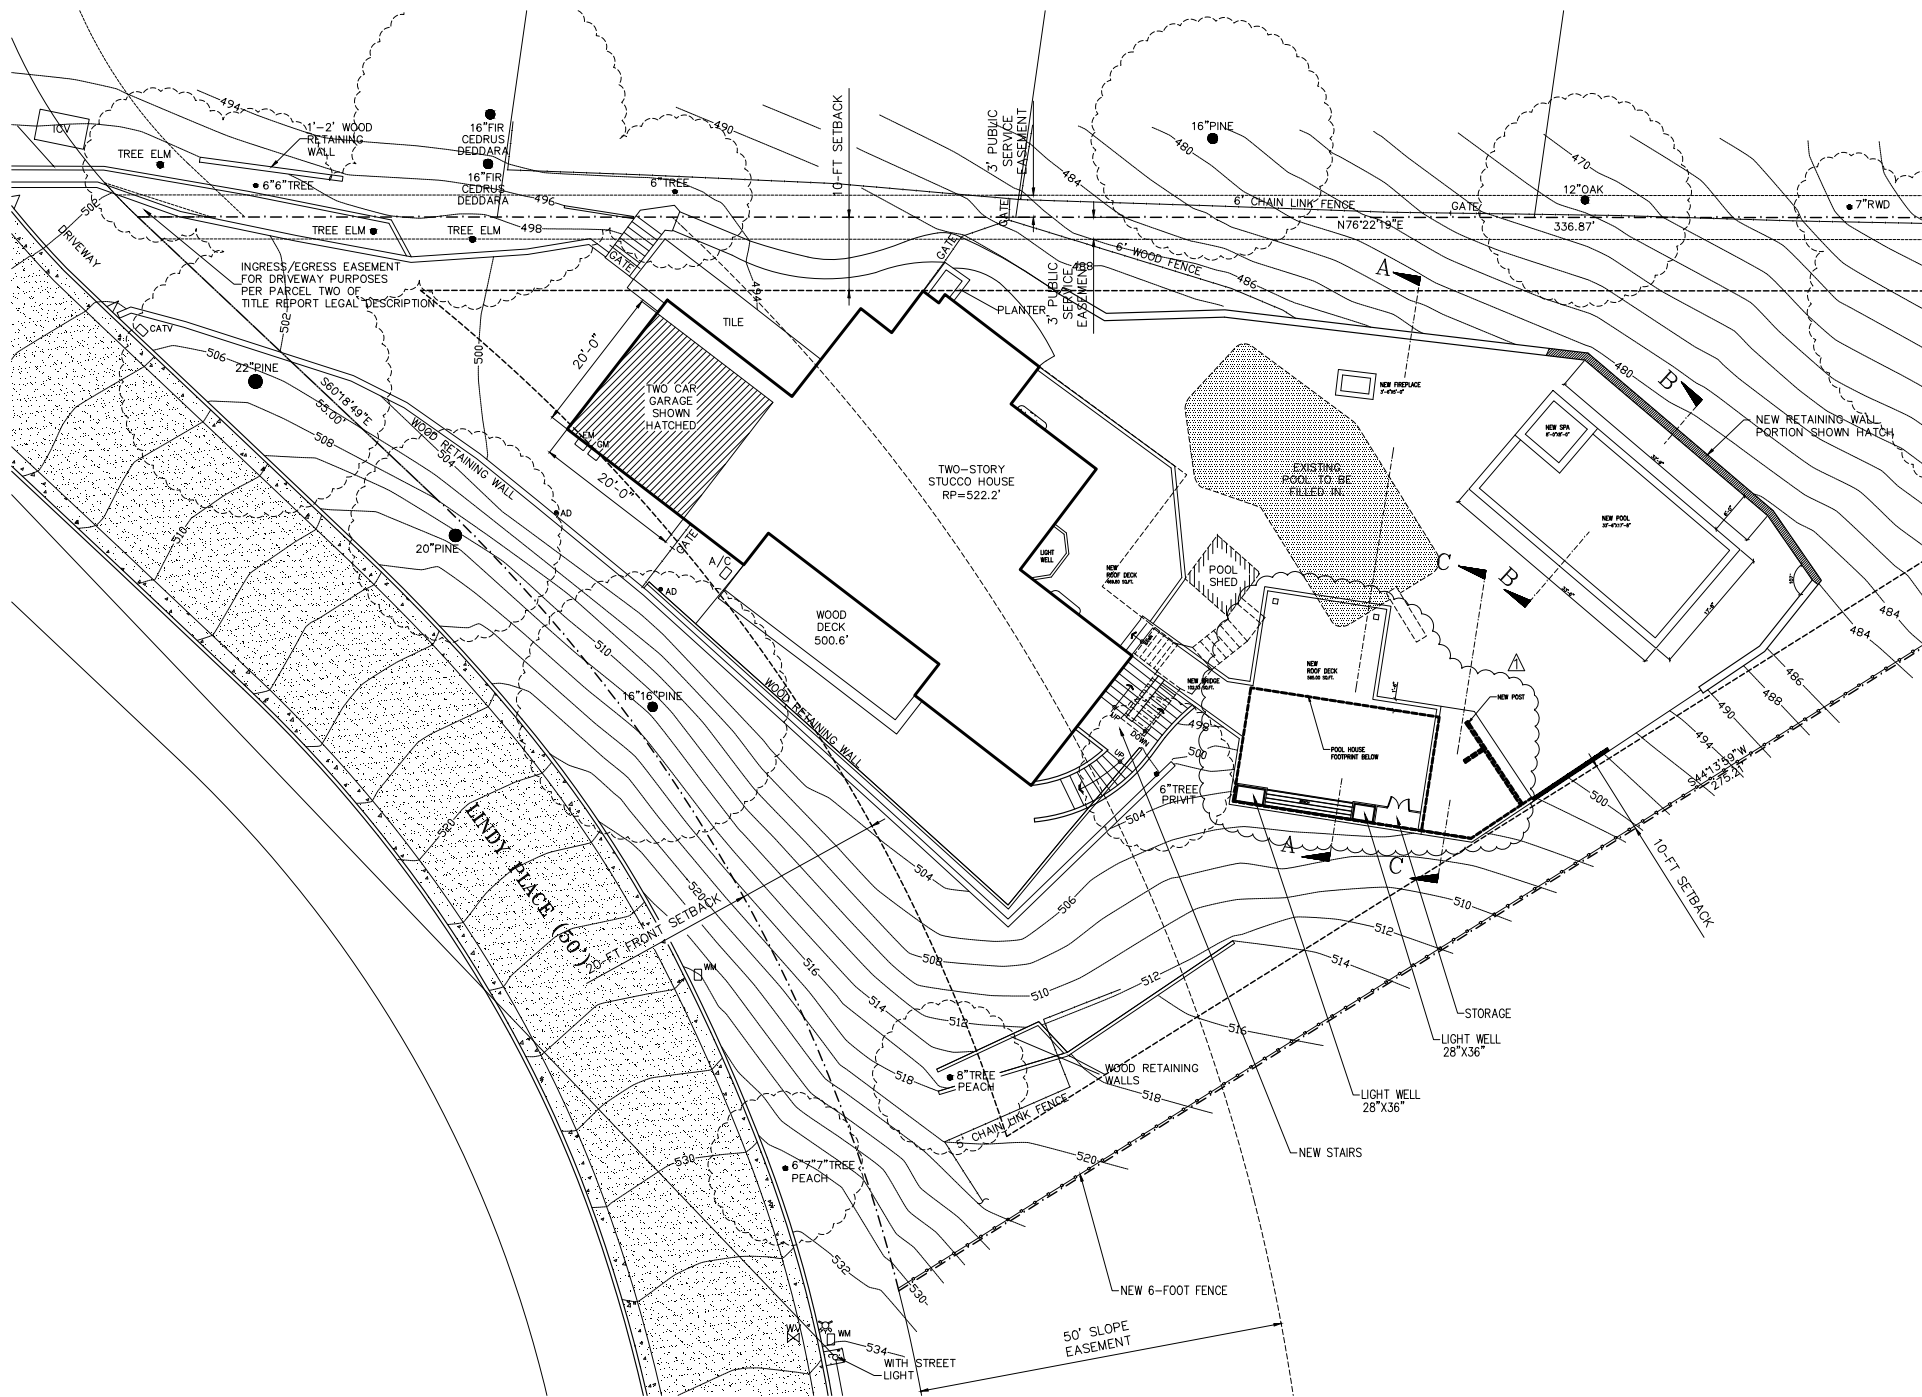
DATE

BY

DATE

EXISTING SITE  
CONDITIONS

11.0



REVISIONS	BY
08-5-16	A.Ortiz
08-15-16	A.Ortiz

CHARLES  
HOLMAN

DESIGN

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SAN JOSE, CALIF. 95128  
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A.P.N. 356-024-011

JOB NO. 01-16
ISSUE DATE 04-28-16
DRAWN BY Alejandro J. Ortiz

PROPOSED  
PARTIAL  
SITE PLAN

SCALE 1/8"=1'

3.0





# KEY NOTES

- [1] KITCHEN SINK W/GARBAGE DISPOSAL
  - [2] 36" RANGE W/AL-FUEL RANGE
  - [3] 36" HIGH COUNTER
  - [4] 36" WIDE BUILT-IN BENCH
  - [5] BUILT-IN SHELVES
  - [6] 7'-0" HIGH WALL FOR SHOWER AREA
  - [7] EXTERIOR SHOWER
  - [8] WATER CLOSET TO BE MAXIMUM 1-2'
  - [9] SALLON FOR FURNITURE C.P.C. 402.3
  - [10] 10'x10' 100' 8'-0" 8'-0" HIGH VANITY WITH B.C.P.C. 402.3
  - [11] SHOWER
  - [12] 10'x10' COLUMNS
  - [13] ONE 2" ROD AND ONE SHELF
  - [14] BUILT-IN BENCH
  - [15] BUILT-IN STORAGE CLOSET 7'-HIGH
  - [16] RETAINING WALL SHOWN SOLID HATCHED
  - [17] BRIDGE ABOVE
  - [18] ROOF DECK & ROOF FOOTPRINT
  - [19] NEW POST
  - [20] NEW STAIRS
- (O) DENOTES WINDOWS, SEE WINDOW SCHEDULE  
(D) DENOTES DOORS, SEE DOOR SCHEDULE

REVISIONS	BY
06-7-17	A.Ort




11406 Lindy Place  
Cupertino, California 94025

A.P.N. 356-024-011

JOB NO. 01-16
ISSUE DATE 05-22-17
DRAWN BY Alejandro J. Ort

## PROPOSED REDUCTION

IN FLOOR AREA TO 412 sq

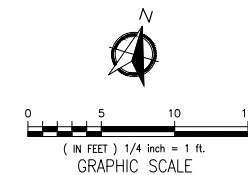

## WALL LEGEND

- (N) 2x ALL INTERIOR & EXTERIOR WALLS  
(N) RETAINING WALL

## FLOOR AREA


MAIN LEVEL (E) HOUSE	2,475.5 SQ.FT.
LOWER LEVEL (E) HOUSE	807.5 SQ.FT.
POOL HOUSE	412.0 SQ.FT.
TOTAL	3,695.0 SQ.FT.

PROPOSED  
FLOOR PLAN


SCALE 1"=1/4"

5.0



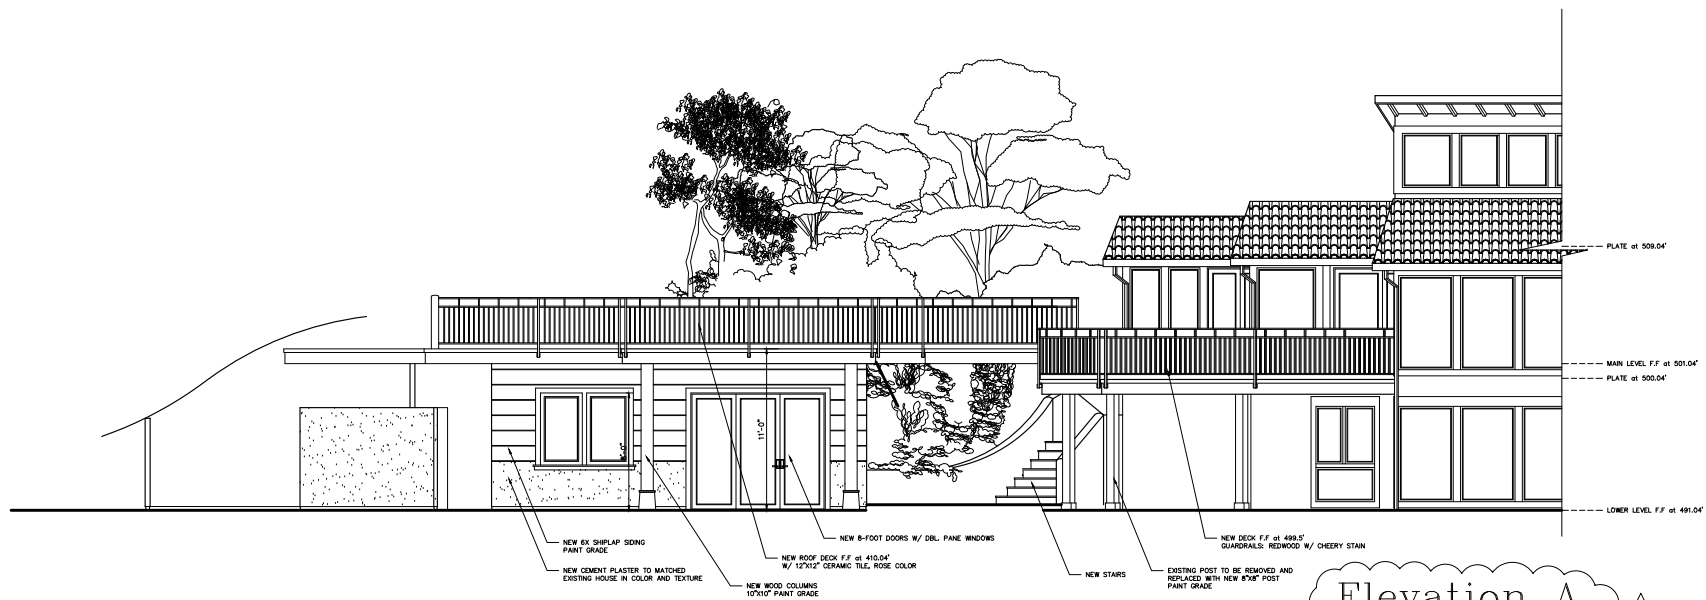

"ANY CHANGES TO THE APPROVED COLORS, MATERIALS, AND EXTERIOR FINISHES SHALL BE REVIEWED AND APPROVED BY THE CITY OF CUPERTINO PLANNING DIVISION PRIOR TO INSTALLATION/APPLICATION."

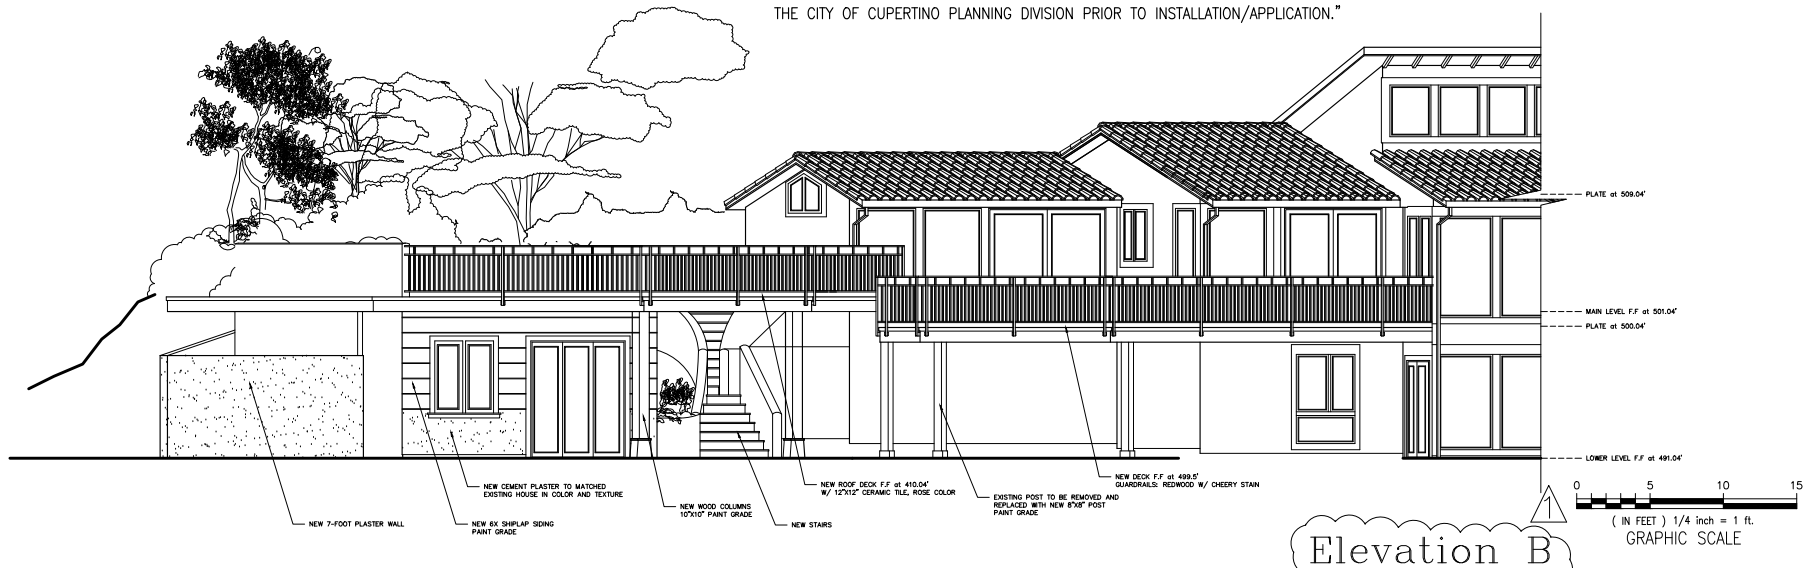

REVISIONS	BY
06-7-17	A.Ort

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HOLMAN  
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JOB NO. 01-16
ISSUE DATE 05-22-17
DRAWN BY Alejandro J. Ort

PROPOSED  
ELEVATIONS


SCALE 1/4"=1'

6.0









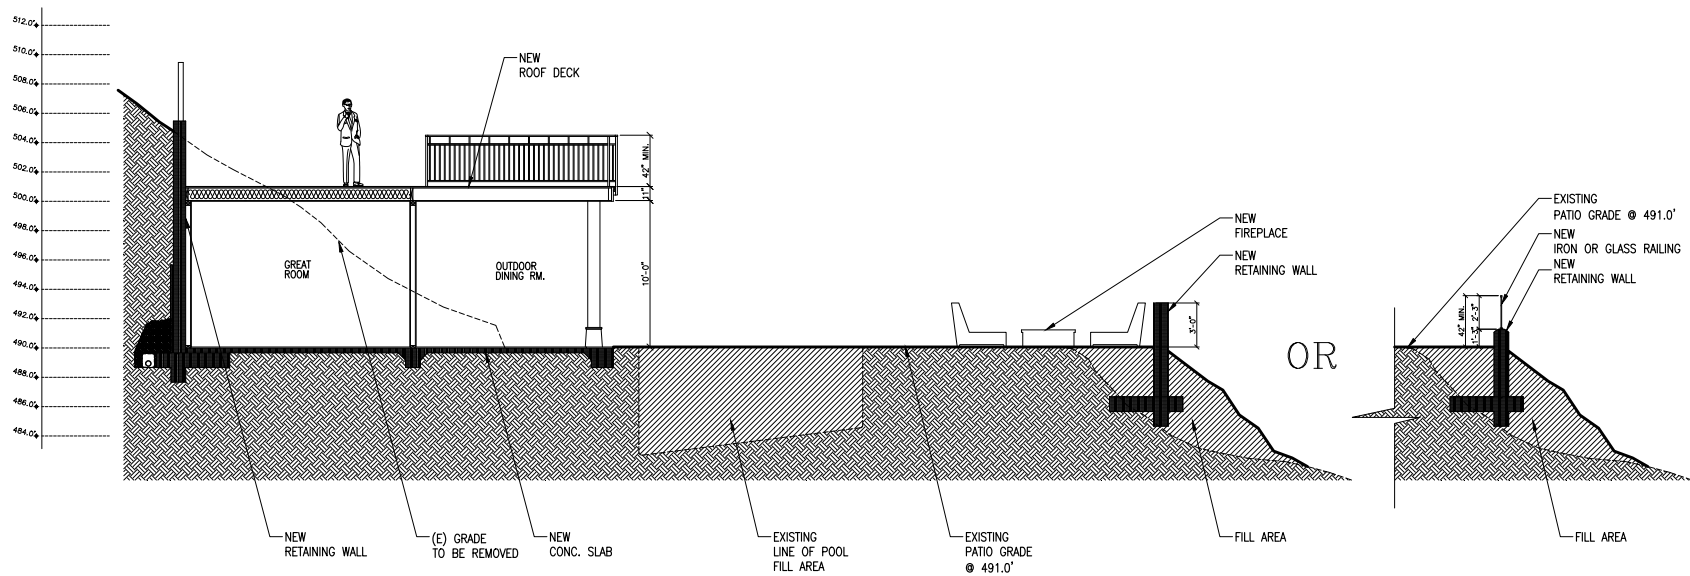

Section A

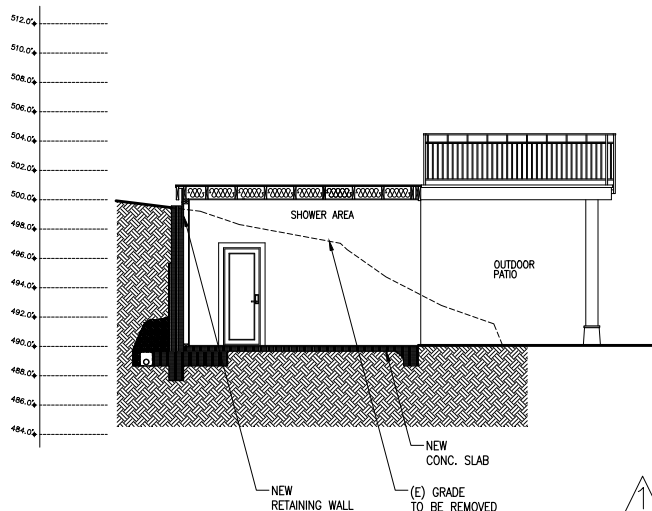

Section C

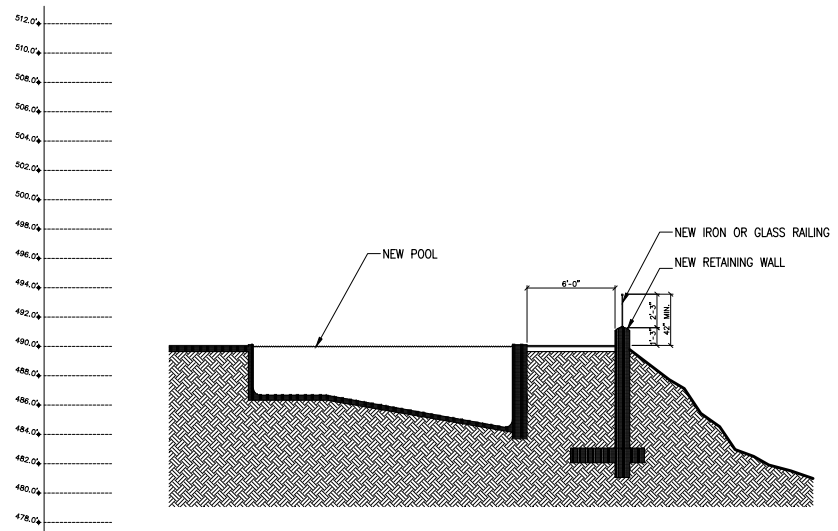

Section B

REVISIONS	BY
06-7-17	A.Ort

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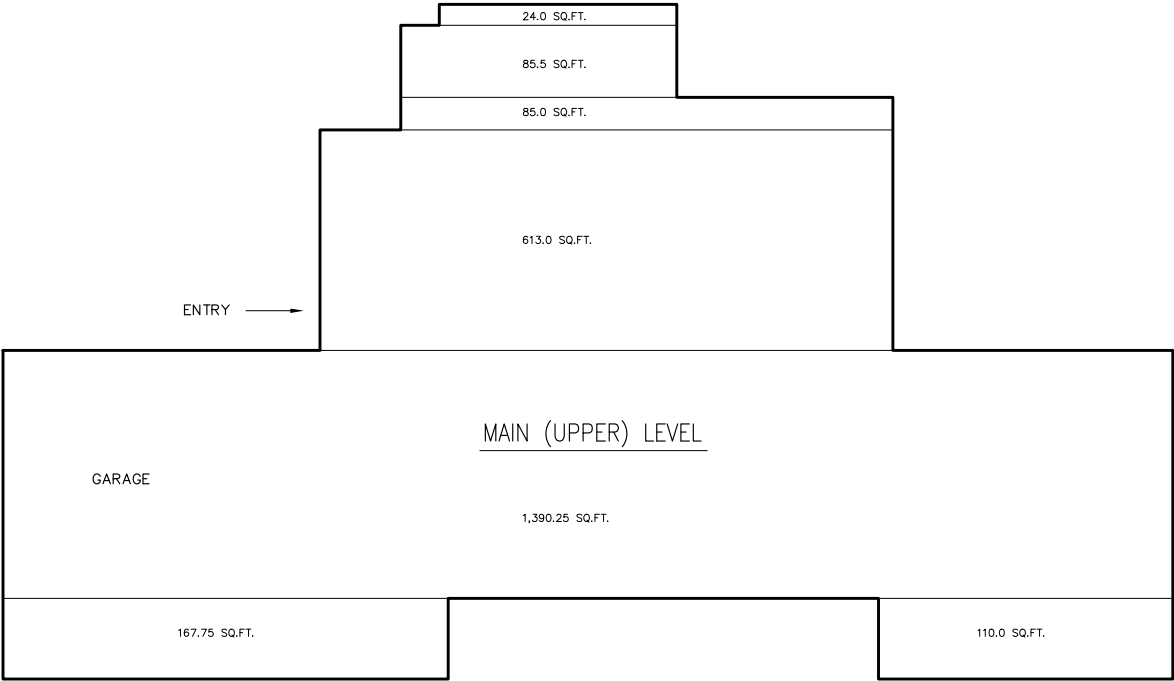
JOB NO.	01-16
ISSUE DATE	05-00-16
DRAWN BY	Alejandro J. Ort

PROPOSED  
SECTION  
A,B,C

SCALE 1/4"=1'

8.0





AREA CALCULATIONS	
MAIN (UPPER) LEVEL	2,475.5 SQ.FT.
* LOWER LEVEL	807.5 SQ.FT.
TOTAL	3,282.0 SQ.FT.

\* LOWER LEVEL AREA DOES NOT  
INCLUDE BASEMENT (310.0 SQ.FT)

0 5 10 15  
( IN FEET ) 1/4 inch = 1 ft.  
GRAPHIC SCALE

REVISIONS	BY

CHARLES  
HOLMAN

DESIGN


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A.P.N. 356-024-011

JOB NO. 01-16
ISSUE DATE 05-00-16
DRAWN BY Alejandro J. Ort

EXISTING  
MAIN (UPPER)  
LEVEL  
AREA CALC'S  
SCALE 1/4"=1'

9.0

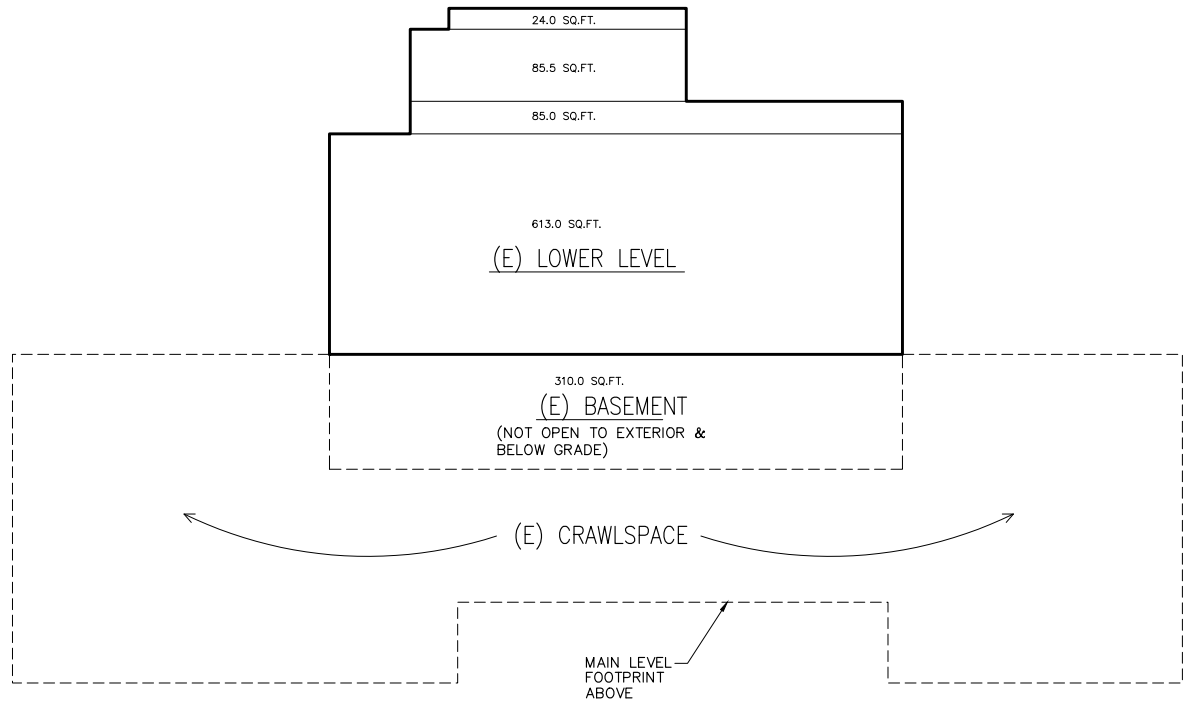

AREA CALCULATIONS	
(E) LOWER LEVEL	807.5 SQ.FT.
(E) BASEMENT	310.0 SQ.FT.
(N) POOL HOUSE	767.8 SQ.FT.

0 5 10  
 ( IN FEET ) 1/4 inch = 1 ft.  
 GRAPHIC SCALE

REVISIONS	BY
06-7-17	A.Ort

CHARLES  
HOLMAN

DESIGN

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A.P.N. 356-024-011

JOB NO. 01-16
ISSUE DATE 05-00-16
DRAWN BY Alejandro J. Ort

EXISTING LOWER  
LEVEL, BASEMENT  
POOL HOUSE  
AREA CALC'S

10.0



**LEA & BRAZE ENGINEERING, INC.**  
CIVIL ENGINEERS • LAND SURVEYORS  
1500 CALIFORNIA STREET, SUITE 200  
ROCKVILLE, CA 94581  
HAYWARD, CALIFORNIA 94545  
(7) (510) 887-7383  
WWW.LEABRAZE.COM

11406 LINDY PLACE  
CUPERTINO  
CALIFORNIA


APN: 356-24-011

SANTA CLARA COUNTY


**AVERAGE LOT SLOPE  
EXHIBIT**

REVISIONS	BY
JOB NO: 2140151	
DATE: 2-25-14	
SCALE: 1" = 16'	
DRAWN BY: DB	
SHEET NO:	

**SL-1**  
1 OF 1 SHEETS

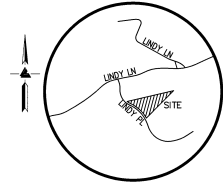

**VICINITY MAP**  
NO SCALE

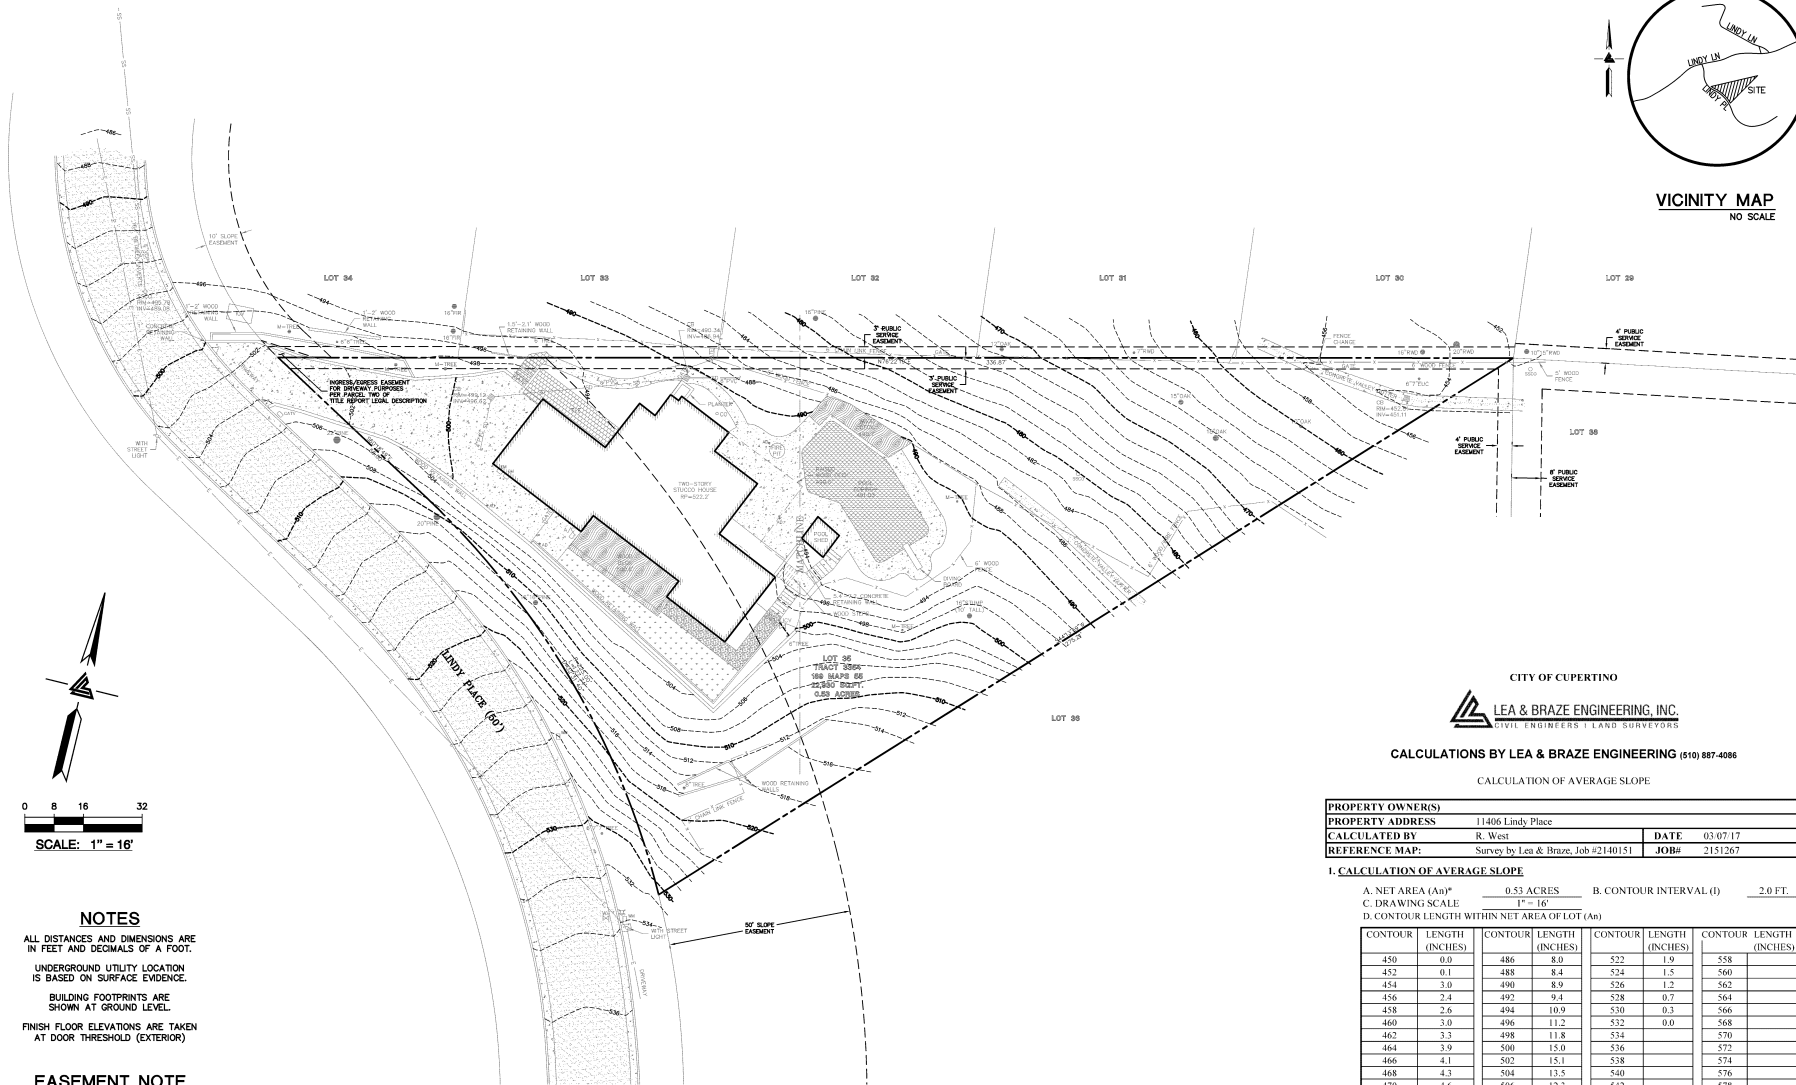

CITY OF CUPERTINO



**CALCULATIONS BY LEA & BRAZE ENGINEERING (510) 887-4086**

**CALCULATION OF AVERAGE SLOPE**

PROPERTY OWNER(S)			
PROPERTY ADDRESS	11406 Lindy Place		
CALCULATED BY	R. West	DATE	03.07.17
REFERENCE MAP:	Survey by Lea & Braze, Job #2140151	JOB#	2151267

**I. CALCULATION OF AVERAGE SLOPE**

A. NET AREA (A<sub>N</sub>) = 0.53 ACRES      B. CONTOUR INTERVAL (I) = 2.0 FT.  
C. DRAWING SCALE = 1" = 16'

D. CONTOUR LENGTH WITHIN NET AREA OF LOT (A<sub>L</sub>)

CONTOUR	LENGTH (INCHES)	CONTOUR	LENGTH (INCHES)	CONTOUR	LENGTH (INCHES)	CONTOUR	LENGTH (INCHES)
450	0.0	486	8.9	522	1.9	558	
452	0.1	488	8.4	524	1.5	560	
454	3.0	490	8.9	526	1.2	562	
456	2.4	492	9.4	528	0.7	564	
458	2.6	494	10.9	530	0.3	566	
460	3.0	496	11.2	532	0.0	568	
462	3.3	498	11.8	534		570	
464	3.9	500	15.0	536		572	
466	4.1	502	15.1	538		574	
468	4.3	504	13.5	540		576	
470	4.6	506	12.3	542		578	
472	4.9	508	11.0	544		580	
474	5.5	510	10.2	546		582	
476	6.0	512	8.6	548		584	
478	6.2	514	7.6	550		586	
480	6.7	516	5.6	552		588	
482	7.1	518	4.0	554		590	
484	7.7	520	2.8	556		592	
						<b>TOTAL</b>	<b>255.3</b>

4084.8 FT.

CONVERT INCHES TO FEET (MULTIPLY BY MAP SCALE) = (L) =

E. AVERAGE SLOPE WITHIN NET AREA OF LOT

$$S = \frac{0.0023 \text{ (2 FT)}}{0.53 \text{ ACRES}} = \frac{4084.8}{35.5\%}$$

**EXHIBIT NOTE**

THIS EXHIBIT IS INTENDED ONLY AS AN AID TO DETERMINE THE AVERAGE LOT SLOPE OF THE SUBJECT PROPERTY. SITE SURVEY INFORMATION, INCLUDING BUT NOT LIMITED TO, UTILITIES, FENCES AND SPECIFIC SPOT GRADES MAY BE REMOVED FOR CLARITY. REFER TO THE SITE SURVEY BY LEA & BRAZE, INC., FOR COMPLETE SITE SURVEY INFORMATION

**NOTES**

- ALL DISTANCES AND DIMENSIONS ARE IN FEET AND DECIMALS OF A FOOT.
- UNDERGROUND UTILITY LOCATION IS BASED ON SURFACE EVIDENCE.
- BUILDING FOOTPRINTS ARE SHOWN AT GROUND LEVEL.
- FINISH FLOOR ELEVATIONS ARE TAKEN AT DOOR THRESHOLD (EXTERIOR)

**EASEMENT NOTE**

EASEMENTS SHOWN PER THE TITLE REPORT ISSUED BY NORTH AMERICAN TITLE COMPANY ORDER NUMBER 1086357 DATED JUNE 9, 2011 AND TRACT 3354 "CANDY ROCK MOUNTAIN" FILED IN BOOK 189 PAGE 55 SANTA CLARA COUNTY RECORDS.

**SITE BENCHMARK**

SURVEY CONTROL POINT  
MAG AND SHINER SET IN ASPHALT  
ELEVATION = 500.00'  
(ASSUMED)




# HIRANO RESIDENCE 11406 LINDY PLACE CUPERTINO, CALIFORNIA

## LEGEND


EXISTING	PROPOSED	DESCRIPTION
---	---	BOUNDARY
---	---	PROPERTY LINE
---	---	RETAINING WALL
---	---	LANDSCAPE RETAINING WALL
---	---	RAINWATER TIGHTLINE
---	---	SUBRAIN LINE
---	---	TIGHTLINE
---	---	STORM DRAIN LINE
---	---	SANITARY SEWER LINE
---	---	WATER LINE
---	---	GAS LINE
---	---	PRESSURE LINE
---	---	JOINT TRENCH
---	---	SET BACK LINE
---	---	CONCRETE VALLEY GUTTER
---	---	EARTHEN SWALE
---	---	CATCH BASIN
---	---	JUNCTION BOX
---	---	AREA DRAIN
---	---	CURB INLET
---	---	STORM DRAIN MANHOLE
---	---	FIRE HYDRANT
---	---	SANITARY SEWER MANHOLE
---	---	STREET SIGN
---	---	SPOT ELEVATION
---	---	FLOW DIRECTION
---	---	DEMOLISH/REMOVE
---	---	BENCHMARK
---	---	CONTOURS
---	---	TREE TO BE REMOVED

## DESCRIPTION

BOUNDARY  
PROPERTY LINE  
RETAINING WALL  
LANDSCAPE RETAINING WALL  
RAINWATER TIGHTLINE  
SUBRAIN LINE  
TIGHTLINE  
STORM DRAIN LINE  
SANITARY SEWER LINE  
WATER LINE  
GAS LINE  
PRESSURE LINE  
JOINT TRENCH  
SET BACK LINE  
CONCRETE VALLEY GUTTER  
EARTHEN SWALE  
CATCH BASIN  
JUNCTION BOX  
AREA DRAIN  
CURB INLET  
STORM DRAIN MANHOLE  
FIRE HYDRANT  
SANITARY SEWER MANHOLE  
STREET SIGN  
SPOT ELEVATION  
FLOW DIRECTION  
DEMOLISH/REMOVE  
BENCHMARK  
CONTOURS  
TREE TO BE REMOVED

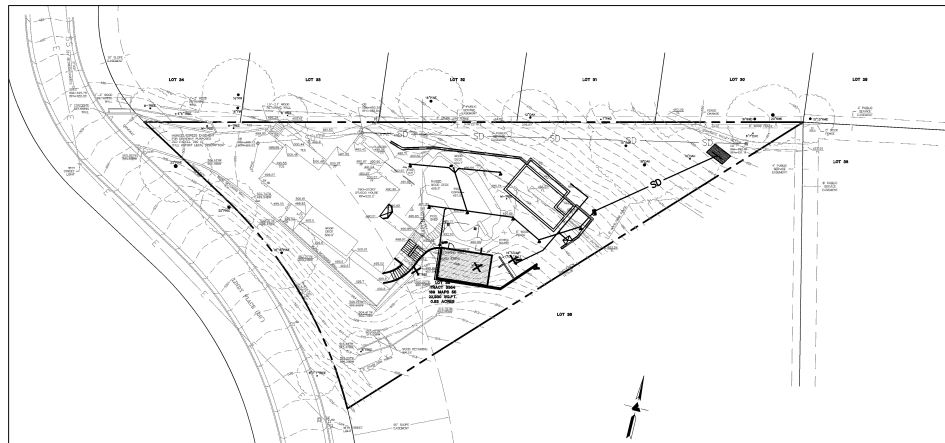

KEY MAP  
1" = 30'

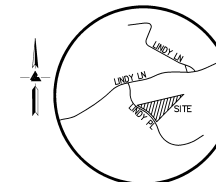

VICINITY MAP  
NO SCALE

## OWNER'S INFORMATION

OWNER: CAROLYN AND KELLY HIRANO  
11406 LINDY PLACE  
CUPERTINO, CA 95014

APN: 356-24-011

## REFERENCES

THIS GRADING AND DRAINAGE PLAN IS SUPPLEMENTAL TO:

1. TOPOGRAPHIC SURVEY BY LEA AND BRAZE ENGINEERING,

ENTITLED:

"TOPOGRAPHIC SURVEY"

11406 LINDY PLACE

CUPERTINO, CA 95014

DATED: 02-25-14

JOB# 2140151

2. SITE PLAN BY CHARLIE HOLMAN DESIGN ENTITLED:

"PROPOSED SITE PLAN"

11406 LINDY PLACE

CUPERTINO, CA 95014

DATED: 05-22-17

THE CONTRACTOR SHALL REFER TO THE ABOVE NOTED

SURVEY AND PLAN, AND SHALL VERIFY BOTH EXISTING AND

PROPOSED ITEMS ACCORDING TO THEM.

## ABBREVIATIONS

AB	AGGREGATE BASE	LF	LINEAR FEET
AC	ASPHALT CONCRETE	MAX	MAXIMUM
ACC	ACCESSIBLE	MH	MANHOLE
AD	AREA DRAIN	MIN	MINIMUM
B & D	BEGINNING OF CURVE	MON.	MONUMENT
B	BEARING & DISTANCE	(N)	NEW
BM	BENCHMARK	NO.	NUMBER
BW/FG	BOTTOM OF WALL/FINISH	NTS	NOT TO SCALE
C	CATCH BASIN	O.C.	OVER CENTER
C & G	CURB AND GUTTER	O/	OVER
CL	CENTER LINE	(PA)	PLANTING AREA
CPP	CORRUGATED PLASTIC PIPE	PIV	POST INDICATOR VALVE
CS	(SMOOTH INTERIOR)	PSS	PUBLIC SERVICES EASEMENT
CO	CLEANOUT	P	PROPERTY LINE
COTG	CLEANOUT TO GRADE	PP	POWER POLE
CONC	CONCRETE	PUE	PUBLIC UTILITY EASEMENT
CONC COR	CONSTRUCT OF -TION	PVC	POLYVINYL CHLORIDE
CY	CUBIC YARD	R	RADIUS
D	DIAMETER	RCR	REINFORCED CONCRETE PIPE
DI	DROP INLET	RM	RAINWATER
DIP	DUCTILE IRON PIPE	R/W	RIGHT OF WAY
E	EACH	S	SLOPE
EC	END OF CURVE	S.A.D.	SEE ARCHITECTURAL DRAWINGS
EG	EXISTING GRADE	SAN	SANITARY
EL	ELEVATIONS	SD	STORM DRAIN
EP	EDGE OF PAVEMENT	SDMH	STORM DRAIN MANHOLE
EQ	EQUIPMENT	SHT	SHEET
EW	EACH WAY	S.L.D.	SEE LANDSCAPE DRAWINGS
EX	EXISTING	SPEC	SPECIFICATION
FG	FACE OF CURB	SS	SANITARY SEWER
FF	FINISHED FLOOR	SSCO	SANITARY SEWER CLEANOUT
FI	FINISHED GRADE	SSMH	SANITARY SEWER MANHOLE
FL	FIRE HYDRANT	ST	STREET
FS	FINISHED SURFACE	STA	STATION
G	GAGE OR GAUGE	STD	STANDARD
GB	GRADE BREAK	STRUC	STRUCTURAL
HDPE	HIGH DENSITY CORRUGATED	T	TELEPHONE
HORIZ	HORIZONTAL PIPE	TC	TOP OF CURB
HI PT	HIGH POINT	TEMP	TEMPORARY
H&T	HUB & TACK	TW/FG	TOP OF WALL/FINISH GRADE
ID	INSIDE DIAMETER	TYP	TYPICAL
INV	INVERT ELEVATION	VC	VERTICAL CURVE
JB	JUNCTION BOX	VCV	VERTICAL CLAY PIPE
JT	JOINT TRENCH	VERT	VERTICAL
LP	LENGTH	W	WATER LINE
LNDG	LANDING	WM	WATER METER
		WWF	WELDED WIRE FABRIC

## RETAINING WALL NOTES


1. TW/FG REPRESENTS FINISHED EARTHEN GRADE OR PAVEMENT ELEVATION AT TOP OF WALL, NOT ACTUAL TOP OF WALL MATERIAL. BW/FG REPRESENTS FINISH EARTHEN GRADE OR PAVEMENT ELEVATION AT BOTTOM OF WALL, NOT INCLUDING FILL FOUNDATION. GRADES INDICATED ON THESE PLANS REFER TO THE FINISHED GRADES ADJACENT TO THE RETAINING WALL, NOT INCLUDING FOOTING, FREEBOARD, ETC.
2. DIMENSIONS SHOWN IN BRACKETS SHOWN AS [X.X'] DENOTE THE EFFECTIVE WALL HEIGHT ONLY. THE ACTUAL WALL HEIGHT AND DEPTH MAY DIFFER DUE TO CONSTRUCTION REQUIREMENTS.
3. REFER TO SPECIFIC WALL CONSTRUCTION DETAIL FOR STRUCTURAL ELEMENTS, FREEBOARD, AND EMBEDMENT.
4. REFER TO ARCHITECTURAL, LANDSCAPE ARCHITECTURE, AND/OR STRUCTURAL PLANS FOR DETAILS, WALL ELEVATIONS, SUBDRAINAGE, WATERPROOFING, FINISHES, COLORS, STEEL REINFORCING MATERIALS, ETC. PROVIDE CLIPS OR OTHER MEANS OF SECURING FINISH MATERIALS AS NECESSARY (WET SET INTO THE WALL).
5. ALL RETAINING WALLS SHOULD HAVE A BACK-OF-WALL SUB-SURFACE DRAINAGE SYSTEM INCLUDING WEEDHOLES TO PREVENT HYDROSTATIC PRESSURE.
6. SEE DETAIL SHEET FOR SPECIFIC INFORMATION.
7. PROVIDE GUARDRAIL (WHERE APPLICABLE AND DESIGNED BY OTHERS) AS REQUIRED FOR GRADE SEPARATION OF 30 INCHES OR MORE MEASURED 5' HORIZONTALLY FROM FACE OF WALL, PER CBC.

## ESTIMATED EARTHWORK QUANTITIES

CUBIC YARDS	WITHIN BUILDING FOOTPRINT	OUTSIDE BUILDING FOOTPRINT	TOTAL CUBIC YARDS
CUT	280	30	280
FILL	0	10	10
EXPORT			280

## NOTE:

GRADING QUANTITIES REPRESENT BANK YARDAGE. IT DOES NOT INCLUDE ANY SWELLING OR SHRINKAGE FACTORS AND IS INTENDED TO REPRESENT IN-SITU CONDITIONS. QUANTITIES DO NOT INCLUDE OVER-EXCAVATION, TRENCHING, STRUCTURAL FOUNDATIONS OR PIERS, OR POOL EXCAVATION (IF ANY). NOTE ADDITIONAL EARTHWORKS, SUCH AS KEYWAYS OR BENCHING MAY BE REQUIRED BY THE GEOTECHNICAL ENGINEER IN THE FIELD AT TIME OF CONSTRUCTION. CONTRACTOR TO VERIFY QUANTITIES.

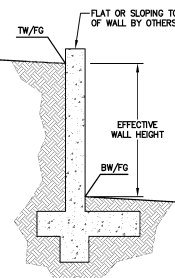

\* BUILDING PAD NOTE:  
ADJUST PAD LEVEL AS  
REQUIRED. REFER TO  
STRUCTURAL PLANS  
FOR SLAB SECTION OR  
CRAWL SPACE DEPTH  
TO ESTABLISH PAD  
LEVEL.

NOTE:  
FOR CONSTRUCTION STAKING  
SCHEDULING OR QUOTATIONS  
PLEASE CONTACT GREG BRAZE  
AT LEA & BRAZE ENGINEERING  
(510)887-4086 EXT 103.  
gbraze@leabrazee.com



## SHEET INDEX

C-1.0 TITLE SHEET  
C-2.0 GRADING & DRAINAGE PLAN  
C-3.0 SECTION PROFILES



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CIVIL ENGINEERS • LAND SURVEYORS  
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(415) 887-4087  
(415) 887-4088  
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CUPERTINO, CALIFORNIA

SANTA CLARA COUNTY


TITLE SHEET

PLAN CHECK	TT
SITE REVISION	TT
REVISIONS	BY
JOB NO.	2151287
DATE	06-14-16
SCALE	AS NOTED
DESIGN BY	TT
DRAWN BY	TB
SHEET NO.	


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01 OF 03 SHEETS




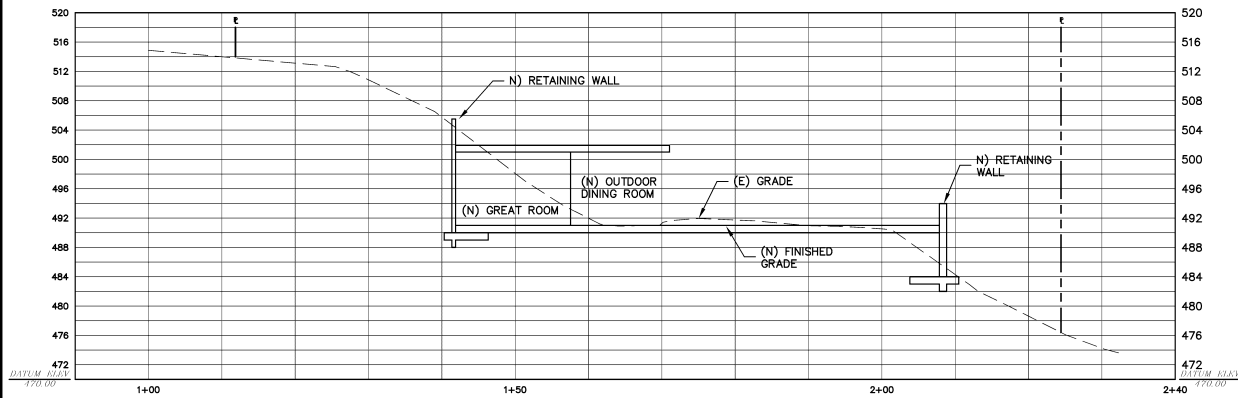

**SECTION A-A PROFILE**  
SCALE: 1" = 8' HORIZ & VERT

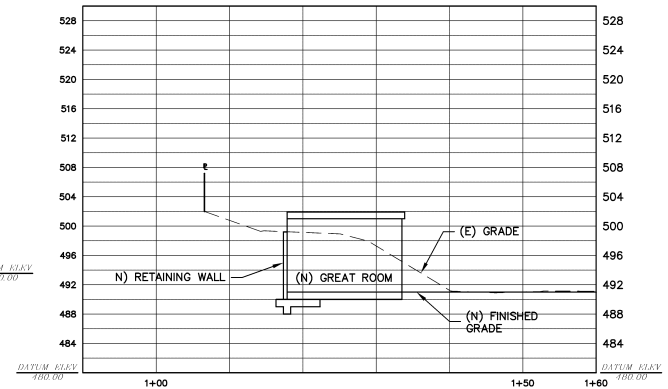

**SECTION C-C PROFILE**  
SCALE: 1" = 8' HORIZ & VERT

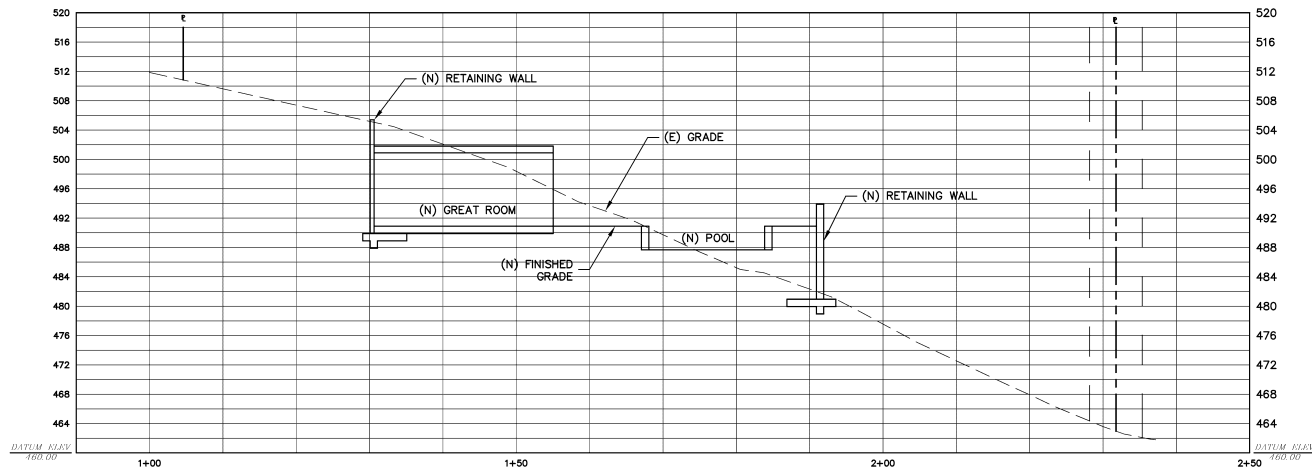

**SECTION B-B PROFILE**  
SCALE: 1" = 8' HORIZ & VERT



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APN: 356-24-011

SANTA CLARA COUNTY

## SECTION PROFILES

1	PLAN CHECK	TT
2	DATE REVISION	TT
	05-25-17	
	REVISIONS	BY
	JOB NO:	2151267
	DATE:	06-14-16
	SCALE:	1" = 8'
	DESIGN BY:	TT
	DRAWN BY:	TB
	SHEET NO:	

**C-3**

03 OF 03 SHEETS