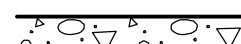

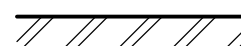
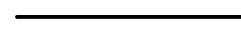



ABBREVIATIONS & LEGEND

&	And	F.S.	Full Size	S	South
∠	Angle	FT.	Foot or Feet	S.C.	Solid Core
@	At	FTG.	Footing	S.C.D.	Seat Cover Dispenser
⊖	Centerline	FURR.	Furred(ing)	SCH.E.	Schedule
⌀	Diameter or Round	FUT	Future	SCN.	Screen
⊥	Perpendicular			S.D.	Soap Dispenser
#	Pound or Number			SECT.	Section
(E)	Existing	GA.	Gauge	SH.	Shelf, Shelving
A.B.	Anchor Bolts	GAL.V.	Galvanized	SHR.	Shower
ABV	Above	G.B.	Grab Bar	SHT.	Sheet
A.C.	Asphaltic concrete	G.C.	General Contract(or)	SHTH.	Sheathing
ACOUS.	Acoustical	GD.	Grade (ing)	SIM.	Similar
A/C	Air Conditioning	GL.	Glass	S.N.D.	Sanitary Napkin Dispenser
A.D.	Area Drain	GND.	Ground	S.N.R.	Sanitary Napkin Receptacle
AFF.	Above Finished Floor	GYP.	Gypsum	SNT.	Sealant
ADJ.	Adjustable			SPEC.	Specification (s)
ADJA.	Adjacent	H.B.	Hoss Bibb	SQ.	Square
AGGR.	Aggregate	HBD	Hardboard	SST.	Stainless Steel
ALT.	Alternate	HDW	Hardware	SSK.	Service Sink
ALUM.	Aluminum	H.M.	Hollow Metal	STA.	Stallion
ANOD.	Anodized	HOR.	Horizontal	STD.	Standard
APPROX.	Approximate	HR.	Hour	STL.	Steel
ARCH.	Architect (ure) (ural)	HT	Height	STOR.	Storage
ASPH.	Asphalt	HWD	Hardwood	STR.	Structure (al)
		H.V.A.C.	Heating/Ventilating/ Air Conditioning	SUSP.	Suspended
				SYM.	Symmetrical
				SYN.	Synthetic
BD.	Board	I.D.	Inside Diameter	T.	Tread
BEL	Below	INSU.	Insulation	T.B.	Towel Bar
BET.	Between	INT.	Interior	T.C.	Terra Cotta
BITUM.	Bituminous			TEL	Telephone
BLDG.	Building	JAN.	Janitor	T&G	Tongue and Groove
BLK.	Block	JT.	Joint	THK	Thick
BLKG.	Blocking	KIT.	Kitchen	THR	Threshold
BM.	Beam			T.P.D.	Toilet Paper Dispenser
B.M.	Bench Mark	LAB.	Laboratory	TPIN	Toilet Partition
BRG.	Bearing	LAM.	Laminate	T.V.	Television
BRZ.	Bronze	LAV.	Lavatory	T.O.C.	Top Of Curb
BOT	Bottom	LBL.	Label	T.O.P.	Top Of Pavement
B.S.	Both Sides	LKR.	Locker	T.O.W.	Top Of Wall
B.W.	Both Ways	LT	Light	TYP.	Typical
BUR	Built Up Roofing	LTL.	Lintel	TZ.	Terrazzo
		LVR.	Louver	UNF.	Unfinished
CAB.	Cabinet	M (m)	Meter	U.O.N./	Unless Otherwise Noted
C.B.	Catch Basin	MAS.	Masonry	U.N.O.	
CEM.	Cement	MAX.	Maximum		
CER.	Ceramic	MBR.	Member	VERT.	Vertical
C.I.	Cast Iron	M.C.	Machine Cabinet	VEST.	Vestibule
CJT.	Control Joint	MECH.	Mechanical		
CK.	Caulk(ing)	MEMB.	Membrane	W	West
CLG.	Ceiling	MET/MTL	Metal	W/	With
CLO.	Closet	MFR.	Manufacture (r)	W.C.	Water Closet
CLR.	Clear (ance)	MH.	Manhole	W/O	Without
CM (cm)	Centimeter	MIN.	Minun	WD.	Wood
C.M.U.	Concrete Masonry Unit	MIR.	Mirror	WP.	Waterproof
CNTR.	Counter	MISC.	Miscellaneous	WSC.T.	Wainscot
COL.	Column	MM (mm)	Millimeter	WT.	Weight
COMP.	Composite (tion)	M.O.	Masonry Opening		
CONC.	Concrete	M.D.	Moulding		
CONN.	Connection	MTD.	Mounted		
CONST.	Construction	MTL	Material		
CONT.	Continuous	MUL	Mullion		
CORR.	Corridor	MWK.	Millwork		
CTR.	Center				
		N	North		
DBL.	Double	N.I.C.	Not In Contract		CONCRETE
DEPT.	Department	NO. / #	Number		CONCRETE BLOCK
DEMO.	Demolish, Demolition	NOM.	Nominal		METAL STUDS
D.F.	Drinking Fountain	N.T.S.	Not To Scale		WOOD STUDS
DIA.	Diameter				SOUND INSU. PTIN.

Playground Furniture

at Good Shepherd C

940 S. Stelling Road

SCOPE OF WORK:

1.

INSTALL NEW PLAYGROUND FURNITURE.

GENERAL NOTES

1.

CONTRACTOR SHALL VERIFY EXISTING CONDITION ON SITE. NOTIFY ARCHITECT IMMEDIATELY IF THERE ARE ANY DISCREPANCY OR INCONSISTENCIES FOUND.

2.

CHANGES IN DESIGN OR MATERIALS WILL NOT BE ACCEPTED WITHOUT WRITTEN AUTHORIZATION FROM ARCHITECT/OWNER.

3.

ALL WARRANTIES DUE TO OWNER SHALL BE FORWARDED IN TRIPPLICATE FORM TO GENERAL CONTRACTOR/OWNER UPON COMPLETION OF THE JOB WITH NO EXCEPTION. FAILURE TO COMPLY WITH WILL RESULT IN DELAY IN PAYMENT TO SUBCONTRACTOR.

4.

GENERAL CONTRACTOR SHALL SUBMIT ONE SET AS-BUILT DRAWINGS IN CADD FORMAT TO ARCHITECT AND OWNER UPON COMPLETION.

5.

MODIFICATION OF EXISTING FIRE SPRINKLER SYSTEM TO BE DESIGN/BUILD BY GENERAL CONTRACTOR, DRAWINGS SHALL BE SUBMITTED TO FIRE DEPARTMENT FOR REVIEW AND APPROVAL.

BLDG DATA

FLOOR AREA:

T.I. FLOOR AREA: – S.F.

APN:

359–25–041

OCCUPANCY:

A2/B

BUILDING TYPE:

V–B

STORY(IES):

ONE

FIRE SPRINKLE:

YES (EXISTING)

DESIGN COMPLY WITH :

CBC 2013 Ed.
CFC 2013 Ed.
CMC 2013 Ed.
CPC 2013 Ed.
CEC 2013 Ed.

2013 BUILDING ENERGY EFFICIENCY STANDARD
2013 CALIFORNIA GREEN BUILDING CODE
CITY OF CUPERTINO CITY ORDINANCE

VICINITY MAP

SYMBOLS

(A) ——— COLUMN OR GRIDLINE

SECTION REFERENCE NO.
SECT. REF. SHEET NO.

ELEVATION REFERENCE NO.
ELEV. REF. SHEET NO.


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DETAIL REF. SHEET NO.

REVISION

RCUSA (RONG CHANG USA)
CORPORATION

2050 CONCOURSE DRIVE, #50
SAN JOSE, CA 95131-1892
TEL (408) 321-9988
FAX (408) 321-9987

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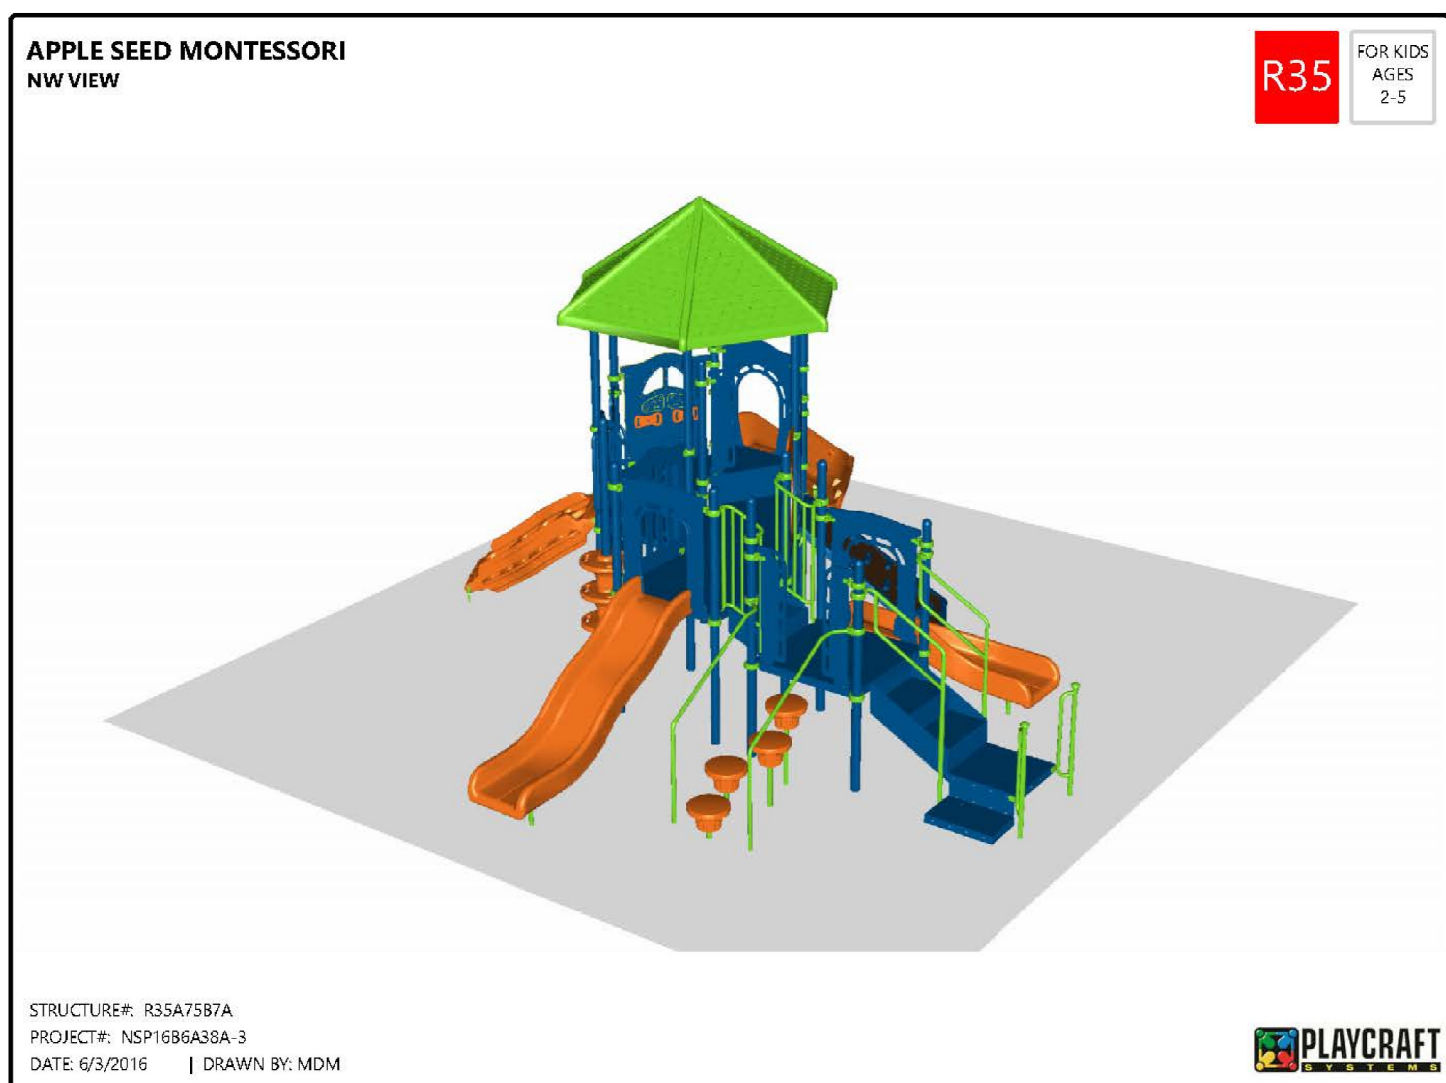
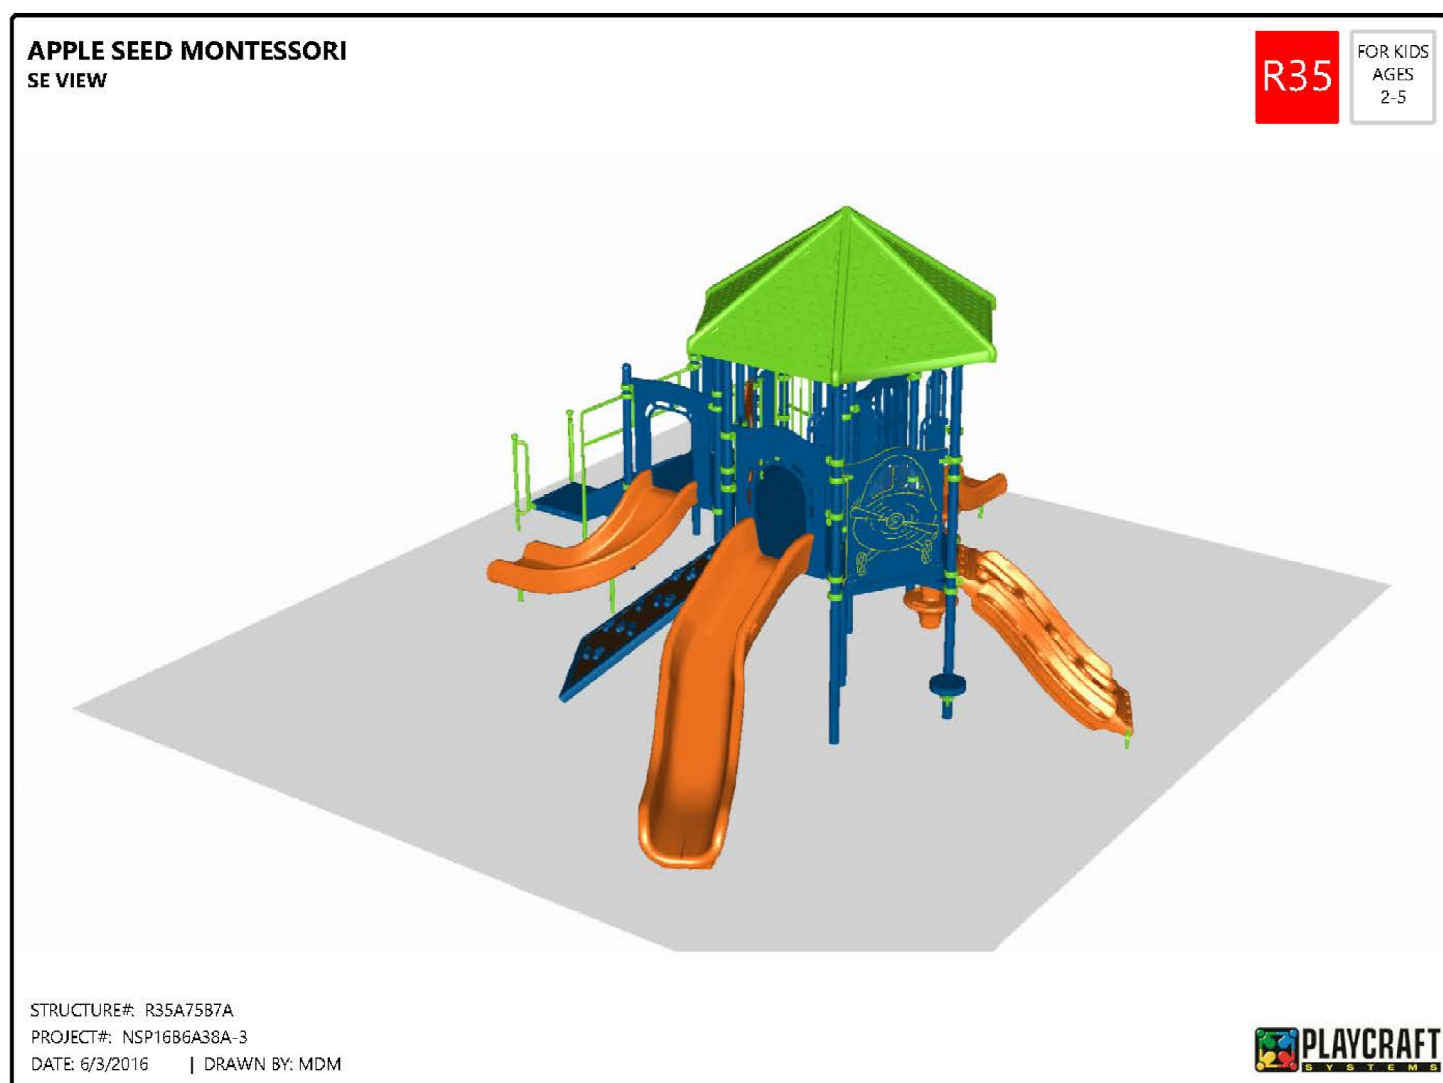
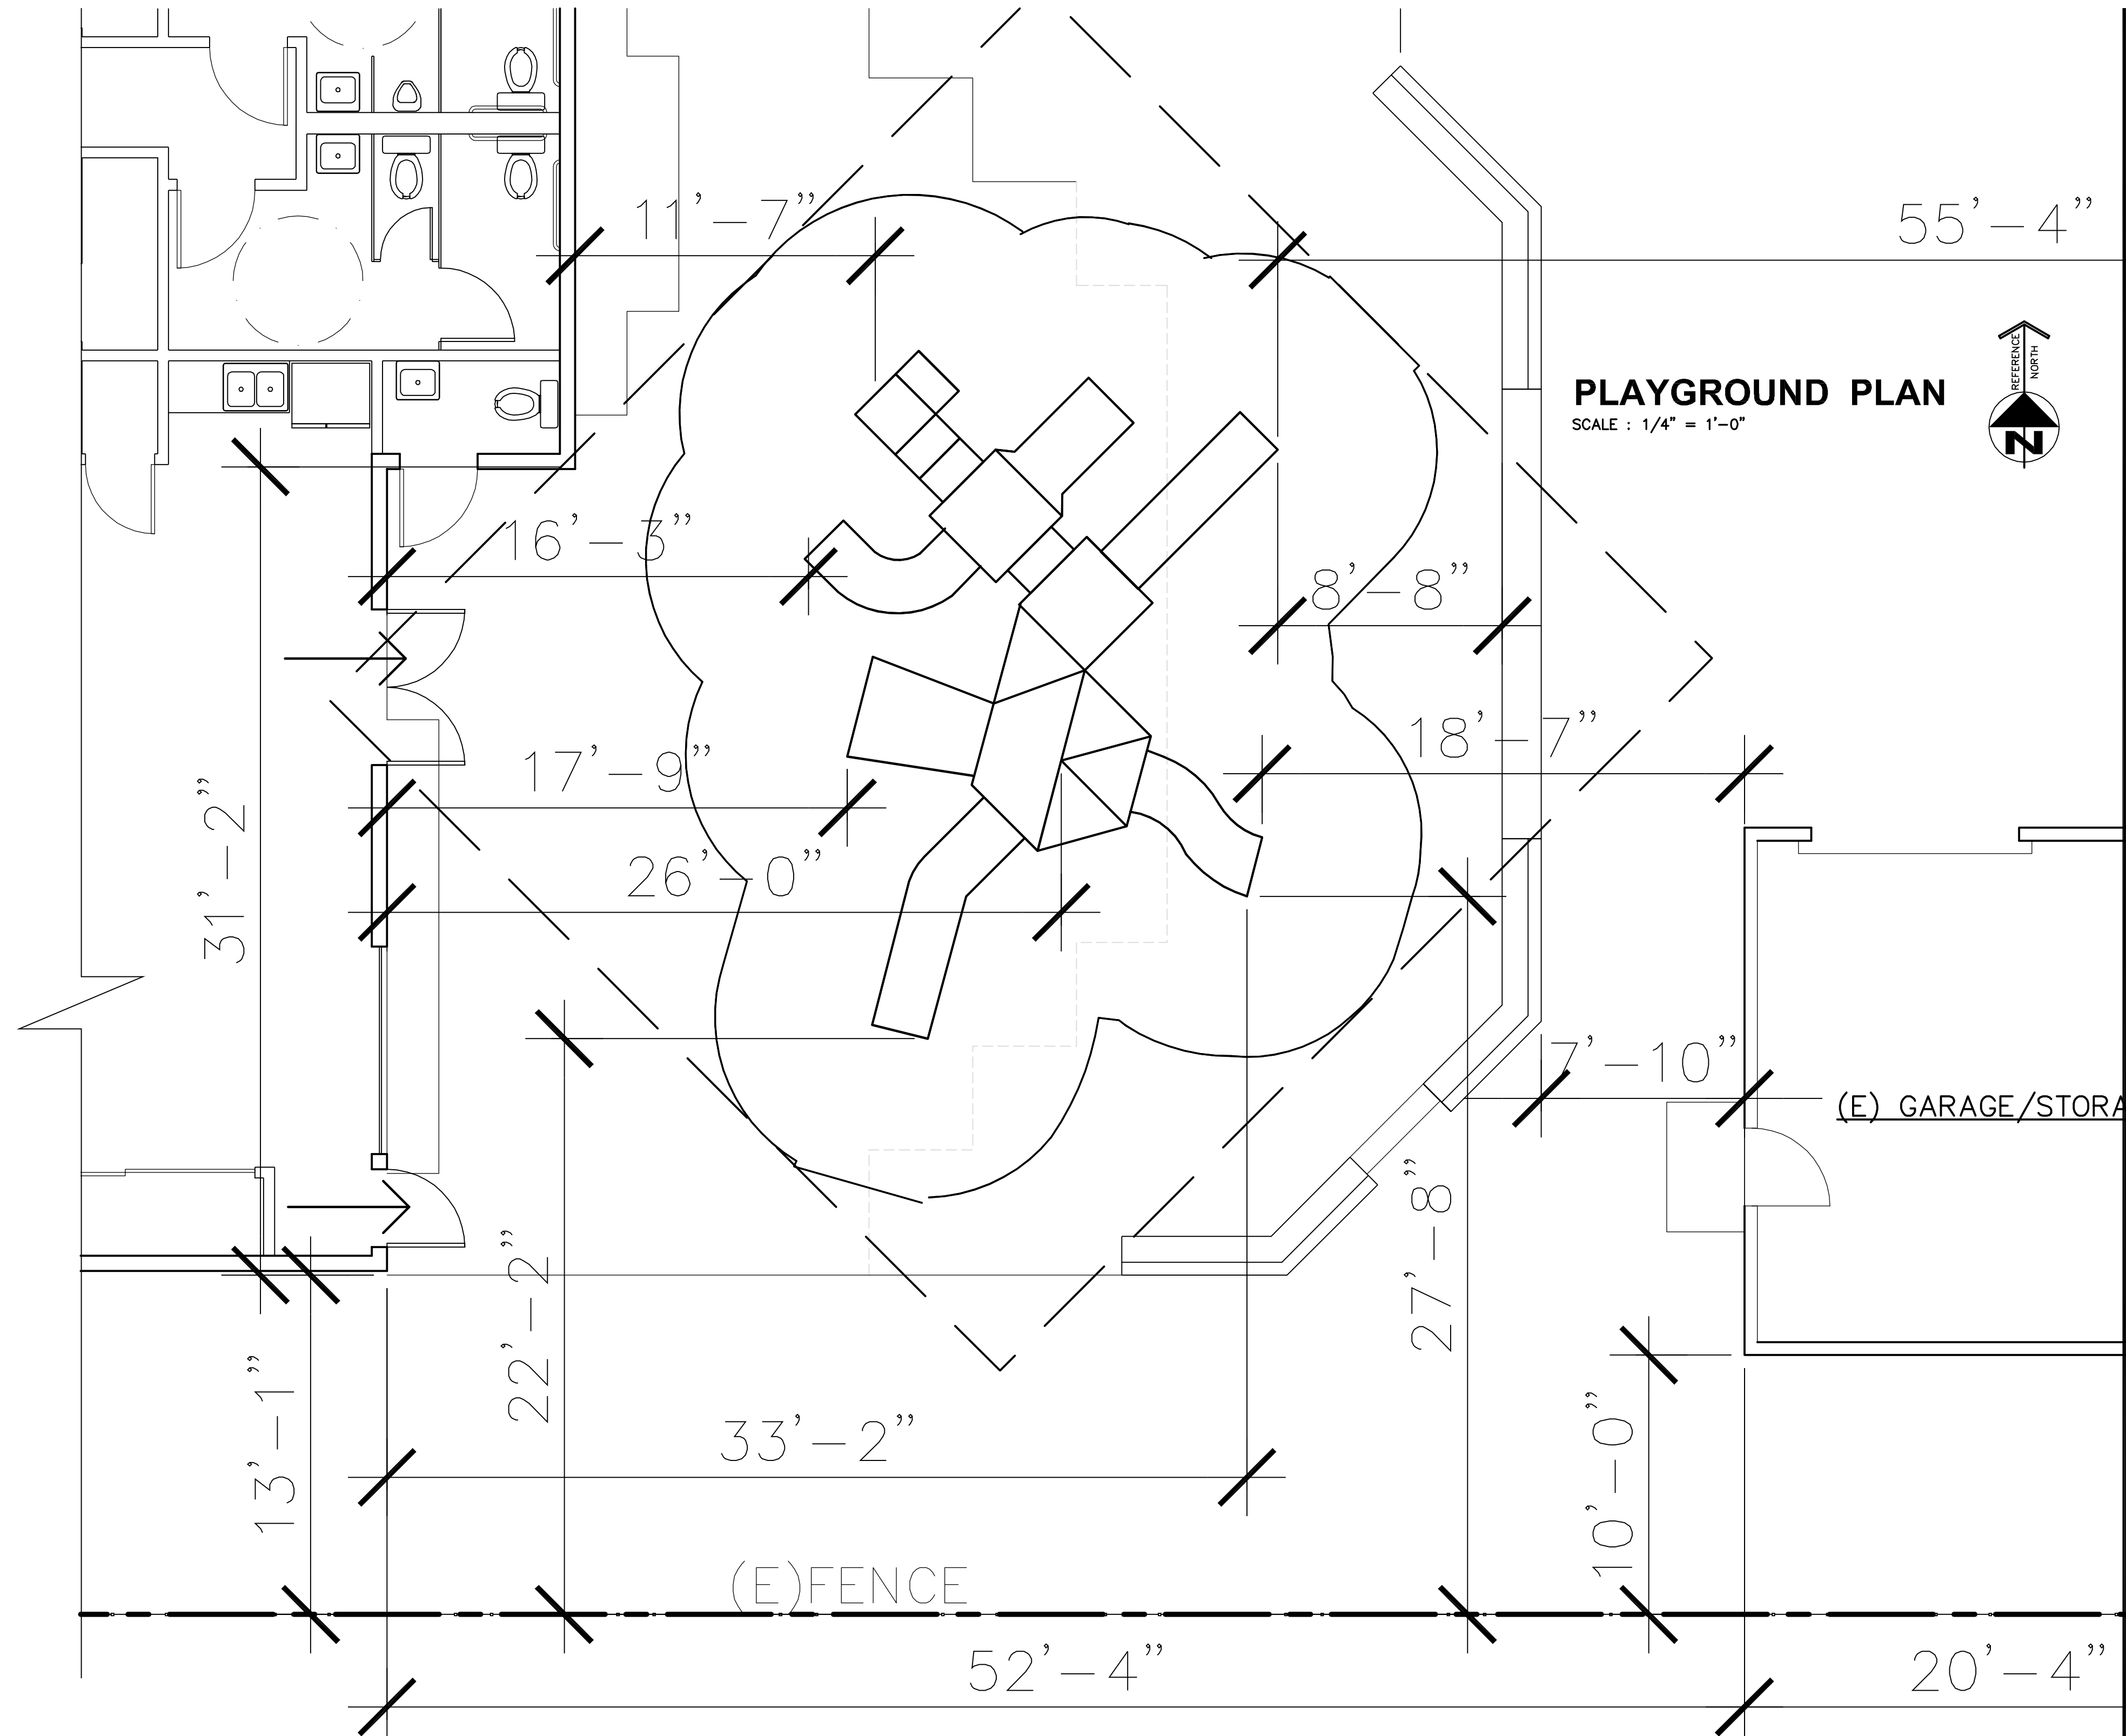
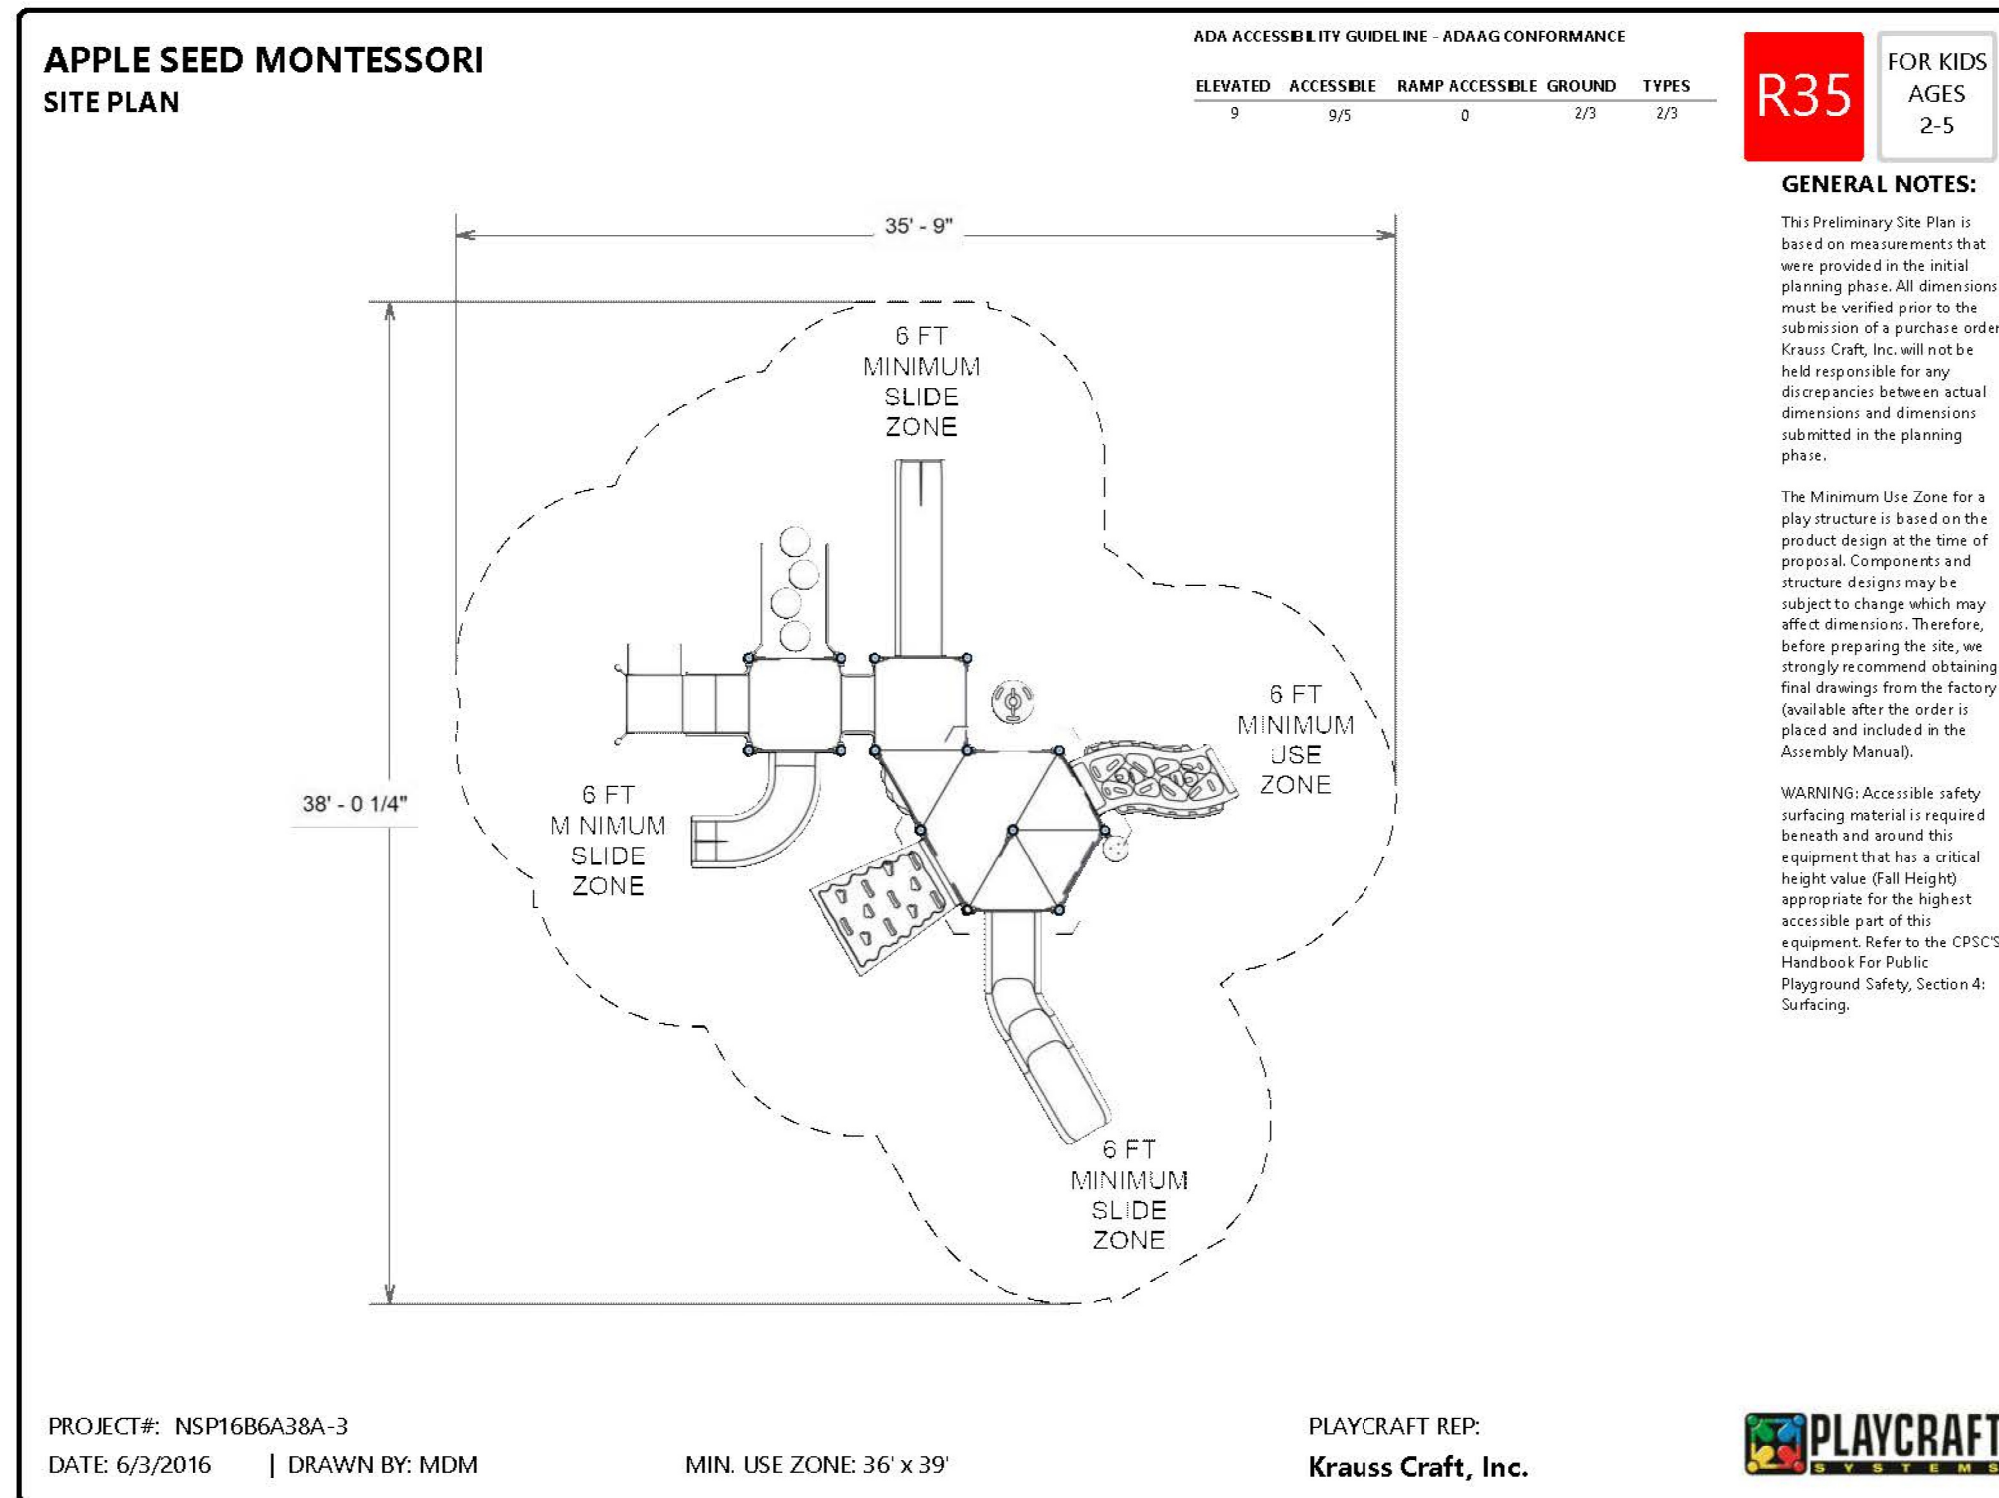
SY-CHENG TSAI C-24234

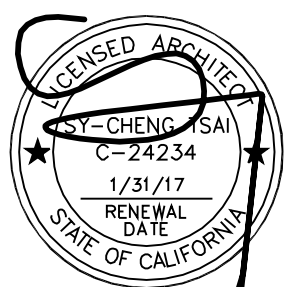Playground Furniture Installation
At Good Shepherd Christian Church
940 S. Stelling Road, Cupertino, CA

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A0.1

DRAWN BY: YC



																									
<p>RCUSA (RONG CHANG USA) CORPORATION</p> <p>2050 CONCOURSE DRIVE, #50 TEL (408) 321-9988 SAN JOSE, CA 95131-1892 FAX (408) 321-9987</p>																									
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<p style="text-align: center;">Playground Furniture Installation At Good Shepherd Christian Church 940 S. Stelling Road, Cupertino, CA</p>																									
<p>PLAYGROUND FLOOR PLAN & DETAILS</p>																									
<p>DATE: 07/07/16</p> <p>JOB NO. RC160735</p> <p>ISSUE & REVISION</p> <table border="1"> <thead> <tr> <th></th> <th>CITY SUBMITTAL</th> </tr> </thead> <tbody> <tr><td>1</td><td>-</td></tr> <tr><td>2</td><td></td></tr> <tr><td>3</td><td></td></tr> <tr><td>4</td><td></td></tr> <tr><td>5</td><td></td></tr> <tr><td>6</td><td></td></tr> <tr><td>7</td><td></td></tr> <tr><td>8</td><td></td></tr> <tr><td>9</td><td></td></tr> <tr><td>10</td><td></td></tr> <tr><td>11</td><td></td></tr> </tbody> </table>			CITY SUBMITTAL	1	-	2		3		4		5		6		7		8		9		10		11	
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<p>DRAWN BY:</p>																									

[illegible]

DRAWN BY: YC

EXISTING TREE LEGEND

KEY	BOTANICAL/COMMON NAME	CONDITION	QTY.	NOTES
EXISTING TREES				
ET1	FRAXINUS SPP.	ASH	GOOD	2
ET2	LAGERSTROEMIA L. VARI.	CRAPPE MYRTLE	FAIR TO GOOD	6
ET3	EUCALYPTUS GLOBULUS 'COMPACTA'	BLUE GUM	FAIR TO POOR	6
ET4	QUERCUS AGRIFFOLIA	COAST LIVE OAK	FAIR TO GOOD	13
ET5	PRUNUS SPP.	ALMOND	POOR	1
ET6	PITTOSPORUM UNDULATUM	VICTORIAN BOX	FAIR TO GOOD	3
ET7	CEDRUS DEODORA	DEODAR CEDAR	FAIR TO GOOD	5
ET8	SEQUOIA SEMPERVIRENS	COAST REDWOOD	GOOD	2
ET9	CALOCEDRUS DECURRENS	INCENSE CEDAR	POOR	1
ET10	MATTENUS BOARIA	MATTEN	POOR	2
ET11	LIGUSTRUM LUCIDUM	GLOSSY PRIVET	FAIR	2
ET12	SCHINUS MOLLE	CALIF. PEPPER TREE	POOR	1
REPLACEMENT TREES				
PER 2010 C.O.A.				

NOTES


1. ALL EXISTING TREES ARE TO REMAIN.
2. APPROXIMATE CROWN CANOPY AS SHOWN.
3. APPROXIMATE TREE CALIPER (DIAMETER AT BREAST HEIGHT - DBH) IN INCHES SHOWN ON PLAN.

New 24" box tree
to be planted

New tree planted


New tree
planted

New 24" box tree
to be planted

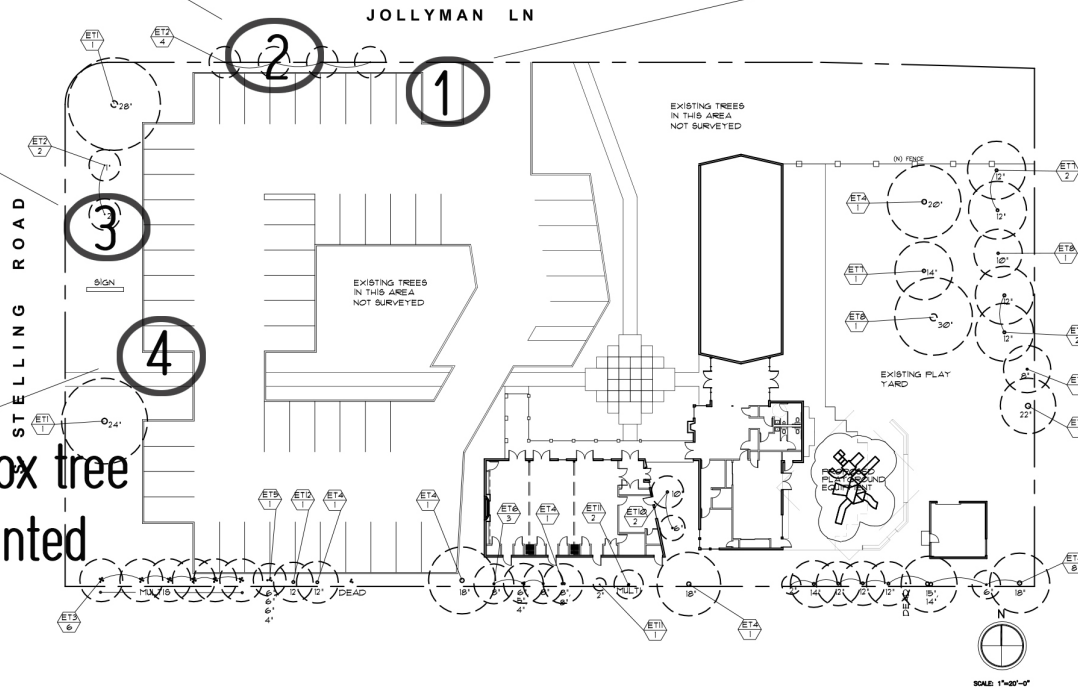

CUSTOM ROUND-3.5 MODULAR PLAYSYSTEM

Estimated Fall Height

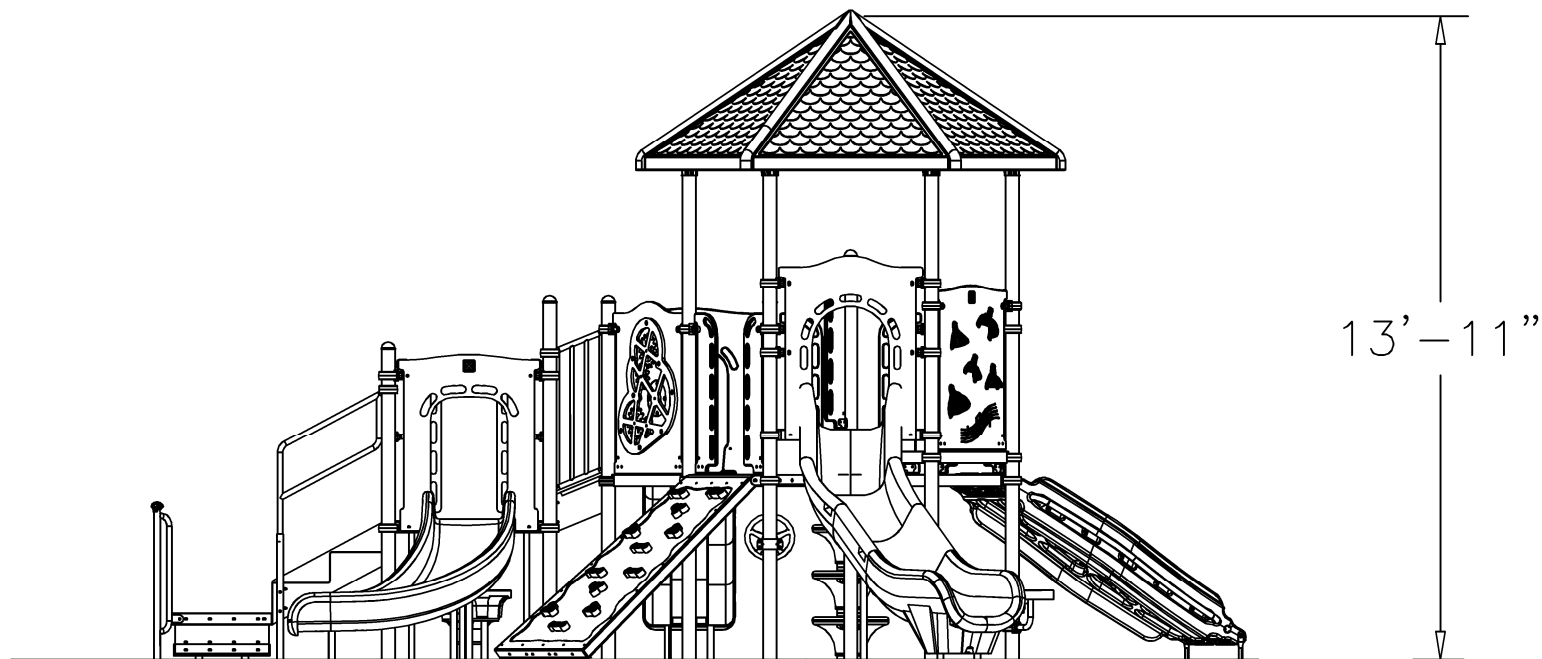

GENERAL NOTES:

- THE SITE PLAN SHOWN IS BASED ON MEASUREMENTS THAT WERE PROVIDED TO KRAUSS CRAFT, INC. AT THE TIME OF THE PROPOSAL REQUEST. ALL DIMENSIONS MUST BE VERIFIED PRIOR TO THE SUBMISSION OF A PURCHASE ORDER. KRAUSS CRAFT, INC. WILL NOT BE RESPONSIBLE FOR ANY DISCREPANCIES BETWEEN ACTUAL DIMENSIONS AND DIMENSIONS SUBMITTED ON A PROPOSAL REQUEST.
- THE MINIMUM USE ZONE FOR THE PLAY STRUCTURE IS BASED ON THE PRODUCT DESIGN AT THE TIME OF THE PROPOSAL. COMPONENTS AND STRUCTURE DESIGN MAY BE SUBJECT TO CHANGE WHICH MAY AFFECT DIMENSIONS. THEREFORE, BEFORE PREPARING SITE, WE STRONGLY RECOMMEND OBTAINING FINAL DRAWINGS FROM THE FACTORY (AVAILABLE AFTER THE ORDER IS PLACED AND INCLUDED IN THE ASSEMBLY MANUAL).
- **WARNING:** ACCESSIBLE SAFETY SURFACING MATERIAL IS REQUIRED BENEATH AND AROUND THIS EQUIPMENT THAT HAS A CRITICAL HEIGHT VALUE (FALL HEIGHT) APPROPRIATE FOR THE HIGHEST ACCESSIBLE PART OF THIS EQUIPMENT. REFER TO THE CPSC'S HANDBOOK FOR PUBLIC PLAYGROUND SAFETY, SECTION 4: SURFACING.

SN: R3590F6FC
Date: 11/22/16
Drawn By: KLF

SN: R3590F6FC
NSP3

Scale: 1/4" = 1'-0"



940 S. Stelling

TOP VIEW

ADA ACCESSIBILITY GUIDELINE - ADAAG CONFORMANCE

ELEVATED	ACCESSIBLE	RAMP ACCESSIBLE	GROUND	TYPES
9	9/5	0	2/3	2/3


R35

FOR KIDS
AGES
2-5

GENERAL NOTES:

This conceptual plan is based on information provided prior to construction. Detailed site information, including the following, should be obtained, evaluated, and utilized in the final project design. Exact site dimensions, topography, existing utilities, soil conditions and drainage solutions.

WARNING: Accessible safety surfacing material is required beneath and around this equipment that has a critical height value (Fall Height) appropriate for the highest accessible part of this equipment. Refer to the CPSC's Handbook For Public Playground Safety, Section 4: Surfacing.

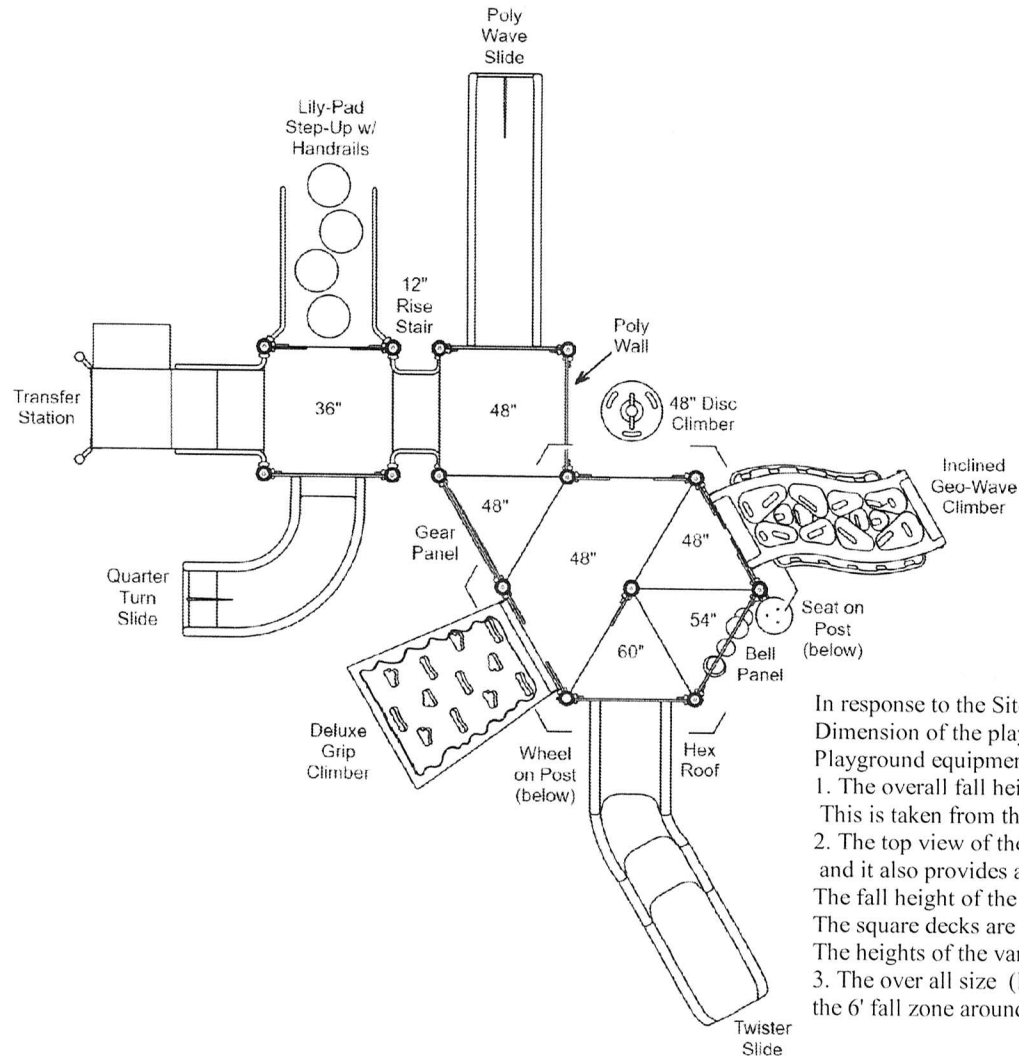

In response to the Site Plan Comments on item #5 : Playground structure-
Dimension of the playground equipment (length, width and height)
Playground equipment information (see attached) :

1. The overall fall height of the structure is rated at 5'.

This is taken from the highest play piece on the structure which is the 5' slide.

2. The top view of the structure design shows the various heights of the structure and it also provides a scale to use for any random measurement.

The fall height of the structure is rated for 5'.

The square decks are 36" across and the Hex deck is 48" across.

The heights of the various decks are 36"/48"/54"/60".

3. The over all size (Min Use zone of 36' x39') not including the 6' fall zone around the equipment.

STRUCTURE#: R3590F6FC

PROJECT#: NSP16B6A38A-1

DATE: 6/22/2016 | DRAWN BY: KJK

MIN. USE ZONE: 36' x 39'

PLAYCRAFT REP:

NSP3

