

SITE NUMBER: CCL04008 SITE NAME: RANCHO DEEP CLIFF

LTE PROJECT: 5C/3C/4C/4T4R ANTENNA RETROFIT

FA# 10148902 - USID: 118755

LTE 5C PACE#: MRSFR041651 CASPR#: 3701ABN80 LTE 3C PACE#: MRSFR041275 CASPR#: 3701AOBKS5 LTE 4C PACE#: MRSFR041204 CASPR#: 3701AOBKQP LTE ANT. MOD/4T4R#: MRSFR041685 CASPR#: 3701AOBMCE

> 22475 RANCHO DEEP CLIFF DRIVE CUPERTINO, CALIFORNIA 95014 JURISDICTION: CITY OF CUPERTINO SITE TYPE: MONOPINE (OUTDOOR)

PROJECT DESCRIPTION PROJECT INFORMATION PROJECT TEAM SHEET INDEX REV APPLICANT/LESSEE: PROPERTY INFORMATION: PROPERTY OWNER: ARCHITECT/ENGINEER: 0 T-1 TITLE SHEET SCOPE OF WORK: JEFFREY ROME & ASSOCIATES 131 INNOVATION DRIVE, SUITE 100 RANCHO DEEP CLIFF HOMEOWNERS ASSOC. AT&T MOBILITY SITE NAME: RANCHO DEEP CLIFF 5001 EXECUTIVE PARKWAY 77 LAS COLINAS LANE MODIFICATION TO EXISTING AT&T TELECOMMUNICATION FACILITY LTE 2C RETROFIT +3C (WCS) + LTE 4C (AWS) + LTE 5C (B14) GENERAL NOTES, ABBREVIATIONS, & NOTES 0 GN-1 SAN JOSE, CA 95014 SAN RAMON, CALIFORNIA 94583 IRVINE, CALIFORNIA 92617 EZC RETROPIT +3C (WCS) + LIE 4C (AWS) + LIE 5C (BI 4) REMOVE (9) EXISTING AT&T ANTENNA POSITIONS 1, 2 & 3 (3 PER SECTOR). INSTALL (9) NEW 6' OCTOPORT ANTENNA POSITIONS 1, 2 & 3 (3 PER SECTOR). REMOVE ALL EXISTING AT&T UNITS 1900 RRUS. REMOVE BLUE 2C RRUS 12 (1900) (1 PER SECTOR). INSTALL (3) NEW LTE 2C RRUS 32-82 (1 PER SECTOR). INSTALL (3) NEW LTE 2C RRUS 32-82 (1 PER SECTOR). INSTALL (3) NEW LTE 3C RRUS-32 B30 (WCS) (1 PER SECTOR). INSTALL (3) NEW LTE 4C RRUS-32 B30 (WCS) (1 PER SECTOR). INSTALL (3) NEW LTE 4C RRUS-32 B30 (WCS) (1 PER SECTOR). INSTALL (3) DEG (SQUID) SURGE SUPPRESSORS + HBER & DC TRUNKS ON 2" INNER DUCT. J. REMOVE (1) EXISTING DUS-41 ON EXISTING LTE PURCELL CABINET. SITE NUMBER: CCL04008 CONTACT: ROBIN NELSON PHONE: T.B.D. EMAIL: ROBINN@JRAINC.NET FA#: 10148902 0 SITE PLAN PHONE: (949) 760-3929 A-0 CONSTRUCTION MANAGER: A-1 EXISTING AND NEW EQUIPMENT PLAN 0 ERICSSON INC. 6140 STONERIDGE ROAD, SUITE 350 SITE ADDRESS: 22475 RANCHO DEEP CLIFF DRIVE, CUPERTINO, CA 95014 A-1.1 EXISTING AND NEW ANTENNA PLAN 0 PLEASANTON, CALIFORNIA 94588 CONTACT: STEVEN JOLLEY EXISTING AND NEW NORTH ELEVATION A-2 0 A.P.N. NUMBER: 356-02-999 EMAIL: steven.jolley@ericsson.com A-3 EXISTING AND NEW SOUTH ELEVATION 0 . INSTALL (1) NEW 5216 BASEBAND & (2) NEW XMU + (1) NEW V2 CHASSIS AS REQUIRED. PHONE: (916) 878-1074 A-4 CURRENT USE: TELECOMMUNICATIONS 13. REMOVE ALL UNUSED AT&T TMAS. SITE ACQUISITION: FACILITY A-4.1 DETAILS FRICSSON INC. A-5 DETAILS 6140 STONERIDGE ROAD, SUITE 350 PROPOSED USE: TELECOMMUNICATIONS PLEASANTON, CALIFORNIA 94588 **FACILITY** RF-1 RF DIAGRAM CONTACT: GLORIA SHIN EMAIL: aloria.shin@ericsson.con JURISDICTION: CITY OF CUPERTING PHONE: (213) 219-9059 For reference to renew use permit: U-2011-02 LATITUDE: 37.3107556° (NAD 83) ZONING MANAGER: No Proposed modifications to facility. ID: 1790410 LONGITUDE: -122.0691361° (NAD 83) RFDS: REVISION: 2.00 CODE COMPLIANCE Plan set to represent the as-built of the existing facility. DATE: 11/10/17 GROUND ELEVATION: ±588' A.M.S.L. ALL WORK AND MATERIALS SHALL BE PERFORMED AND INSTALLED IN ACCORDANCE WITH THE CURRENT EDITIONS OF THE FOLLOWING CODES AS ADOPTED BY THE LOCAL GOVERNING AUTHORITIES. NOTHING IN THESE PLANS IS TO BE CONSTRUED TO PERMIT WORK NOT VICINITY MAP RF ENGINEER: CONFORMING TO THESE CODES. CONTACT: PREETINDER SINGH 1) 2016 CALIFORNIA ADMINISTRATIVE CODE, CHAPTER 10, PART 1, TITLE 24 CODE OF REGULATIONS PHONE: 925 277-6104 EMAIL: ps7945@att.com Santa Paula Ave 2) 2016 CALIFORNIA BUILDING CODE (CBC) WITH CALIFORNIA AMENDMENTS, BASED ON Monta Vista THE 2015 IBC (PART 2, VOL 1-2) DIRECTIONS FROM AT&T 3) 2016 CALIFORNIA RESIDENTIAL CODE (CRC) WITH APPENDIX H, PATIO COVERS, BASED McClellan 4) 2016 CALIFORNIA GREEN BUILDINGS STANDARDS CODE (CALGREEN) (PART 11) (AFFECTED ENERGY PROVISIONS ONLY) FROM AT&T OFFICE: TAKE I-680 S TOWARDS SAN JOSE. TAKE THE MISSION BLVD/STATE ROUTE 262 EXIT Ranch Preserve TOWARD I-880. KEEP THE RIGHT AT THE FORK FOLLOW SIGNS FOR MISSION BLVD \mbox{W} 5) 2016 CALIFORNIA FIRE CODE (CFC), BASED ON THE 2015 IFC, WITH CALIFORNIA Red Lined / As Built AND MERGE ONTO MISSION BLVD. KEEP LEFT AT THE FORK FOLLOW SIGNS FOR INTERSTATE 880 S/SAN JOSE AND MERGE ONTO I-880 S. TAKE THE CALIFORNIA 237 W 6) 2016 CALIFORNIA MECHANICAL CODE (CMC), BASED ON THE 2015 UMC (PART 4) EXIT TOWARD MOUNTAIN VIEW, TAKE THE EXIT ONTO CA-85 S TOWARD CA-82 S/LOS GATOS/SANTA CRUZ. TAKE THE STEVENS CREEK BLVD EXIT. TURN RIGHT ONTO STEVENS Date: 9/27/2018 7) 2016 CALIFORNIA PLUMBING CODE (CPC), BASED ON THE 2012 UPC (PART 5) CREEK BLVD. TURN LEFT ONTO S FOOTHUL BLVD. CONTINUE ONTO STEVENS CANYON. ROAD. TURN LEFT ONTO RANCHO DEEP CLIFF DRIVE . ARRIVE AT 22475 RANCHO DEEP 8) 2016 CALIFORNIA ELECTRICAL CODE (CEC) WITH CALIFORNIA AMENDMENTS, BASED Signature CLIFF DRIVE ON THE LEFT 9) 2016 CALIFORNIA ENERGY CODE (CEC)-(PART 6) 11) 2015 NFPA 101, LIFE SAFETY CODE 12) 2015 NFPA 72, NATIONAL FIRE ALARM CODE Linda Vista Park 13) 2013 NFPA 13, FIRE SPRINKLER CODE OCCUPANCY AND CONSTRUCTION TYPE SPECIAL INSPECTIONS SIGNATURE BLOCK DATE: APPROVED BY OCCUPANCY: U (UNMANNED) 1. NOT REQUIRED SITE ACQUISITION MANAGE CONSTRUCTION TYPE: II-B DIGALFR GENERAL CONTRACTOR NOTES CONSTRUCTION MANAGER: HANDICAP REQUIREMENTS A&F MANAGER DO NOT SCALE DRAWINGS PLANNING CONSULTANT FACILITY IS UNMANNED AND NOT FOR HUMAN HABITATION, ACCESSIBILITY ACCESS AND REQUIREMENTS ARE NOT REQUIRED, IN ACCORDANCE WITH CALIFORNIA STATE ADMINISTRATIVE CODE, PART 2, TITLE 24, SECTION 11038.1, EXCEPTION 1 & SECTION 1134B.2.1, EXCEPTION 4. RF MANAGER: THESE DRAWINGS ARE FORMATTED TO BE FULL SIZE AT 24" x 36". CONTRACTOR RE ENGINEER: SHALL VERIEY ALL PLANS AND (E) DIMENSIONS AND CONDITIONS ON THE IORSITE AND SHALL IMMEDIATELY NOTICY THE ARCHITECT/ENGINEER IN PROPERTY OWNER VRITING OF ANY DISCREPANCIES BEFORE PROCEEDING WITH THE WORK OR

AT&T REPRESENTATIVE

AAV MANAGER

PREPARED FOR

The state of the



Jeffrey Rome | ASSOCIATES

131 Innovation Drive; Suite 100 Irvine, California 92617 tel 949.760.3929 | fax 949.760.3931

AT&T Site ID:

CCL04008

AT&T FA NO: 10148902

JRA PROJECT NO: 174457

DRAWN BY: AU

CHECKED BY: RN

0 03/09/18 100% CD'S A 02/01/18 90% CD'S REV DATE DESCRIPTION

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IT IS A VIOLATION OF LAW FOR ANY PERSON INLESS THEY ARE ACTING UNDER THE DIRECTIC OF A LICENSED PROFESSIONAL ENGINEER, TO ALTER THIS DOCUMENT

Issued For

RANCHO DEEP CLIFF

22475 RANCHO DEEP CLIFF DRIVE, CUPERTINO CALIFORNIA 94066

SHEET TITL

TITLE SHEET

SHEET NUMBER:

800-227-2600

T-1

GENERAL CONSTRUCTION NOTES:

- PLANS ARE INTENDED TO BE DIAGRAMMATIC OUTLINE ONLY, UNLESS NOTED OTHERWISE. THE WORK SHALL INCLUDE FURNISHING MATERIALS, EQUIPMENT, APPURTENANCES AND LABOR NECESSARY TO COMPLETE ALL INSTALLATIONS AS INDICATED ON THE DRAWINGS.
- 2. THE CONTRACTOR SHALL OBTAIN, IN WRITING, AUTHORIZATION TO PROCEED BEFORE STARTING WORK ON ANY ITEM NOT CLEARLY DEFINED
- 3. CONTRACTOR SHALL CONTACT USA (UNDERGROUND SERVICE ALERT) AT (800) 227-2600, FOR UTILITY LOCATIONS, 48 HOURS BEFORE PROCEEDING WITH ANY EXCAVATION, SITE WORK OR CONSTRUCTION.
- 4. THE CONTRACTOR SHALL INSTALL ALL EQUIPMENT AND MATERIALS IN ACCORDANCE WITH MANUFACTURER'S RECOMMENDATIONS UNLESS ECIFICALLY INDICATED OTHERWISE, OR WHERE LOCAL CODES OR REGULATIONS TAKE PRECEDENCE.
- 5. ALL CONSTRUCTION SHALL BE IN ACCORDANCE WITH THE CBC / UBC'S REQUIREMENTS REGARDING EARTHQUAKE RESISTANCE, FOR, BUT NOT LIMITED TO, PIPING, LIGHT FIXTURES, CEILING GRID, INTERIOR PARTITIONS, AND MECHANICAL EQUIPMENT. ALL WORK MUST COMPLY WITH LOCAL EARTHQUAKE CODES AND REGULATIONS.
- 6. REPRESENTATIONS OF TRUE NORTH, OTHER THAN THOSE FOUND ON THE PLOT OF SURVEY DRAWINGS, SHALL NOT BE USED TO IDENTIFY OR ESTABLISH BEARING OF TRUE NORTH AT THE SITE. THE CONTRACTOR SHALL RELY SOLELY ON THE PLOT OF SURVEY DRAWING AND ANY SURVEYOR'S MARKINGS AT THE SITE FOR THE ESTABLISHMENT OF TRUE NORTH, AND SHALL NOTIFY THE ARCHITECT / ENGINEER PRIOR TO PROCEEDING WITH THE WORK IF ANY DISCREPANCY IS FOLIND BETWEEN THE VARIOUS FLEMENTS OF THE WORKING DRAWINGS AND THE TRUE NORTH ORIENTATION AS DEPICTED ON THE CIVIL SURVEY. THE CONTRACTOR SHALL ASSUME SOLE LIABILITY FOR ANY FAILURE TO NOTIFY
- 7. THE BUILDING DEPARTMENT ISSUING THE PERMITS SHALL BE NOTIFIED AT LEAST TWO WORKING DAYS PRIOR TO THE COMMENCEMENT OF WORK, OR AS OTHERWISE STIPULATED BY THE CODE ENFORCEMENT OFFICIAL HAVING JURISDICTION.
- 8. DO NOT EXCAVATE OR DISTURB BEYOND THE PROPERTY LINES OR LEASE LINES, UNLESS OTHERWISE NOTED.
- ALL EXISTING UTILITIES, FACILITIES, CONDITIONS, AND THEIR DIMENSIONS SHOWN ON THE PLAN HAVE BEEN PLOTTED FROM AVAILABLE RECORDS. THE ARCHITECT / ENGINEER AND THE OWNER ASSUME NO RESPONSIBILITY WHATSOEVER AS TO THE SUFFICIENCY OR THE ACCURACY OF THE INFORMATION SHOWN ON THE PLANS, OR THE MANNER OF THEIR REMOVAL OR ADJUSTMENT. CONTRACTORS SHALL BE RESPONSIBLE FOR DETERMINING EXACT LOCATION OF ALL EXISTING LITHIUTIES AND FACILITIES PRIOR TO START OF CONSTRUCTION CONTRACTORS SHALL ALSO OBTAIN FROM EACH UTILITY COMPANY DETAILED INFORMATION RELATIVE TO WORKING SCHEDULES AND METHODS OF REMOVING OR ADJUSTING EXISTING UTILITIES.
- 10. CONTRACTOR SHALL VERIFY ALL EXISTING UTILITIES, BOTH HORIZONTAL AND VERTICALLY, PRIOR TO THE START OF CONSTRUCTION, ANY DISCREPANCIES OR DOUBTS AS TO THE INTERPRETATION OF PLANS SHOULD BE IMMEDIATELY REPORTED TO THE ARCHITECT / ENGINEER FOR RESOLUTION AND INSTRUCTION, AND NO FURTHER WORK SHALL BE PERFORMED UNTIL THE DISCREPANCY IS CHECKED AND CORRECTED BY THE ARCHITECT / ENGINEER. FAILURE TO SECURE SUCH INSTRUCTION MEANS CONTRACTOR WILL HAVE WORKED AT HIS/HER OWN RISK AND
- 11. ALL NEW AND EXISTING UTILITY STRUCTURES ON SITE AND IN AREAS TO BE DISTURBED BY CONSTRUCTION SHALL BE ADJUSTED TO FINISH ELEVATIONS PRIOR TO FINAL INSPECTION OF WORK.
- 12. ANY DRAIN AND/OR FIELD TILE ENCOUNTERED / DISTURBED DURING CONSTRUCTION SHALL BE RETURNED TO IT'S ORIGINAL CONDITION PRIOR TO COMPLETION OF WORK SIZE LOCATION AND TYPE OF ANY LINDERGROUND LITUITIES OR IMPROVEMENTS SHALL BE ACCURATELY NOTED AND PLACED ON "AS-BUILT" DRAWINGS BY GENERAL CONTRACTOR, AND ISSUED TO THE ARCHITECT / ENGINEER AT COMPLETION
- 13. ALL TEMPORARY EXCAVATIONS FOR THE INSTALLATION OF FOUNDATIONS, UTILITIES, ETC., SHALL BE PROPERLY LAID BACK OR BRACED IN ACCORDANCE WITH CORRECT OCCUPATIONAL SAFETY AND HEALTH ADMINISTRATION (OSHA) REQUIREMENT
- 14. INCLUDE MISC. ITEMS PER AT&T SPECIFICATIONS

APPLICABLE CODES, REGULATIONS AND STANDARDS:

SUBCONTRACTOR'S WORK SHALL COMPLY WITH ALL APPLICABLE NATIONAL, STATE, AND LOCAL CODES AS ADOPTED BY THE LOCAL AUTHORITY HAVING JURISDICTION (AHJ) FOR THE LOCATION.

THE EDITION OF THE AH LADOPTED CODES AND STANDARDS IN EFFECT ON THE DATE OF CONTRACT AWARD SHALL GOVERN THE DESIGN

SUBCONTRACTOR'S WORK SHALL COMPLY WITH THE LATEST EDITION OF THE FOLLOWING STANDARDS:

- AMERICAN CONCRETE INSTITUTE (ACI) 318, BUILDING CODE REQUIREMENTS FOR STRUCTURAL CONCRETE
- AMERICAN INSTITUTE OF STEEL CONSTRUCTION (AISC), MANUAL OF STEEL CONSTRUCTION, ASD, NINTH EDITION
 TELECOMMUNICATIONS INDUSTRY ASSOCIATION (TIA) 222-G, STRUCTURAL STANDARD FOR STRUCTURAL ANTENNA TOWER AND ANTENNA
- INSTITUTE FOR ELECTRICAL AND ELECTRONICS ENGINEERS (IEEE) 81, GUIDE FOR MEASURING EARTH RESISTIVITY, GROUND IMPEDANCE, AND EARTH SURFACE POTENTIALS OF A GROUND SYSTEM IEEE 1100 (1999) RECOMMENDED PRACTICE FOR POWERING AND GROUNDING (
- EACHT SURFACE FOR FOREIGN STATE OF A GROUND STSTEM TEEE THOU (1777) RECOMMENDED FRACTICE FOR FOWERING AND GROUNDING OF ELECTRICAL EQUIPMENT.
 -IEEE C62.41, RECOMMENDED PRACTICES ON SURGE VOLTAGES IN LOW VOLTAGE AC POWER CIRCUITS (FOR LOCATION CATEGORY "C3" AND "HIGH SYSTEM EXPOSURE")

TIA 607 COMMERCIAL BUILDING GROUNDING AND BONDING REQUIREMENTS FOR TELECOMMUNICATIONS TELCORDIA GR-63 NETWORK

EQUIPMENT-BUILDING SYSTEM (NEBS): PHYSICAL PROTECTION TELCORDIA GR-347 CENTRAL OFFICE POWER WIRING TELCORDIA GR-1275 GENERAL INSTALLATION REQUIREMENTS TELCORDIA GR-1503 COAXIAL CABLE CONNECTIONS

ANY AND ALL OTHER LOCAL & STATE LAWS AND REGULATIONS

FOR ANY CONFLICTS BETWEEN SECTIONS OF LISTED CODES AND STANDARDS REGARDING MATERIAL, METHODS OF CONSTRUCTION, OR OTHER REQUIREMENTS, THE MOST RESTRICTIVE SHALL GOVERN, WHERE THERE IS CONFLICT BETWEEN A GENERAL REQUIREMENT AND A SPECIFIC REQUIREMENT, THE SPECIFIC REQUIREMENT SHALL GOVERN.

> Red Lined / As Built Date: 9/27/2018 Signature:


ABBREVIATIONS

A.B.	ANCHOR BOLT	IN. (")	INCH(ES)
ABV.	ABOVE	INT.	INTERIOR
ACCA	ANTENNA CABLE COVER ASSEMBLY	LB.(#)	POUND(S)
ADD'L	ADDITIONAL	L.B.	LAG BOLTS
AFF	ABOVE FINISHED FLOOR	L.F.	LINEAR FEET (FOOT)
A.F.G.	ABOVE FINISHED FLOOR ABOVE FINISHED GRADE	L.	LONG(ITUDINAL)
ALUM.	ALUMINUM	MAS.	MASONRY
ALT.	ALTERNATE	MAX.	MAXIMUM
ANT.	ANTENNA	M.B.	MACHINE BOLT
APPRX.	APPROXIMATE(LY)	MECH.	MECHANICAL
ARCH.	ARCHITECT(URAL)	MFR.	MANUFACTURER
AWG.	AMERICAN WIRE GAUGE	MIN.	MINIMUM
BLDG.	BUILDING	MISC.	MISCELLANEOUS
BLK.	BLOCK	MTL.	METAL
BLKG.	BLOCKING	(N)	NEW
		NO (#)	NUMBER
BM.	BEAM		NOT TO SCALE
B.N.	BOUNDARY NAILING	N.T.S.	
BTCW.	BARE TINNED COPPER WIRE	O.C.	ON CENTER
B.O.F.	BOTTOM OF FOOTING	OPNG.	OPENING
B/U	BACK-UP CABINET	P/C	PRECAST CONCRETE
CAB.	CABINET	PCS	PERSONAL COMMUNICATION SERVICES
CANT.	CANTILEVER(ED)	PLY.	PLYWOOD
C.I.P.	CAST IN PLACE	PPC	POWER PROTECTION CABINET
CLG.	CEILING	PRC	PRIMARY RADIO CABINET
CLR.	CLEAR	P.S.F.	POUNDS PER SQUARE FOOT
		P.S.I.	POUNDS PER SQUARE INCH
COL.	COLUMN	P.T.	PRESSURE TREATED
CONC.	CONCRETE		
CONN.	CONNECTION(OR)	PWR.	POWER (CABINET)
CONST.	CONSTRUCTION	QTY.	QUANTITY
CONT.	CONTINUOUS	RAD.(R)	RADIUS
d	PENNY (NAILS)	REF.	REFERENCE
DBL.	DOUBLE	REINF.	REINFORCEMENT(ING)
DEPT.	DEPARTMENT	REO'D/	REQUIRED
D.F.	DOUGLAS FIR	RGS.	RIGID GALVANIZED STEEL
DIA.	DIAMETER	SCH.	SCHEDULE
DIAG.	DIAGONAL	SHT.	
			SHEET
DIM.	DIMENSION	SIM.	SIMILAR
DWG.	DRAWING(S)	SPEC.	SPECIFICATIONS
DWL.	DOWEL(S)	SQ.	SQUARE
EA.	EACH	s.s.	STAINLESS STEEL
EL.	ELEVATION	STD.	STANDARD
ELEC.	ELECTRICAL	STL.	STEEL
ELEV.	ELEVATOR	STRUC	STRUCTURAL
EMT.	ELECTRICAL METALLIC TUBING	TEMP.	TEMPORARY
E.N.	EDGE NAIL	THK.	THICK(NESS)
ENG.	ENGINEER	T.N.	TOE NAIL
EQ.	EQUAL	T.O.A.	TOP OF ANTENNA
EXP.	EXPANSION	T.O.C.	TOP OF CURB
EXST.(E)	EXISTING	T.O.F.	TOP OF FOUNDATION
EXT.	EXTERIOR	T.O.P.	TOP OF PLATE (PARAPET)
FAB.	FABRICATION(OR)	T.O.S.	TOP OF STEEL
F.F.	FINISH FLOOR	T.O.W.	TOP OF WALL
F.G.	FINISH GRADE	TYP.	TYPICAL
FIN.	FINISH(ED)	U.G.	UNDER GROUND
FLR.	FLOOR	U.L.	UNDERWRITERS LABORATORY
FDN.	FOUNDATION	U.N.O.	UNLESS NOTED OTHERWISE
F.O.C.	FACE OF CONCRETE	V.I.F.	VERIFY IN FIELD
F.O.M.	FACE OF MASONRY	W	WIDE (WIDTH)
F.O.S.	FACE OF STUD	w/	WITH
F.O.W.	FACE OF WALL	WD.	WOOD
F.S.	FINISH SURFACE	W.P.	WEATHERPROOF
FT.(')	FOOT (FEET)	WT.	WEIGHT
FTG.	FOOTING	Ç	CENTERLINE
G.	GROWTH (CABINET)	<u> </u>	PLATE, PROPERTY LINE
GA.	GAUGE	l	· writing record letter lattle
GI.	GALVANIZE(D)		
G.F.I.	GROUND FAULT CIRCUIT INTERRUPTER		
GLB. (GLU-LAM)	GLUE LAMINATED BEAM		
GPS	GLOBAL POSITIONING SYSTEM		
GRND.	GROUND		
HDR.	HEADER		
HGR.	HANGER		
HT.	HEIGHT		

SYMBOLS LEGEND

ICGB.

ISOLATED COPPER GROUND BUS

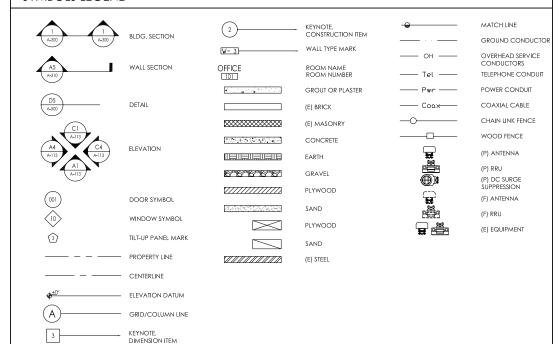

PREPARED FOR



San Ramon, California 94583




Jeffrey Rome | ASSOCIATES

131 Innovation Drive; Suite 100 Irvine, California 92617 tel 949.760.3929 | fax 949.760.3931

AT&T Site ID

CCL04008

AT&T FA NO: 10148902 JRA PROJECT NO: 174457 DRAWN BY: ΑU CHECKED BY: RN

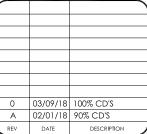

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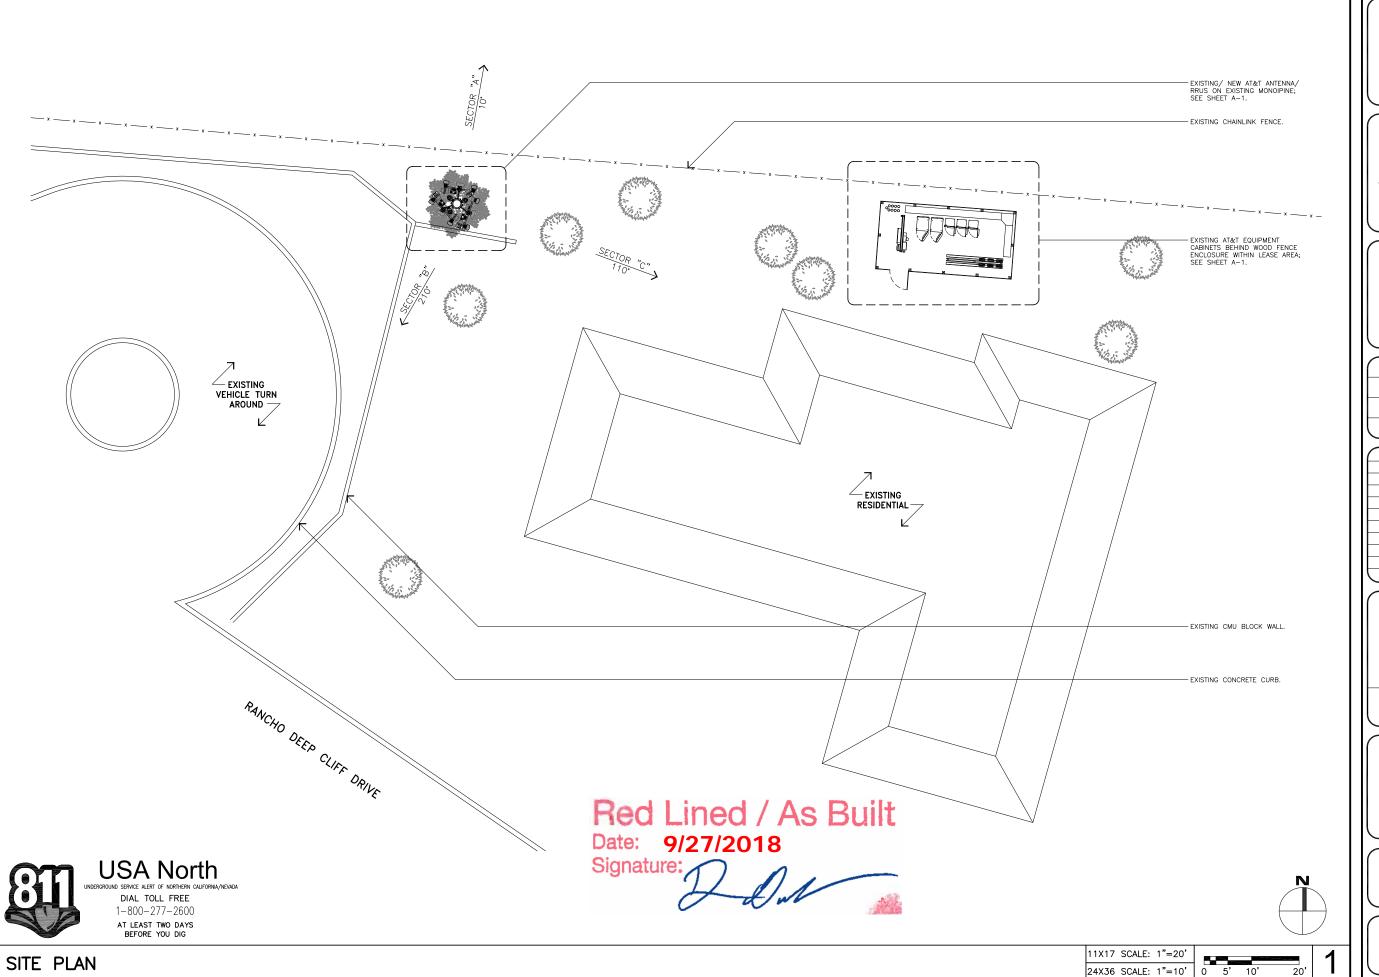
Issued For:

RANCHO DEEP CLIFF

22475 RANCHO DEEP CLIFF DRIVE, CUPERTINO CALIFORNIA 94066

GENERAL NOTES, ABBREVIATIONS & SYMBOLS

SHEET NUMBER





5001 Executive Parkway San Ramon, California 94583

Jra

Jeffrey Rome | ASSOCIATES

architecture | telecommunications 131 Innovation Drive; Suite 100 Irvine, California 92617 tel 949.760.3929 | fax 949.760.3931

AT&T Site ID:


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RANCHO DEEP CLIFF


22475 RANCHO DEEP CLIFF DRIVE, CUPERTINO CALIFORNIA 94066

SHEET TI

SITE PLAN

SHEET NUMBER:

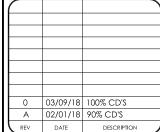A-0

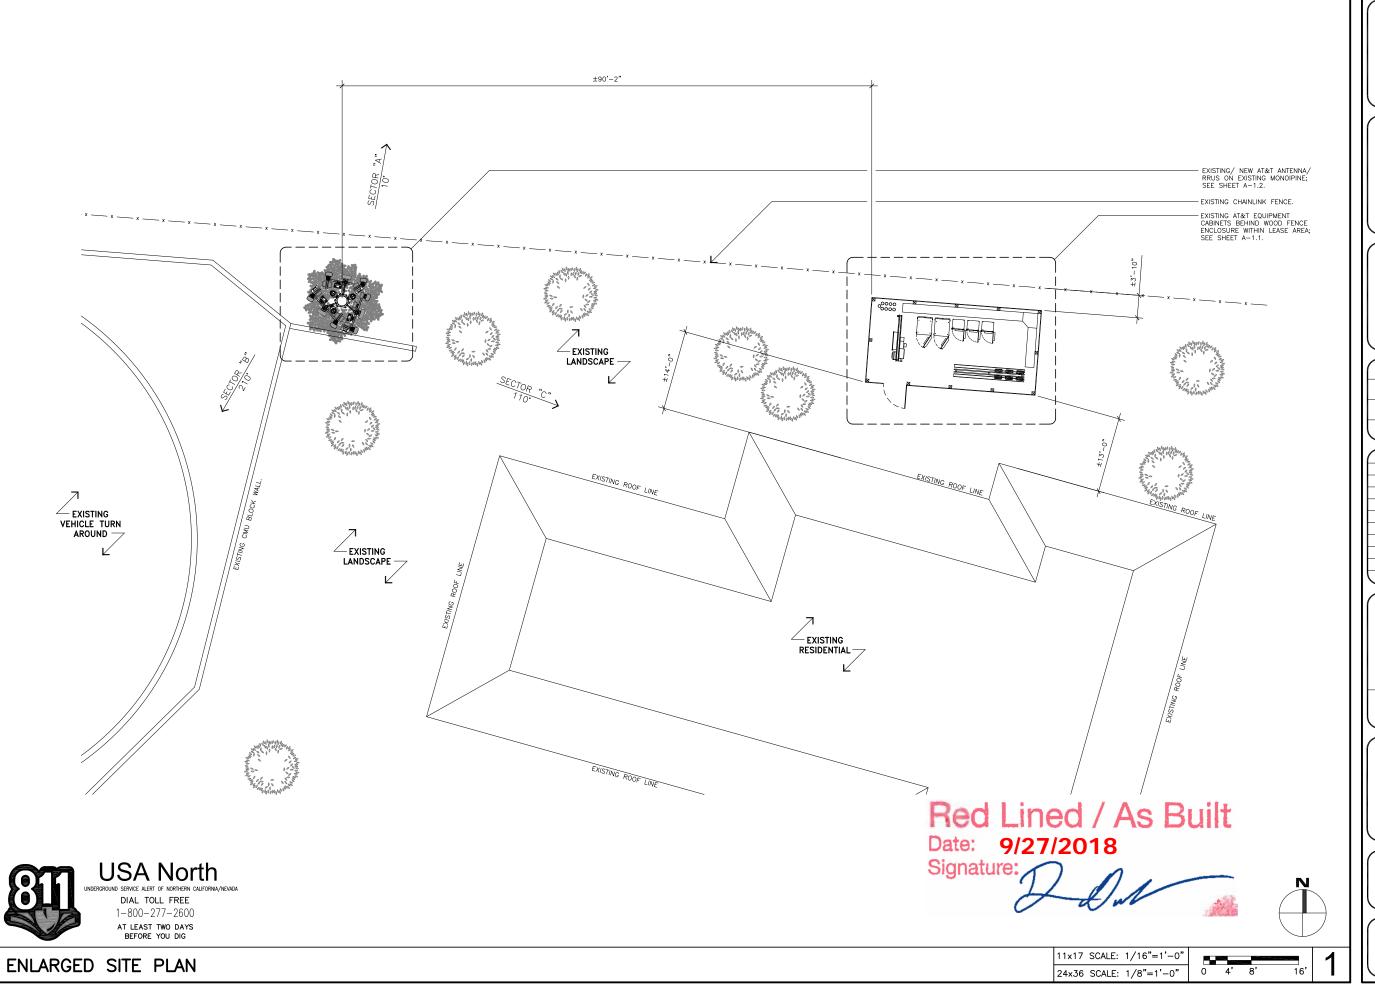



5001 Executive Parkway San Ramon, California 94583

Vendo



Jeffrey Rome | ASSOCIATES

131 Innovation Drive; Suite 100 Irvine, California 92617 tel 949.760.3929 | fax 949.760.3931

AT&T Site IE

CCL04008

	AT&T FA NO: 1	0148902
	JRA PROJECT NO:	174457
	DRAWN BY:	AU
	CHECKED BY:	RN

0	03/09/18	100% CD'S
Α	02/01/18	90% CD'S
REV	DATE	DESCRIPTION

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RANCHO DEEP CLIFF


22475 RANCHO DEEP CLIFF DRIVE, CUPERTINO CALIFORNIA 94066


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ENLARGED SITE PLAN

SHEET NUMBER:

A-1



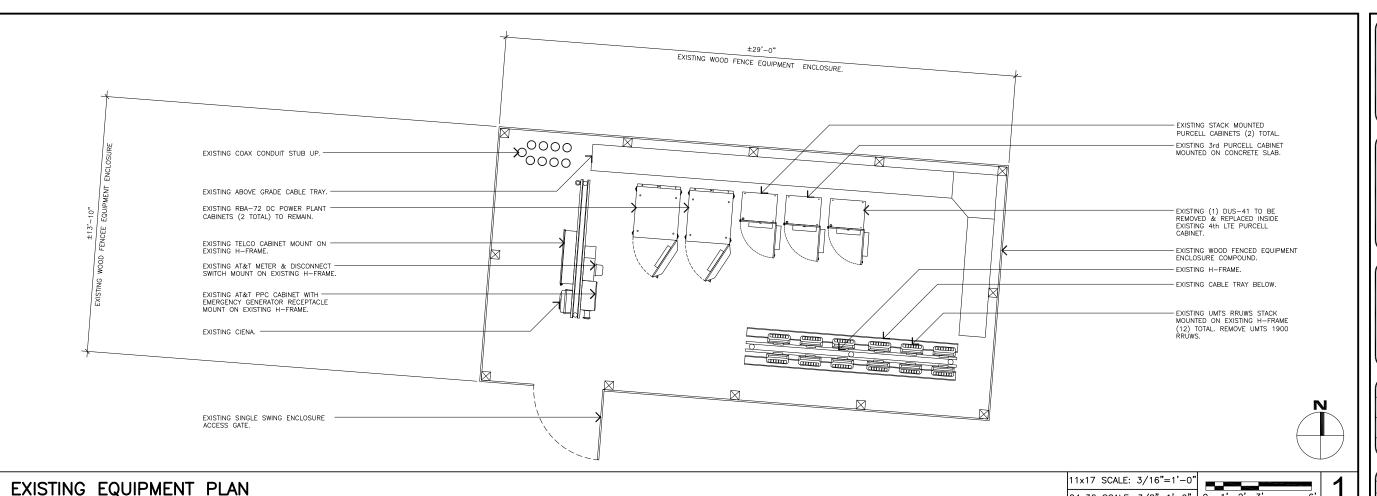

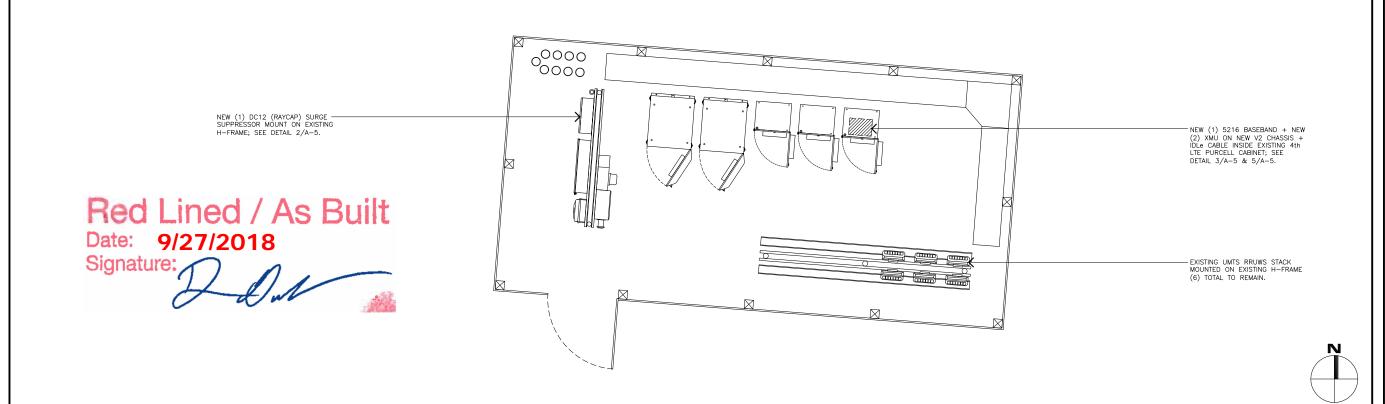NEW EQUIPMENT PLAN

PREPARED FOR San Ramon, California 94583




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RANCHO DEEP CLIFF

22475 RANCHO DEEP CLIFF DRIVE, CUPERTINO CALIFORNIA 94066

EXISTING AND (N)
EQUIPMENT PLAN

SHEET NUMBER

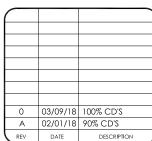24x36 SCALE: 3/8"=1'-0"


24x36 SCALE: 3/8"=1'-0" 0 1' 2' 3'

EXISTING ANTENNA SCHEDULE

EXISTING ANTENNA PLAN


SECTOR ANTENNA	CARRIER TECHNOLOGY	AZII	MUTH	RAD CENTER	ANTENNA MODEL NO.	TMA	RRU MODEL NO.	SURGE SUPPRESSOR	CABLE SIZE/TYPE	LENGTH (±5')
A1	LTE 1C/2C	1	0,	47'-0"	SBNH-1D6565B		(1) 1C RRUS-11 B12 (700)/(1) 2C RRUS-12 B2 (1900)		(E) FIBER	145'
A2	UMTS 1900	1	0,	47'-0"	P65-15-XLH-RR	(6)		(1) (E) DC6 SQUID SURGE	(E) COAX	145'
A3	UMTS 850/1900	1	0.	47'-0"	P65−1 / =XLH−RR			SUPPRESSOR	(E) COAX	145'
		1			•			AT ANTENNA		
B1	LTE 1C/2C	2	1 b°	47'-0"	SBNH-1D6565B		(1) 1C RRUS-11 B12 (700)/(1) 2C RRUS-12 B2 (1900)	LEVEL	(E) FIBER	145'
B2	UMTS 1900	2	O.	47'-0"	P65-15-XLH-RR	(6)			(E) COAX	145'
В3	UMTS 850/1900	2	1 þ.	47'-0"	P65−1 <mark>∦</mark> ∈XLH−RR			(1) (E) DC12 SURGE	(E) COAX	145'
			1		•			SUPPRESSOR		
C1	LTE 1C/2C	1	10	47'-0"	SBNH-1D6565B		(1) 1C RRUS-11 B12 (700)/(1) 2C RRUS-12 B2 (1900)	AT	(E) FIBER	145'
C2	UMTS 1900	1	10'	47'-0"	P65-15-XLH-RR	(6)		EQUIPMENT LEVEL	(E) COAX	145'
C3	UMTS 850/1900	1	10°	47'-0"	P65−1 <mark>#</mark> 6XLH−RR				(E) COAX	145'

* SEE BELOW FOR PRE AZ

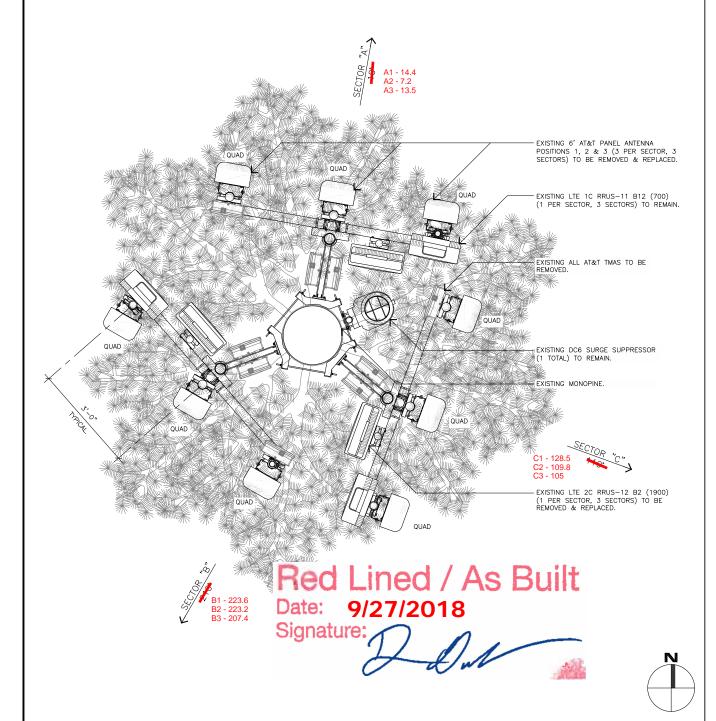

NEW ANTENNA SCHEDULE

SECTOR ANTENNA	CARRIER TECHNOLOGY	AZIMUTH	RAD CENTER	ANTENNA MODEL NO.	TMA	RRU MODEL NO.	SURGE SUPPRESSOR	CABLE SIZE/TYPE	LENGTH (±5')
A1	LTE 1C/2C	10*	47'-0"	JAHH-65B-R3B-V3		(1) 1C RRUS-11 B12 (700)/(1) 2C RRUS-32 B2 (1900)		(E) FIBER	145'
A2	LTE 5C/3C	10°	47'-0"	NNHH4-65B-R4	(0)	(1) 5C RRUS-4478 B14 (700)/ (1) 3C RRUS-32 B30 (WCS)	(1) (E) +	(N) FIBER	164
A3	UMTS 850/LTE 4C	10°	47'-0"	JAHH-65B-R3B-V3]	(1) 4C RRUS-32 B66 (AWS)	(2) NEW DC6 SQUID SURGE	(E) COAX/ (N) FIBER	145'
							SUPPRESSOR		
B1	LTE 1C/2C	210°	47'-0"	JAHH-65B-R3B-V3		(1) 1C RRUS-11 B12 (700)/(1) 2C RRUS-32 B2 (1900)	AT ANTENNA LEVEL	(E) FIBER	145'
B2	LTE 5C/3C	210°	47'-0"	NNHH4-65B-R4	(0)	(1) 5C RRUS-4478 B14 (700)/ (1) 3C RRUS-32 B30 (WCS)		(N) FIBER	164
В3	UMTS 850/LTE 4C	210°	47'-0"	JAHH-65B-R3B-V3		(1) 4C RRUS-32 B66 (AWS)	(1) (E) +	(E) COAX/ (N) FIBER	145'
							(1) NEW DC12 SURGE		
C1	LTE 1C/2C	110°	47'-0"	JAHH-65B-R3B-V3		(1) 1C RRUS-11 B12 (700)/(1) 2C RRUS-32 B2 (1900)	SUPPRESSOR	(E) FIBER	145'
C2	LTE 5C/3C	110*	47'-0"	NNHH4-65B-R4	(0)	(1) 5C RRUS-4478 B14 (700)/ (1) 3C RRUS-32 B30 (WCS)	AT EQUIPMENT	(N) FIBER	164'
С3	UMTS 850/LTE 4C	110°	47'-0"	JAHH-65B-R3B-V3		(1) 4C RRUS-32 B66 (AWS)	LEVEL	(E) COAX/ (N) FIBER	145'

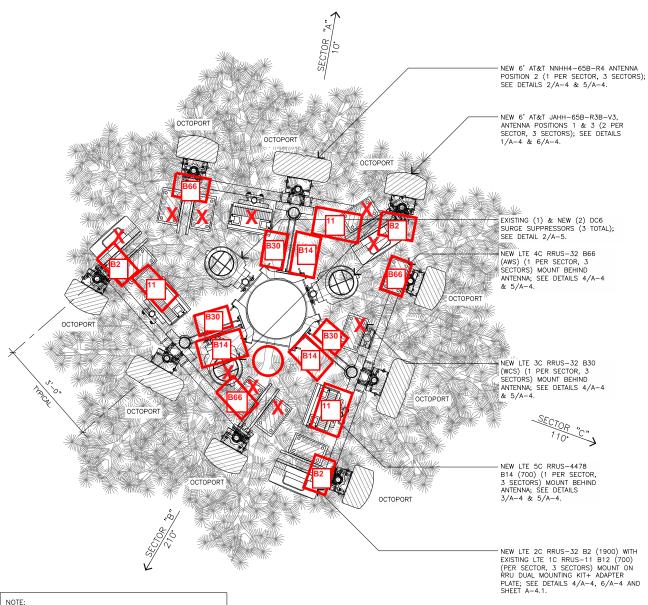

- INSTALL NEW FIBER & DC POWER TRUNKS PER SECTOR, 3 SECTORS ON 2" INNER DUCTS, RUN ON
- SECTOR, 3 SECTORS ON 2 INNER DUCTS, RUN ON (E) CONDUIT RUNS.
 INSTALL PINE SOCK NEEDLES & PAINT/ TEXTURE NEW ANTENNAS/ RRUS TO MATCH PINE NEEDLE COLOR. INSTALL ADDITIONAL RRU DUAL MOUNT KIT (SXK1250245/1 + ADAPTER PLATE (SXK1072892) BY ERICSSON WHERE REQUIRED; SEE SHEET A-4.1.

11x17 SCALE: 3/8"=1'-0"

24x36 SCALE: 3/4"=1'-0" 0 .5' 1'

PREPARED FOR



San Ramon, California 94583



Jeffrey Rome | ASSOCIATES

131 Innovation Drive; Suite 100 Irvine, California 92617 tel 949.760.3929 | fax 949.760.3931

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AT&T FA NO: 10148902 JRA PROJECT NO: 174457 DRAWN BY: CHECKED BY: RN

0 03/09/18 100% CD'S A 02/01/18 90% CD'S DATE REV

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OF A LICENSED PROFESSIONAL ENGINEER, TO
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RANCHO DEEP CLIFF

22475 RANCHO DEEP CLIFF DRIVE, CUPERTINO CALIFORNIA 94066


EXISTING AND NEW ANTENNA PLAN

SHEET NUMBER:

11x17 SCALE: 3/8"=1'-0" 24x36 SCALE: 3/4"=1'-0" 0 .5' 1'

2'

NEW ANTENNA PLAN

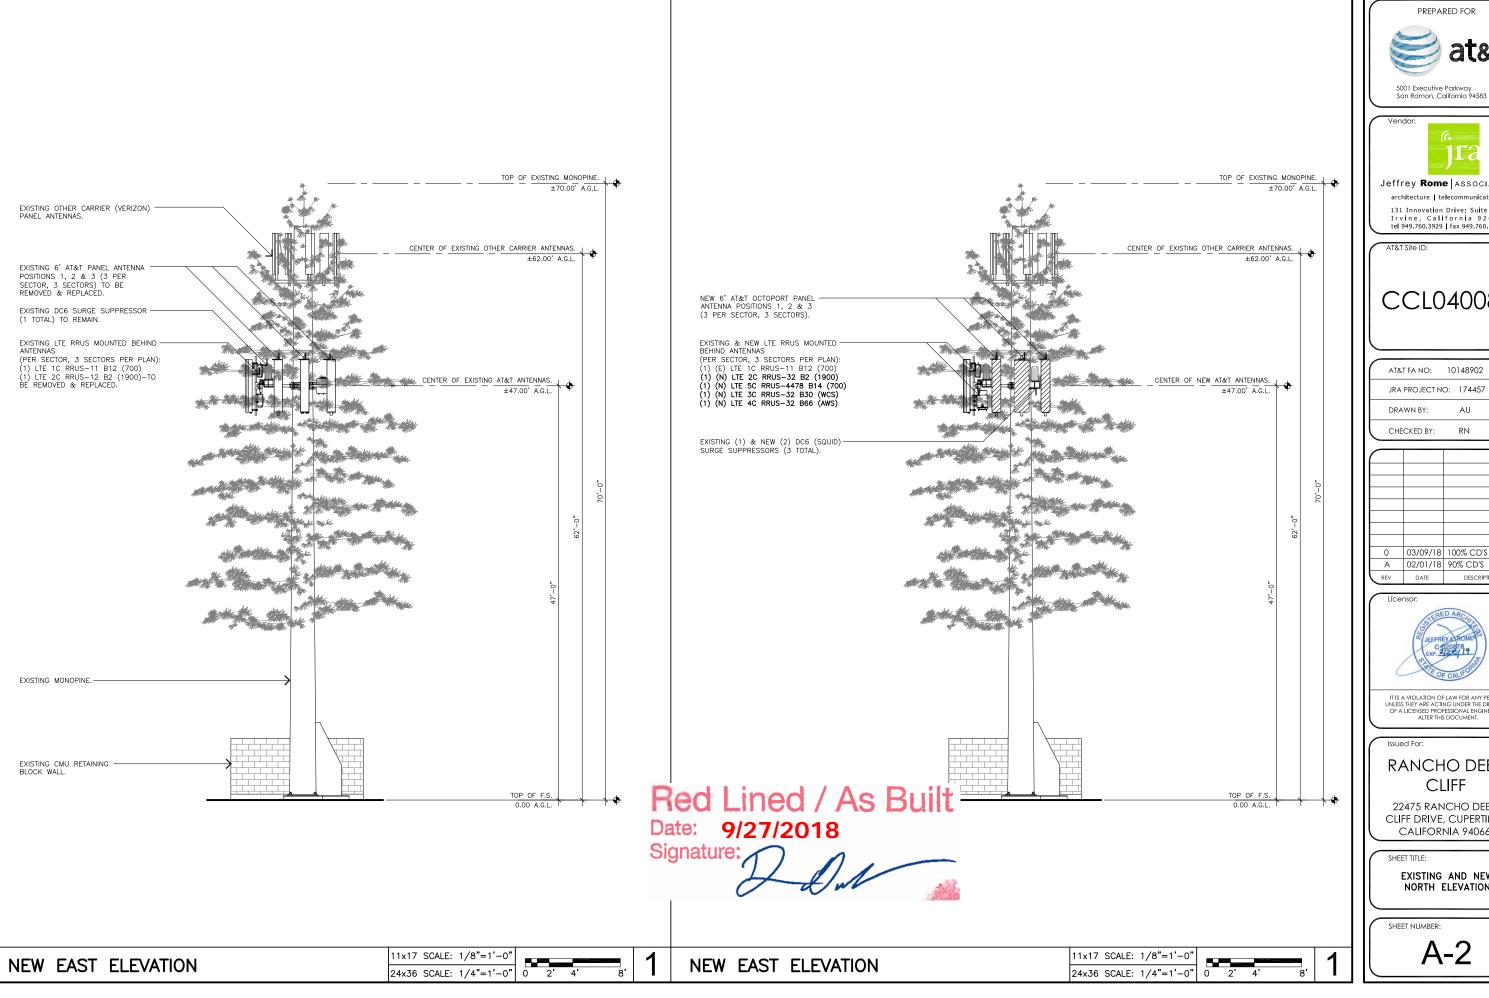




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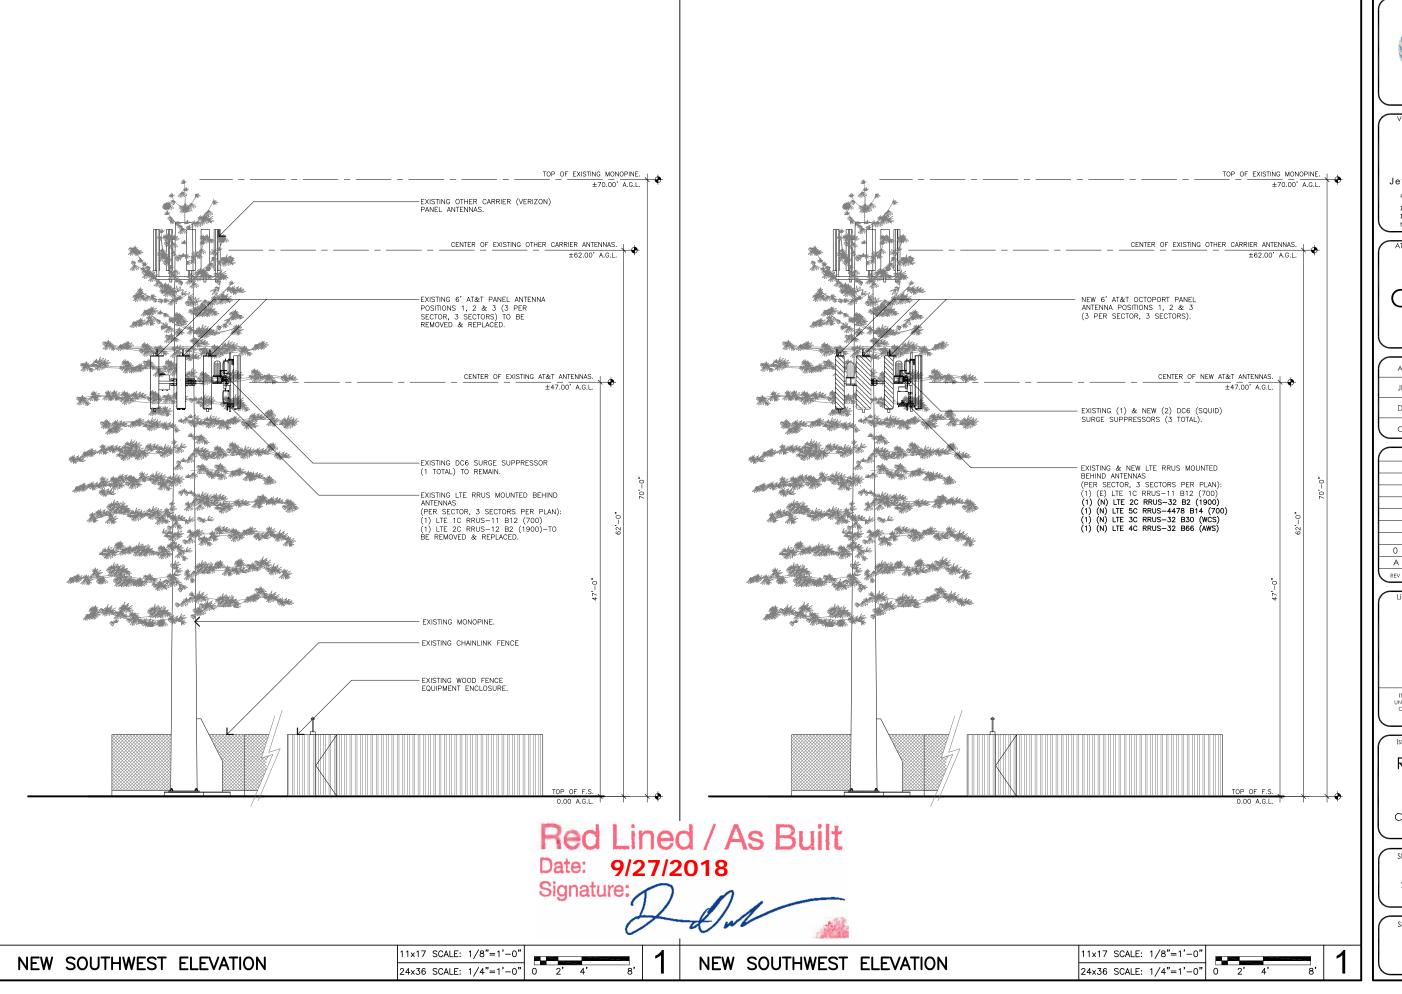
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EXISTING AND NEW NORTH ELEVATION

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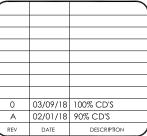
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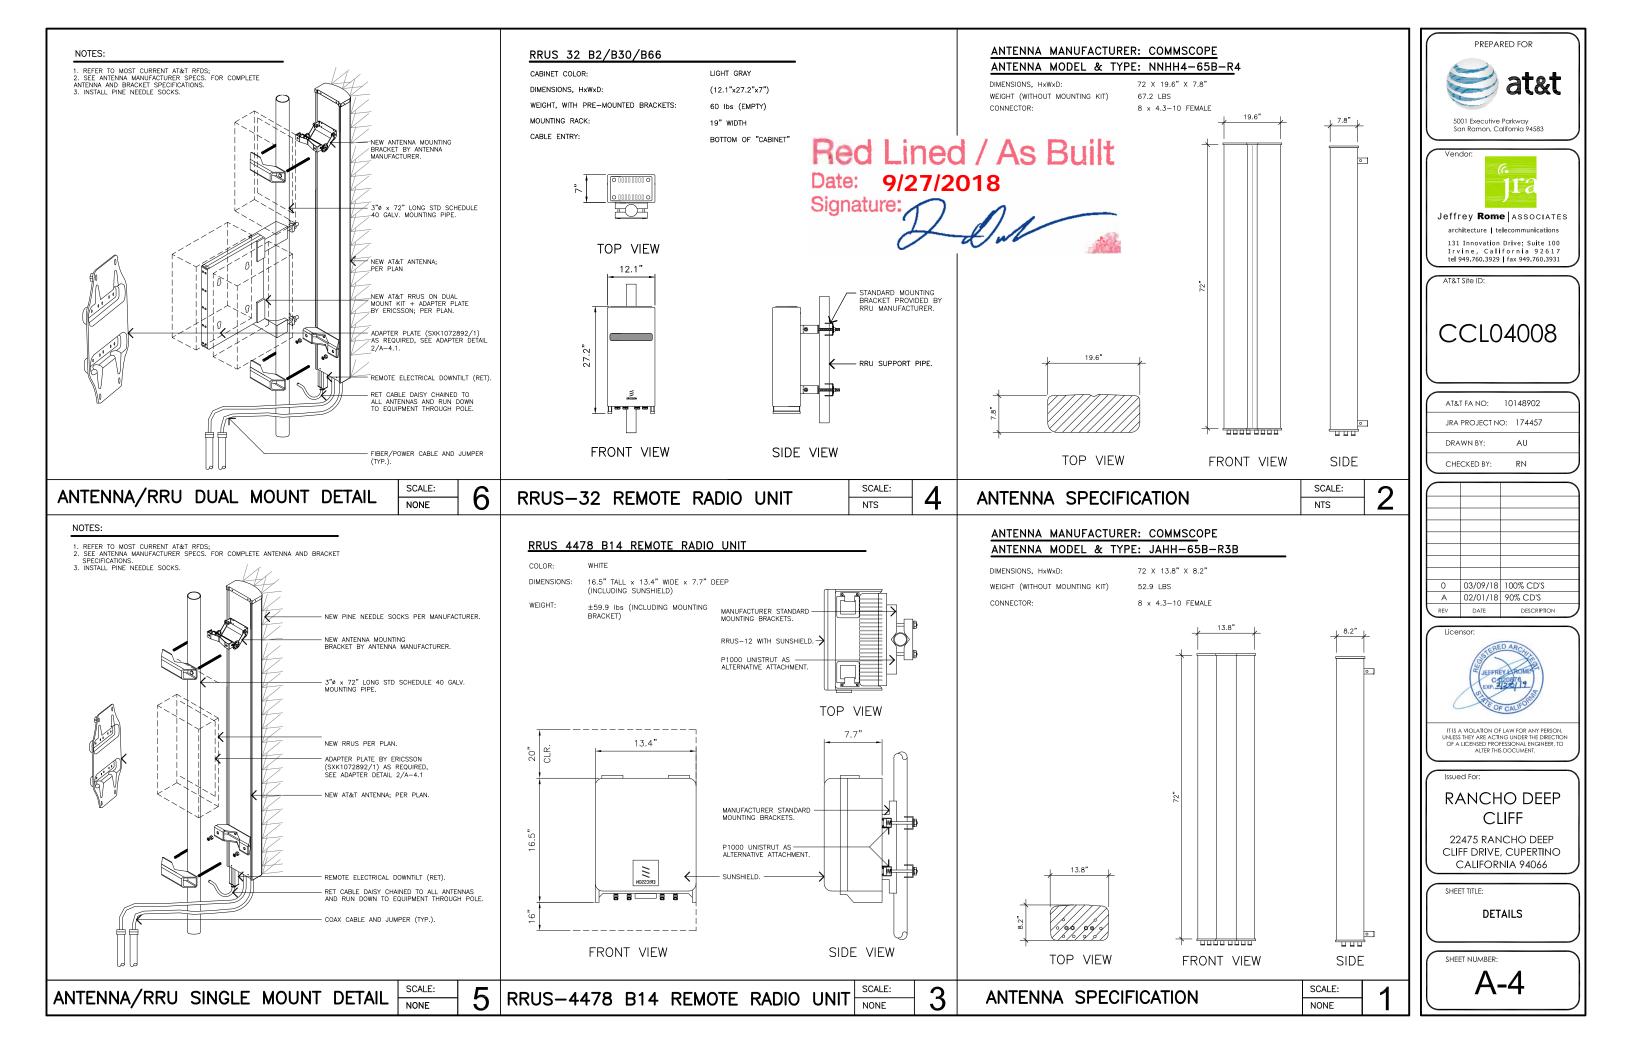
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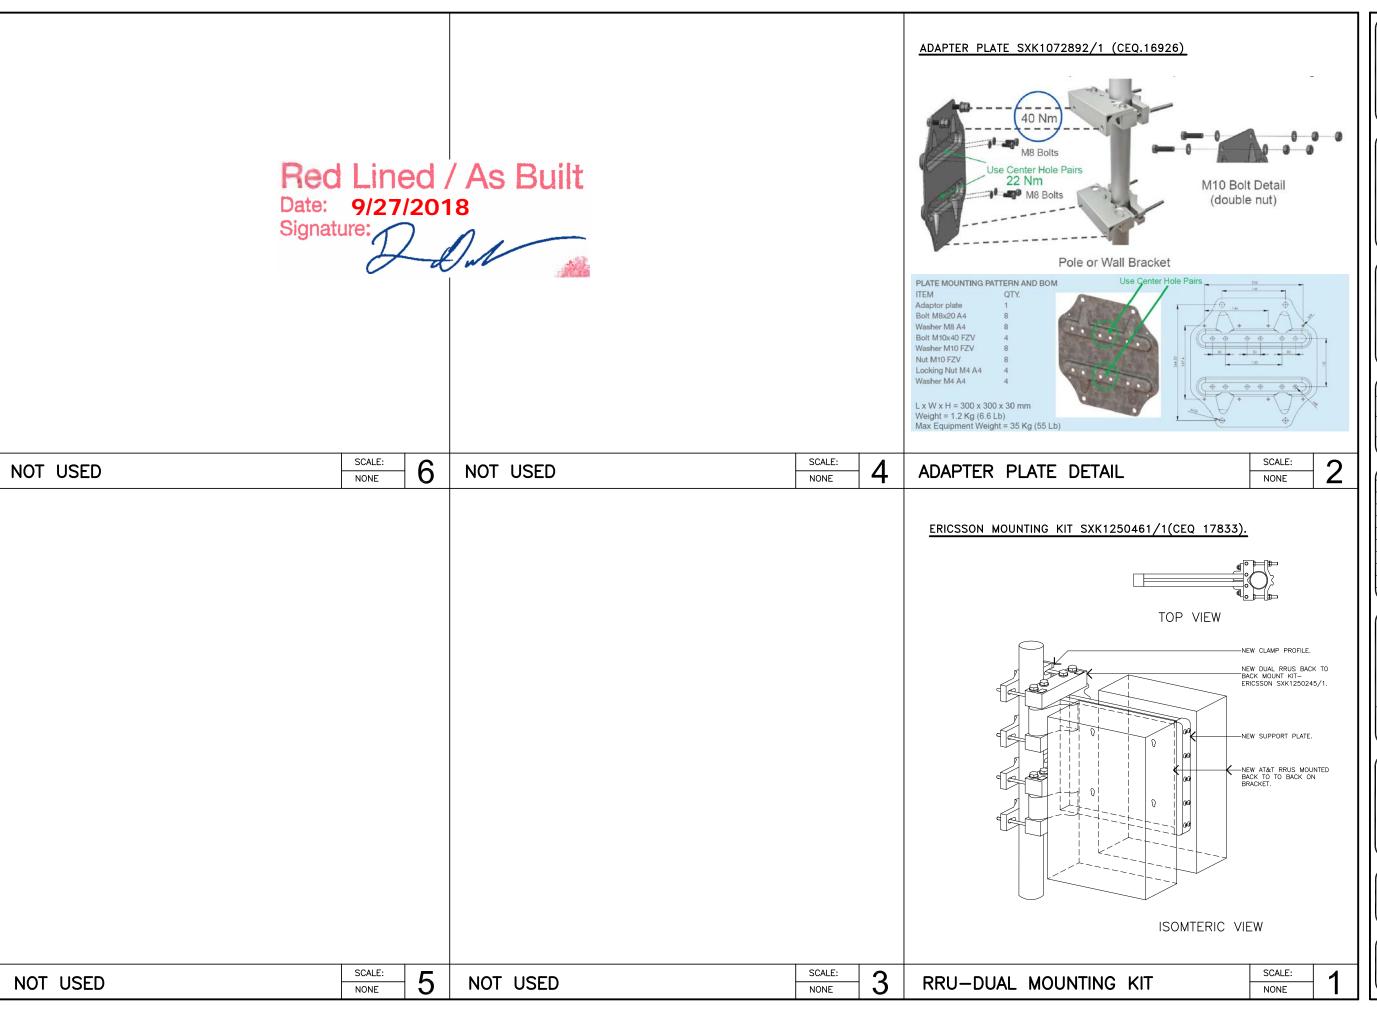
SHEET TITLE

EXISTING AND NEW SOUTHWEST ELEVATION

SHEET NUMBER:

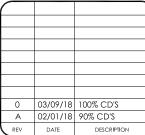A-3









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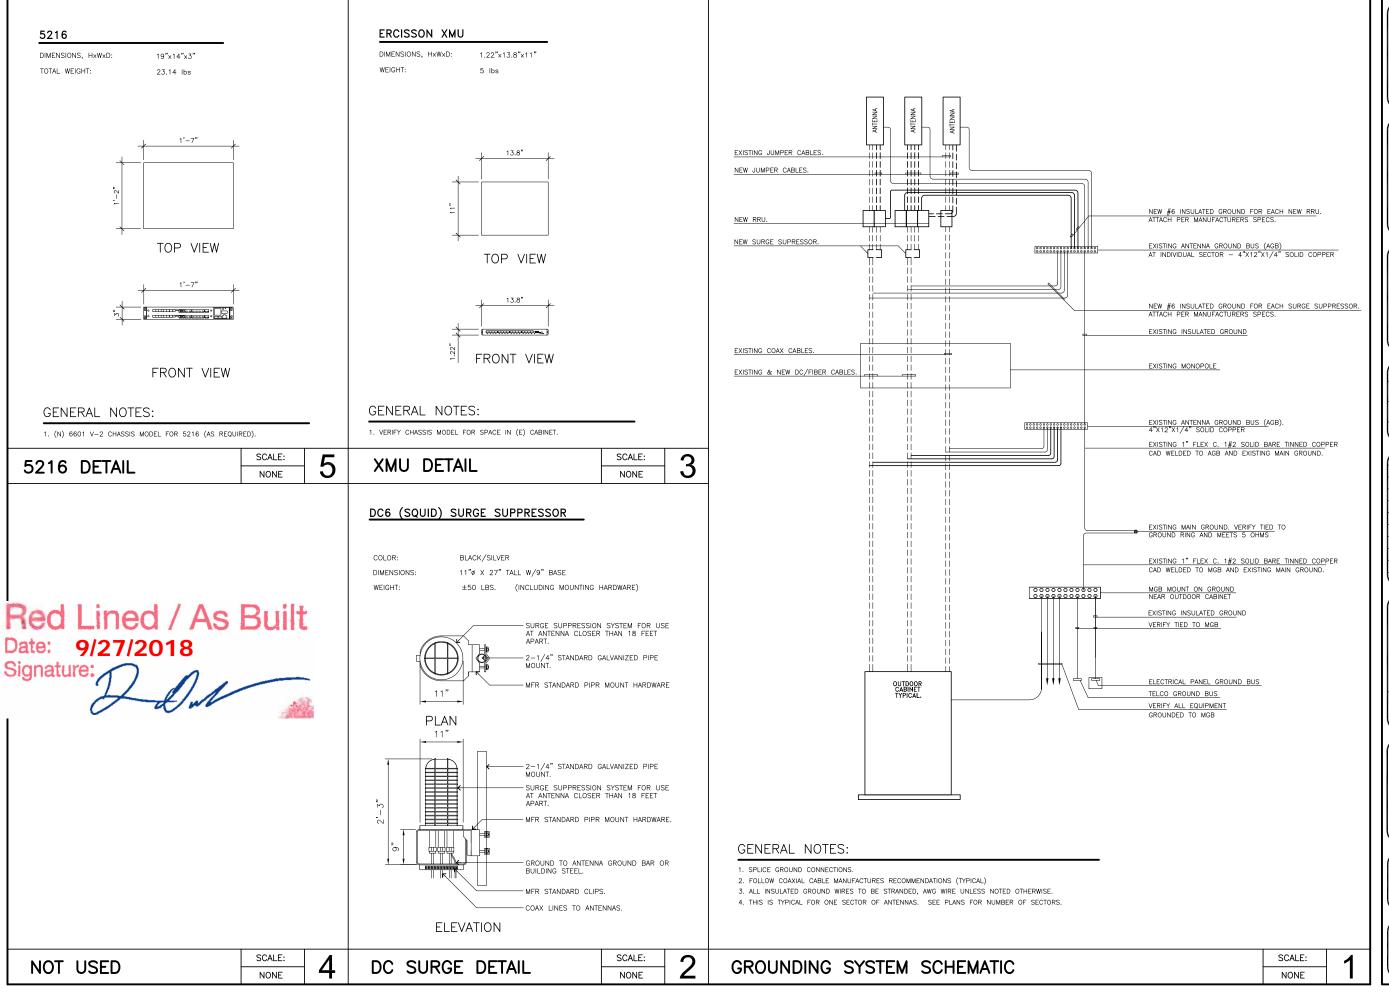
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SHEET TITLE

DETAILS

SHEET NUMBER:

A-4.1



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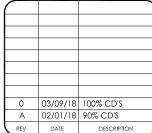
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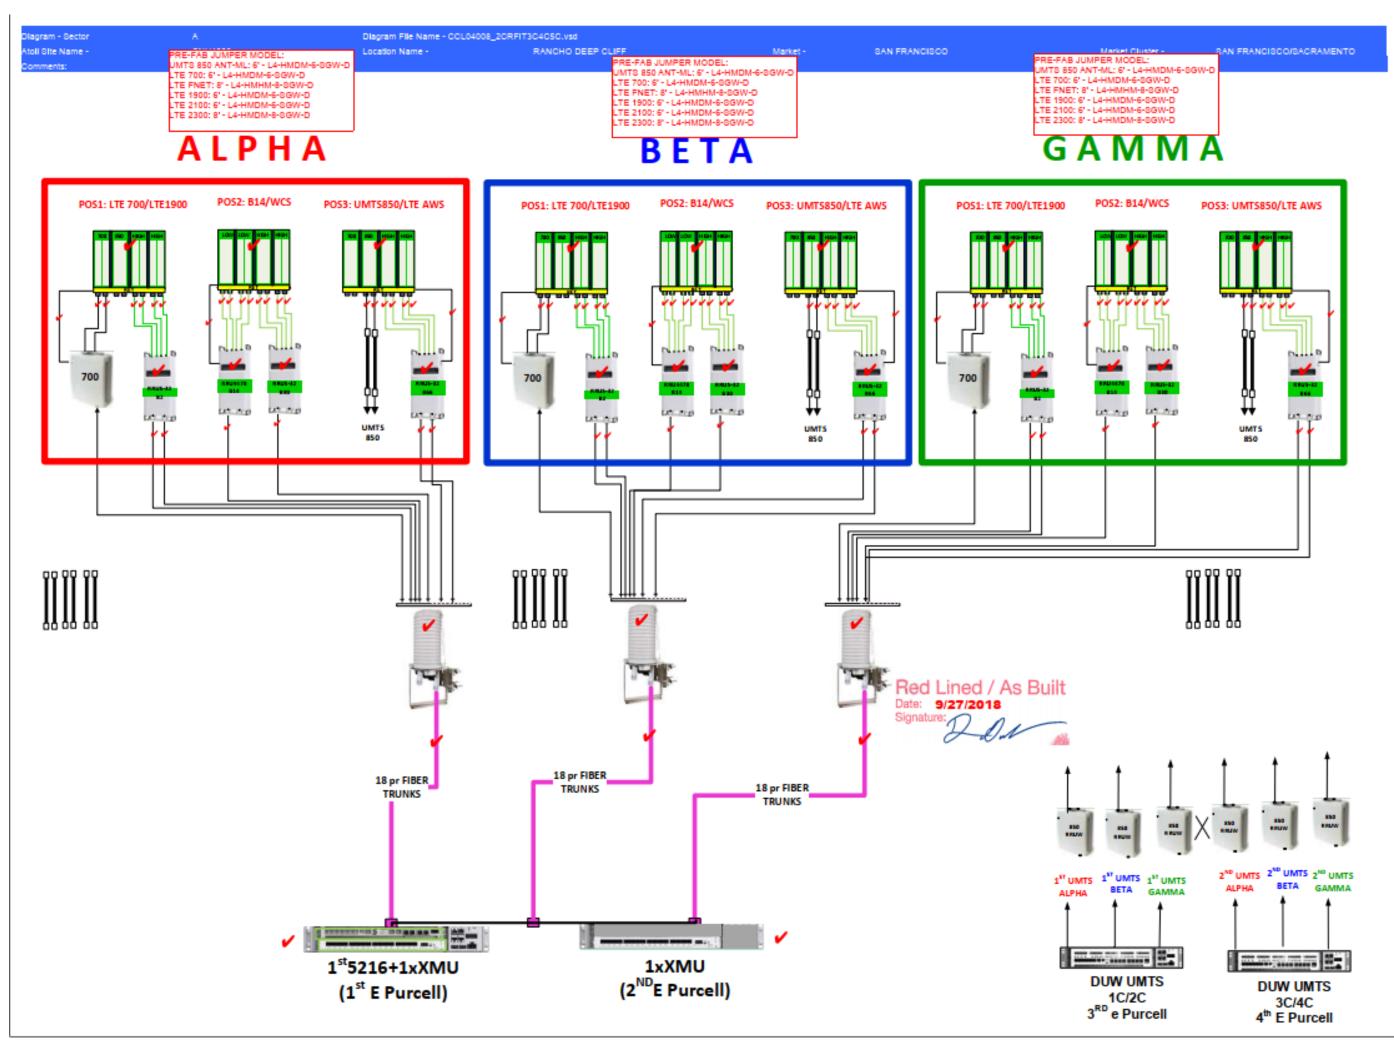
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SHEET TITLE:

DETAILS

SHEET NUMBER:





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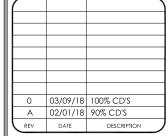
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RF DIAGRAM

SHEET NUMBER:

RF-1